

# ANOKA COUNTY, MN

## CONSTRUCTION PLANS FOR AMBASSADOR BOULEVARD IMPROVEMENTS. BITUMINOUS RIGHT TURN LANE, GRAVEL SHOULDERS, DITCH GRADING AND STORM SEWER CULVERT

LOCATED ON CSAH 28/AMBASSADOR BLVD. FROM 233RD LANE NW TO ZEA STREET NW

GROSS LENGTH 873.26 FEET 0.165 MILES  
BRIDGES-LENGTH NA FEET NA MILES  
EXCEPTIONS-LENGTH NA FEET NA MILES  
NET LENGTH 873.26 FEET 0.165 MILES

### GOVERNING SPECIFICATIONS

THE 2018 EDITION OF THE MINNESOTA DEPARTMENT OF TRANSPORTATION "STANDARD SPECIFICATIONS FOR CONSTRUCTION" SHALL GOVERN.

### TRAFFIC CONTROL

ALL TRAFFIC CONTROL DEVICES SHALL CONFORM TO THE MOST RECENT EDITION OF THE MINNESOTA MANUAL ON UNIFORM TRAFFIC CONTROL DEVICES, INCLUDING "FIELD MANUAL FOR TEMPORARY TRAFFIC CONTROL ZONE LAYOUTS."

SHEET INDEX	
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C7.01	SIGNING AND STRIPING PLAN
C7.02	TRAFFIC CONTROL PLAN
C8.01	CROSS SECTIONS
C8.02	CROSS SECTIONS


PLAN SYMBOLS			
● FOUND MONUMENT	— — WATERMAIN	--- EASEMENT LINE	
○ SET MONUMENT MARKED LS 47481	— — SANITARY SEWER	--- SETBACK LINE	
⊠ ELECTRIC METER	— — STORM SEWER	--- RESTRICTED ACCESS	
☆ LIGHT	— — FLARED END SECTION	/// CONCRETE CURB	
⊠ AIR CONDITIONER	— — ELECTRIC TRANSFORMER	--- BUILDING LINE	
← GUY ANCHOR	— — TELEPHONE PEDESTAL	--- BUILDING CANOPY	
♿ HANDICAP STALL	— — GAS METER	--- BITUMINOUS SURFACE	
⊠ UTILITY POLE	— — OVERHEAD WIRE	--- CONCRETE SURFACE	
● POST	— — CHAIN LINK FENCE	--- LANDSCAPE SURFACE	
⊠ SIGN	— — IRON FENCE	○ DECIDUOUS TREE	
	— — WIRE FENCE	○ CONIFEROUS TREE	
	— — WOOD FENCE		

### BENCHMARKS

THE SITE ELEVATIONS ARE BASED ON NAVD88:

BM #1 - TNH IN NORTH R.O.W OF AZTEC ST. NW WHICH HAS AN ELEVATION OF 920.64 FEET



BM #2 - TNH IN SOUTH R.O.W. OF ZEA ST. NW WHICH HAS AN ELEVATION OF: 918.45 FEET

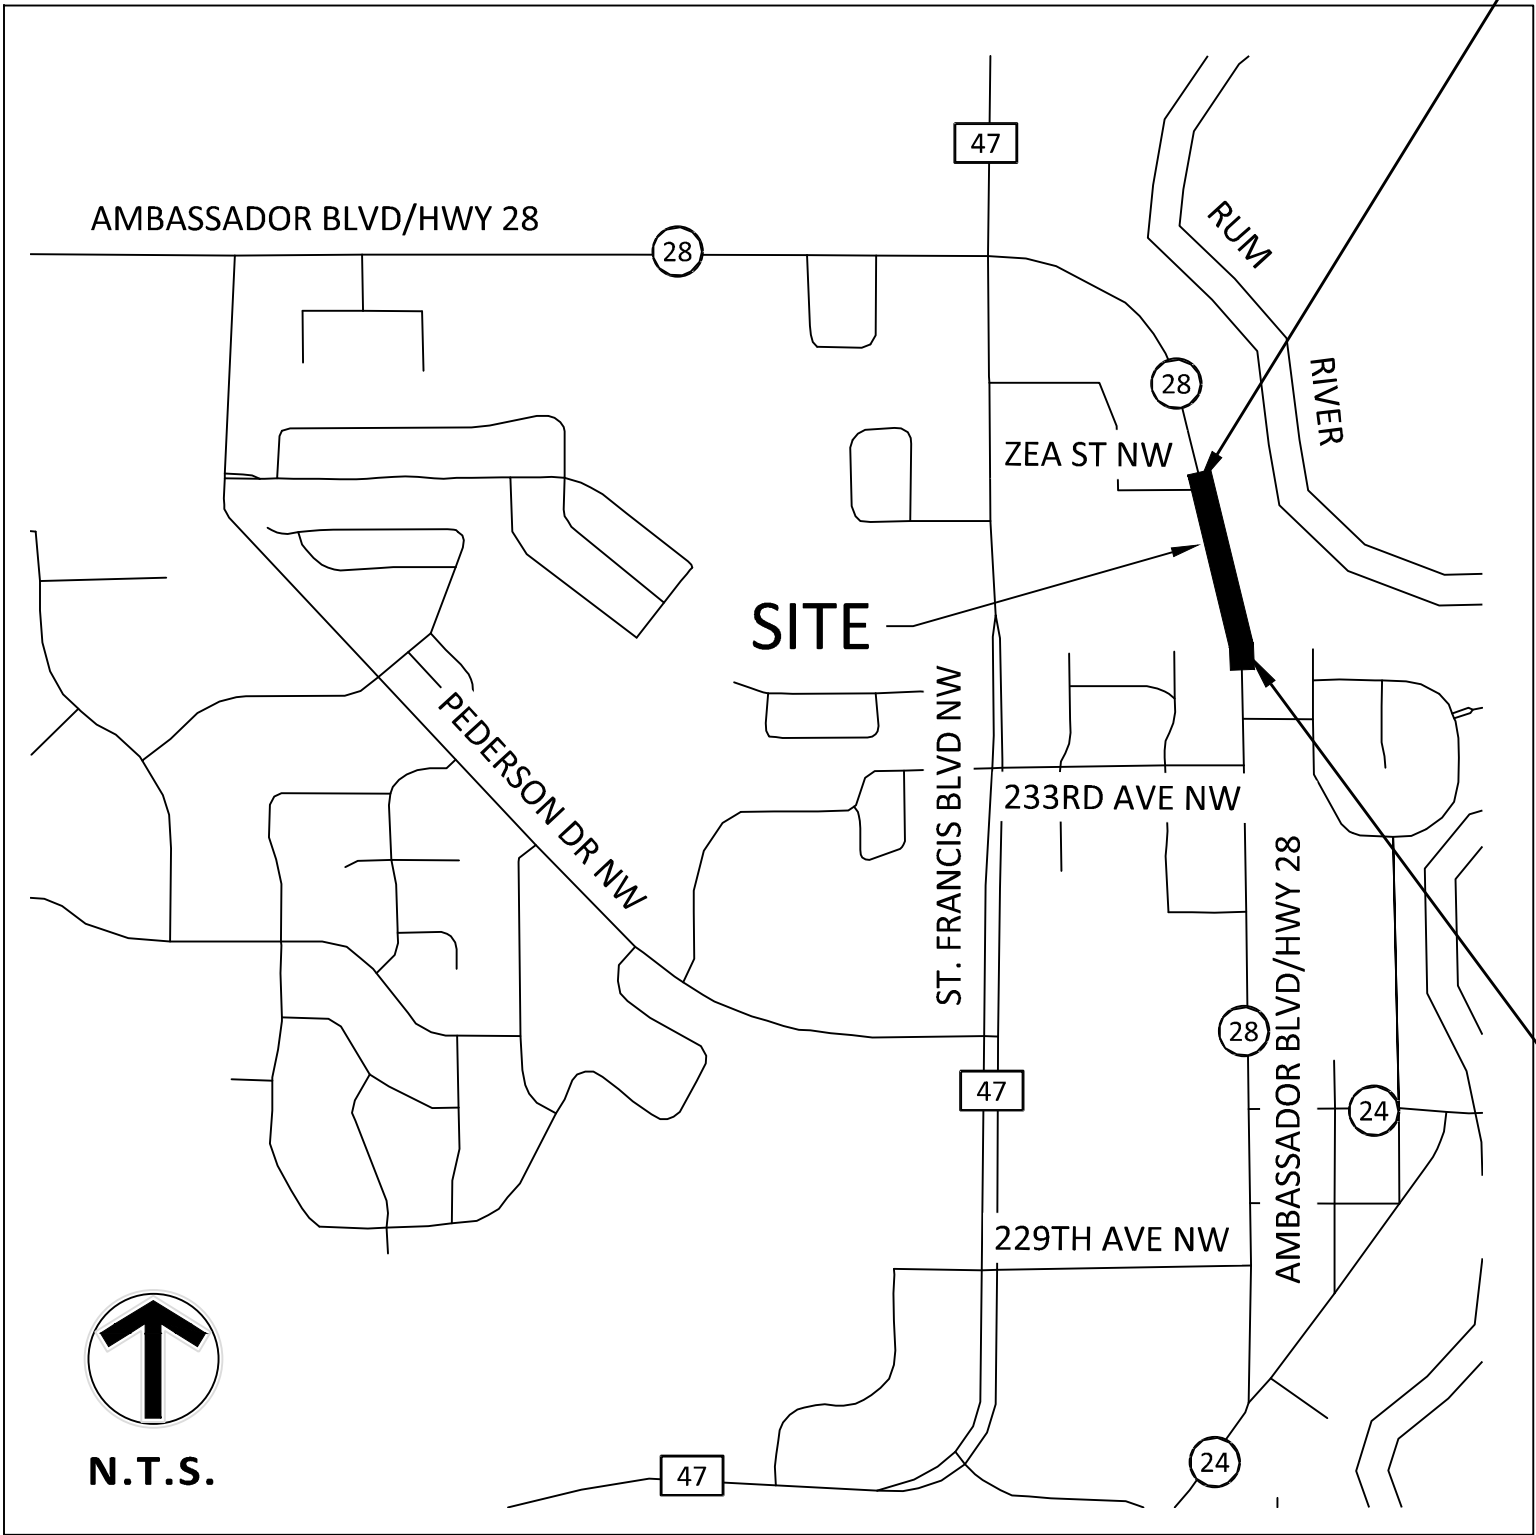

VICINITY MAP  
NO SCALE

PLAN  
PROFILE  
INDEX MAP

### SCALES

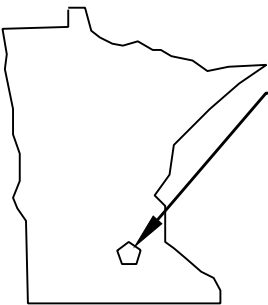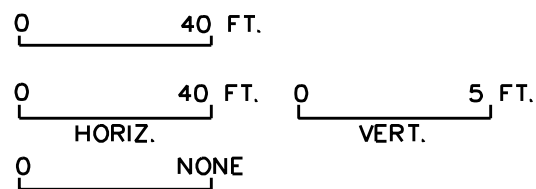

PROJECT LOCATION  
COUNTY : ANOKA  
DISTRICT : METRO

THE SUBSURFACE UTILITY INFORMATION SHOWN ON THESE PLANS IS A UTILITY QUALITY LEVEL D. THIS QUALITY LEVEL WAS DETERMINED ACCORDING TO THE GUIDELINES OF ASCE/CI 38-02, TITLED "STANDARD GUIDELINES FOR THE COLLECTION AND DEPICTION OF EXISTING SUBSURFACE UTILITY DATA." THE CONTRACTOR AND/OR SUBCONTRACTORS SHALL DETERMINE THE EXACT LOCATION OF ALL EXISTING UTILITIES BEFORE COMMENCING WORK, BY CONTACTING THE NOTIFICATION CENTER (GOPHER STATE ONE FOR MINNESOTA). THE CONTRACTOR AND/OR SUBCONTRACTOR AGREE TO BE FULLY RESPONSIBLE FOR ANY AND ALL DAMAGES, WHICH MIGHT BE OCCASIONED BY HIS OR HER FAILURE TO EXACTLY LOCATE AND PRESERVE ANY AND ALL UTILITIES (UNDERGROUND AND OVERHEAD).

IF THE CONTRACTOR ENCOUNTERS ANY DRAIN TILE WITHIN THE SITE, HE OR SHE SHALL NOTIFY THE ENGINEER WITH THE LOCATION, SIZE, INVERT AND IF THE TILE LINE IS ACTIVE. NO ACTIVE DRAIN TILE SHALL BE BACKFILLED WITHOUT APPROVAL FROM THE PROJECT ENGINEER.

NO	DATE	BY	CKD	APPR	COMMENT

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I hereby certify that this plan, specification, or report was prepared by me or under my direct supervision and that I am a duly licensed Professional Engineer under the laws of the State of Minnesota.

Print Name: Michael Nielson  
*Michael Nielson*  
Date 08/29/2022 License # 23623

PRELIMINARY  
DESIGN REVIEW  
PERMIT SUBMITTAL  
CONSTRUCTION DOCUMENTS

DRAWN BY  
DJD  
DESIGNED BY  
JJG  
CHECKED BY  
MJN  
PROJECT NO.  
22377



### TITLE SHEET



Anoka County, MN  
Ambassador Blvd. Right Turn Lane  
St. Francis, MN

SHEET  
**C1.01**  
1 OF 11  
REV.

22.05 (LWS TECH) | DAVID DANZL | 8/29/2022 9:46:28 AM  
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STATEMENT OF ESTIMATED QUANTITIES

ITEM NO.	SHEET	MNDOT NO.	NOTES	BID ITEM	UNIT	TOTAL QUANTITY
1		2021.501		MOBILIZATION	LUMP SUM	1
2		2012.602		TRAFFIC CONTROL	LUMP SUM	1
3	2	2104.502		SALVAGE AND REINSTALL SIGN TYPE C	EACH	2
4		2104.503		SAWING BITUMINOUS PAVEMENT (FULL DEPTH)	LF	4.80
5	2	2104.503		REMOVE PIPE CULVERT	EA	1
6	7	2501.503		18" RC ARCH PIPE CULVERT DESIGN 3006 CL III	LF	76
7	7	2501.502		18" RC SAFETY APRON	EA	2
8		2232.504		MILL BITUMINOUS SURFACE (1.5")	SY	69
9	3	2106.507		COMMON EXCAVATION (CV)	CU YD	390
10	3	2112.604		SUBGRADE PREPARATION	SQ YD	390
11	3	2211.509		AGGREGATE BASE CLASS 5 (CV)	CY	167
12	3	2215.504		SELECT GRANULAR BORROW (CV)	CY	405
13		2221.507		SHOULDER BASE AGGREGATE (CV) CLASS X	CY	11
14	3	2357.506		BITUMINOUS MATERIAL FOR TACK COAT	GAL	80
15	3	2360.509		TYPE SP 9.5 WEARING COURSE MIXTURE (3,B)	TON	90
16	3	2360.509		TYPE SP 12.5 NON WEARING COURSE MIXTURE (3,B)	TON	120
17		2564.518		INSTALL SIGN PANEL TYPE C	EACH	8
18	4	2582.503		4" SOLID LINE MULTI-COMPONENT	LIN FT	978
19		2574.507		COMMON TOPSOIL BORROW	CU YD	310
20		2573.503		SEDIMENT CONTROL LOG TYPE COMPOST	LF	550
21		2575.508		SEED MIXTURE 25-141 (GENERAL ROADSIDE)	LBS	10

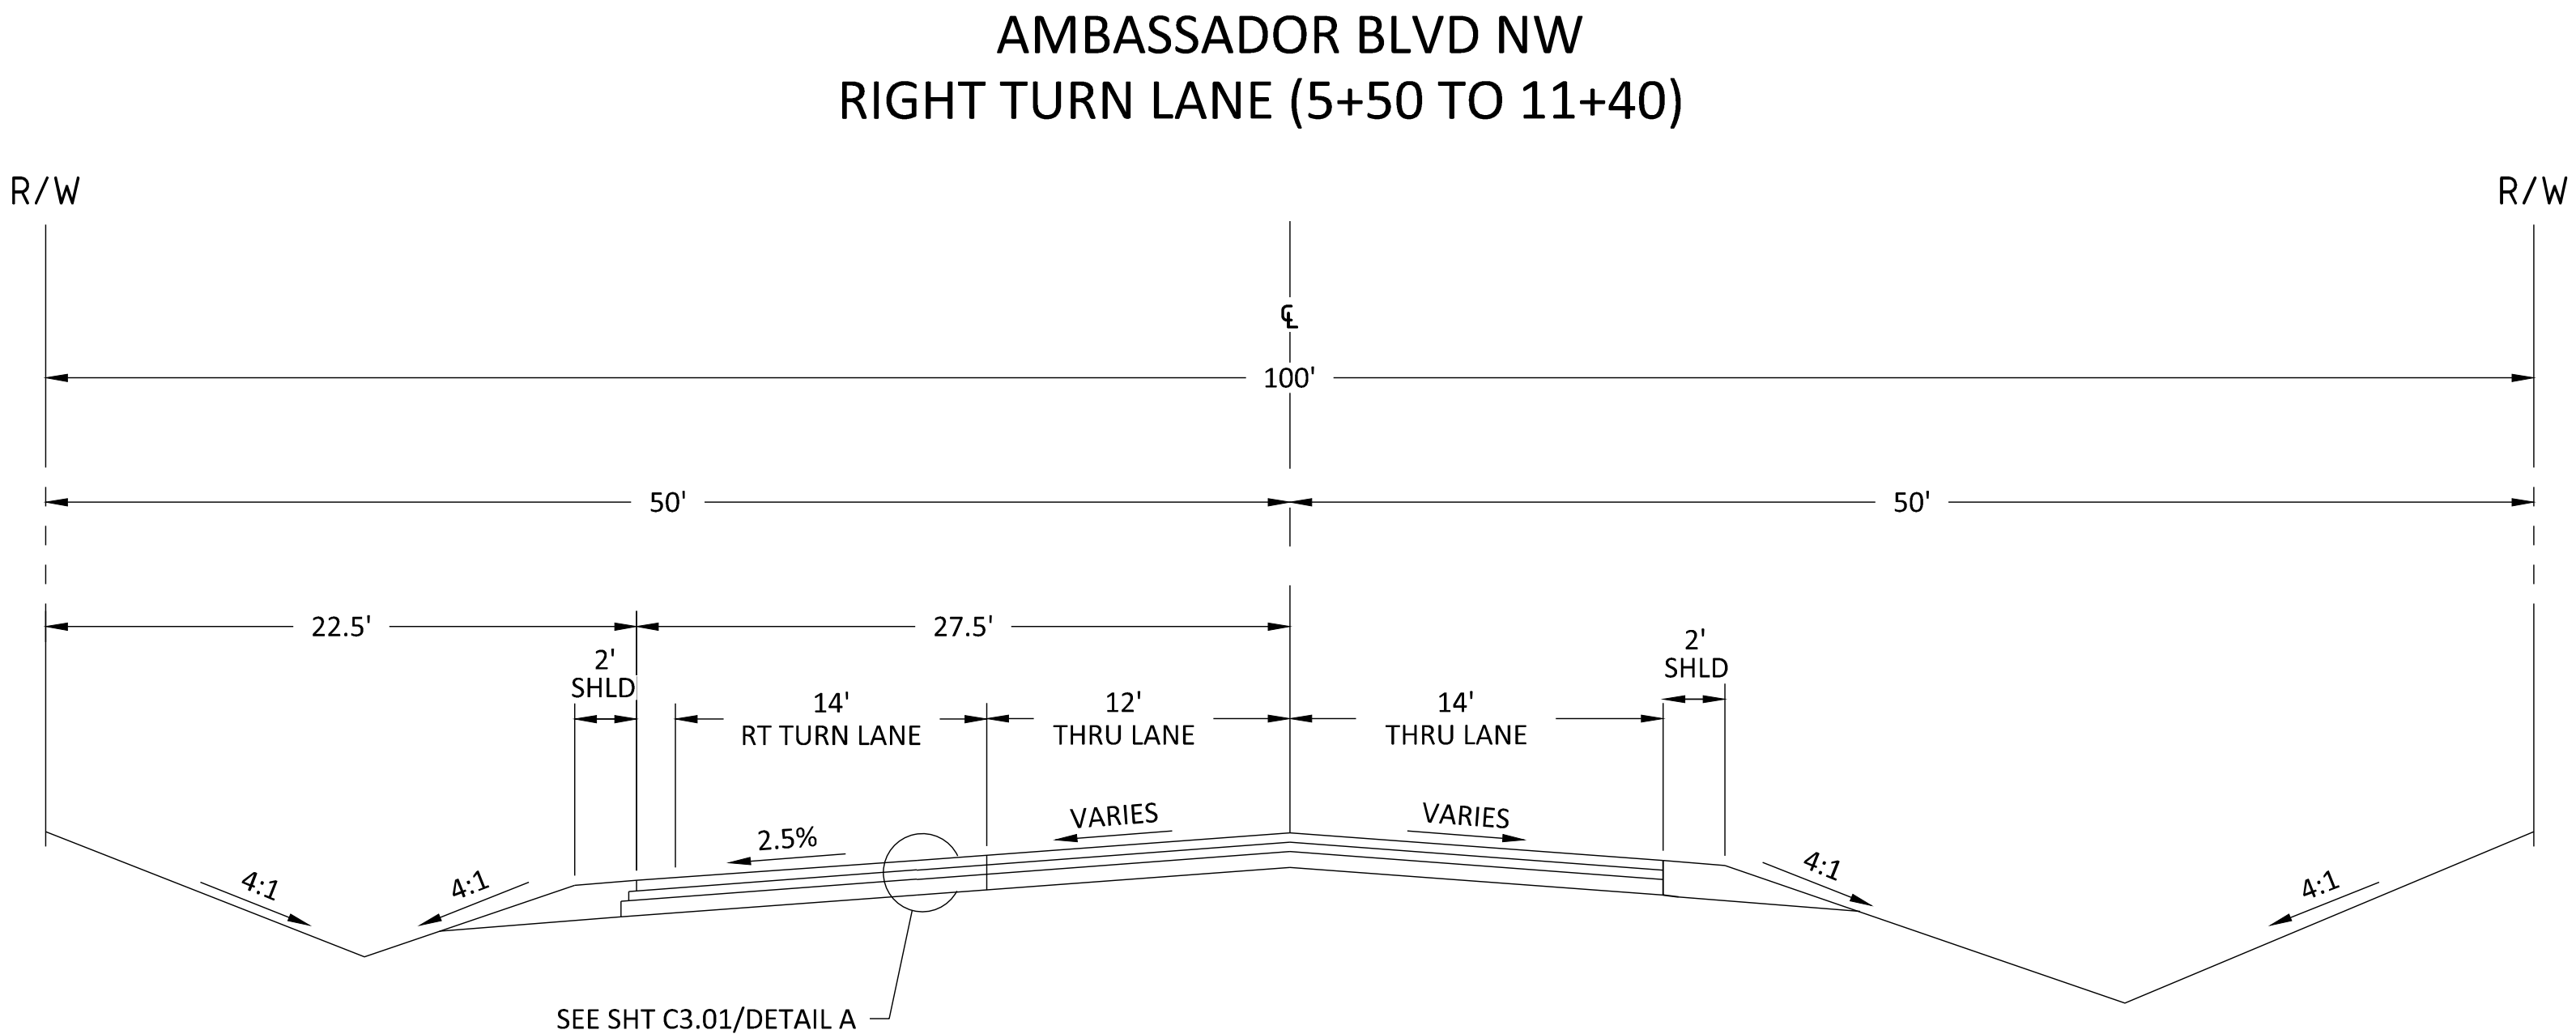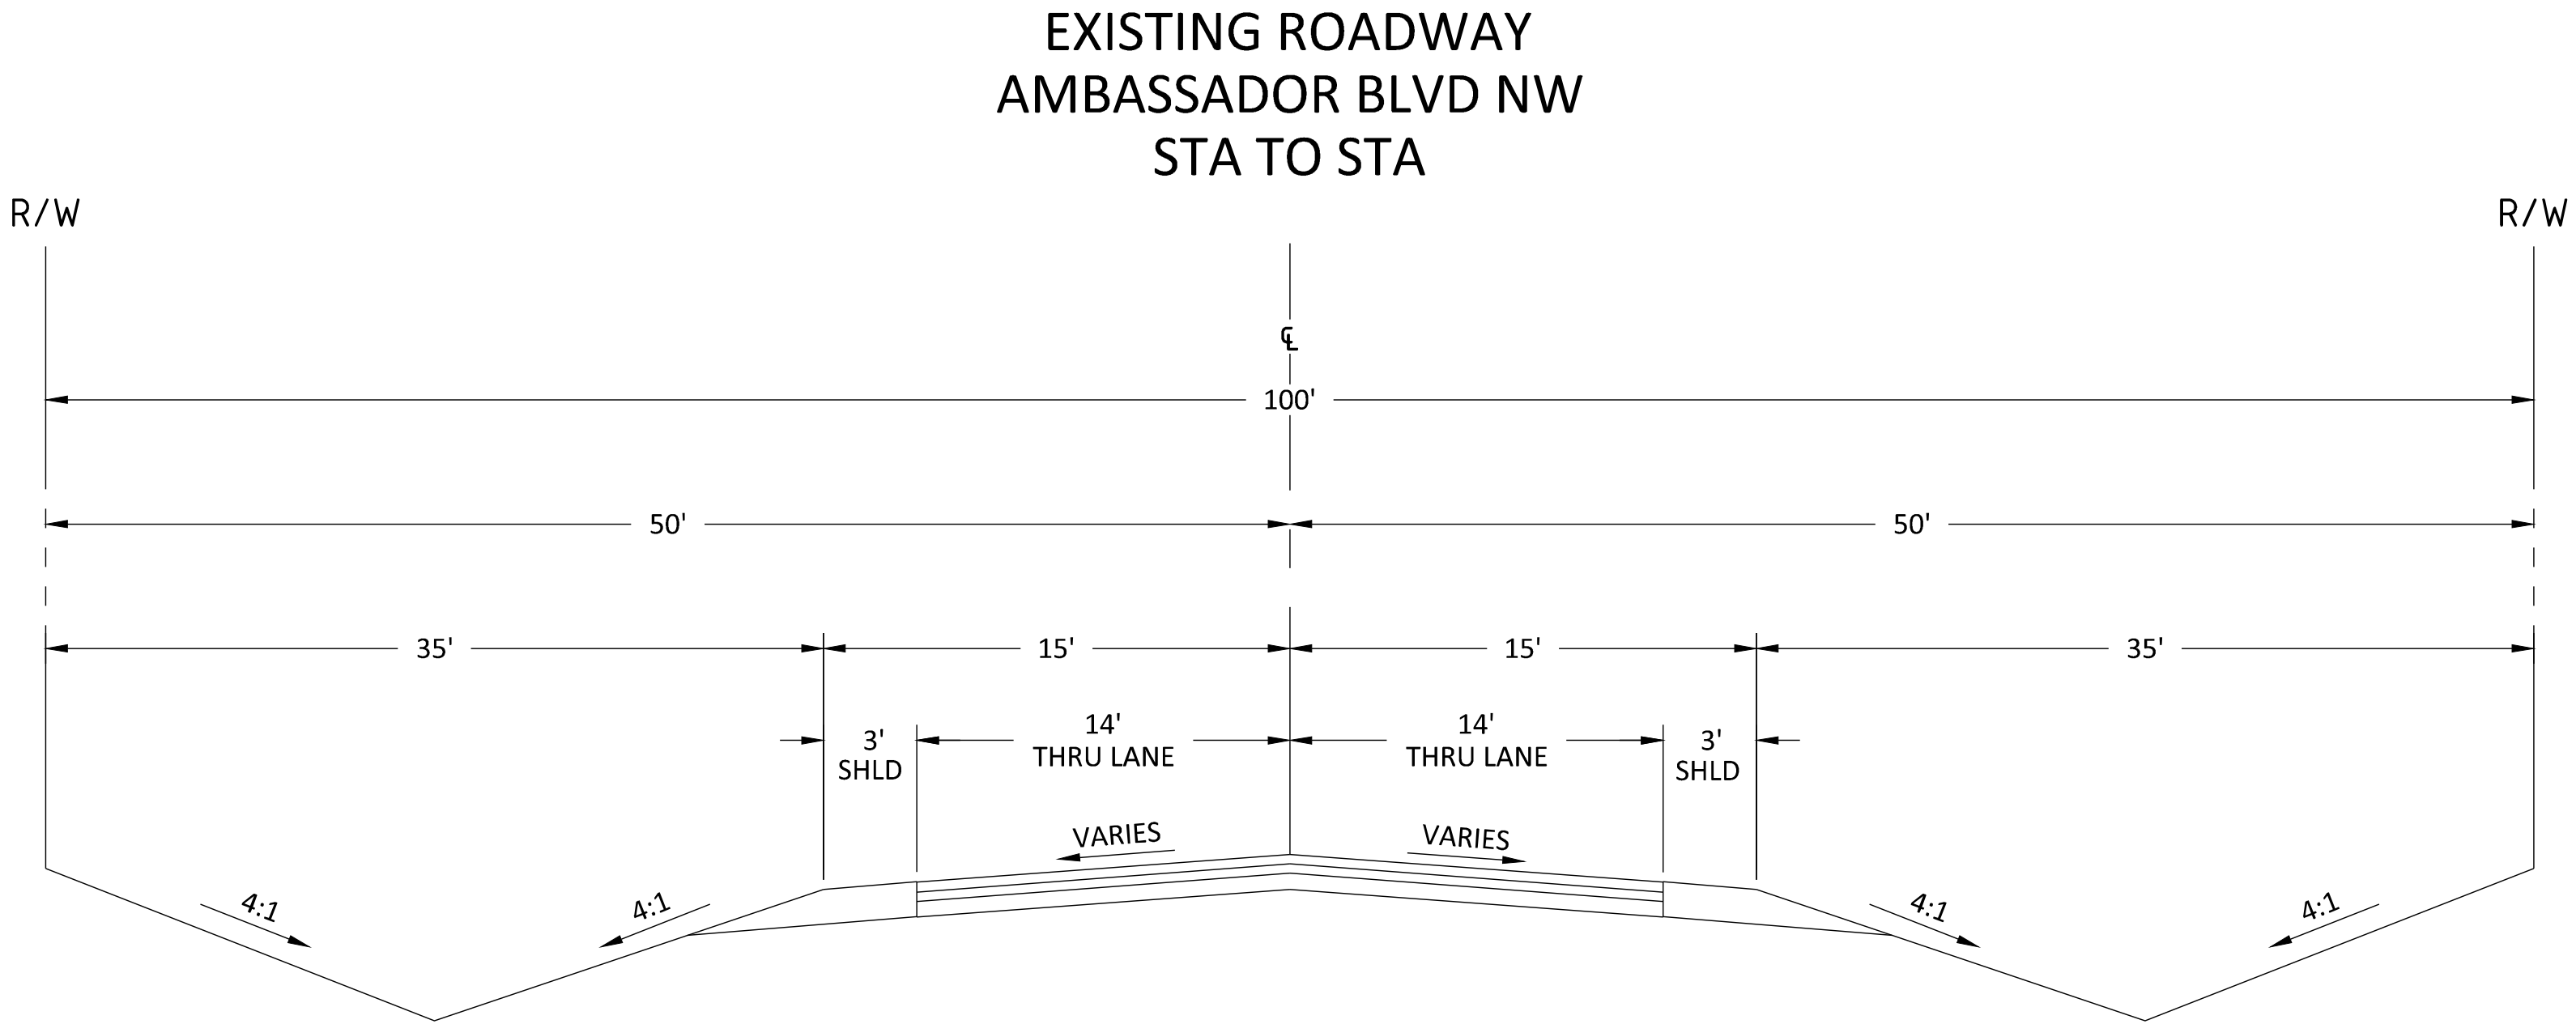

NO	DATE	BY	CKD	APPR	COMMENT

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DESIGNED BY JIG

CHECKED BY MJN

PROJECT NO. 22377



ESTIMATED QUANTITIES & TYPICAL SECTIONS

Anoka County, MN

Ambassador Blvd. Right Turn Lane

St. Francis, MN








SHEET

C2.01

2 OF 11

REV.



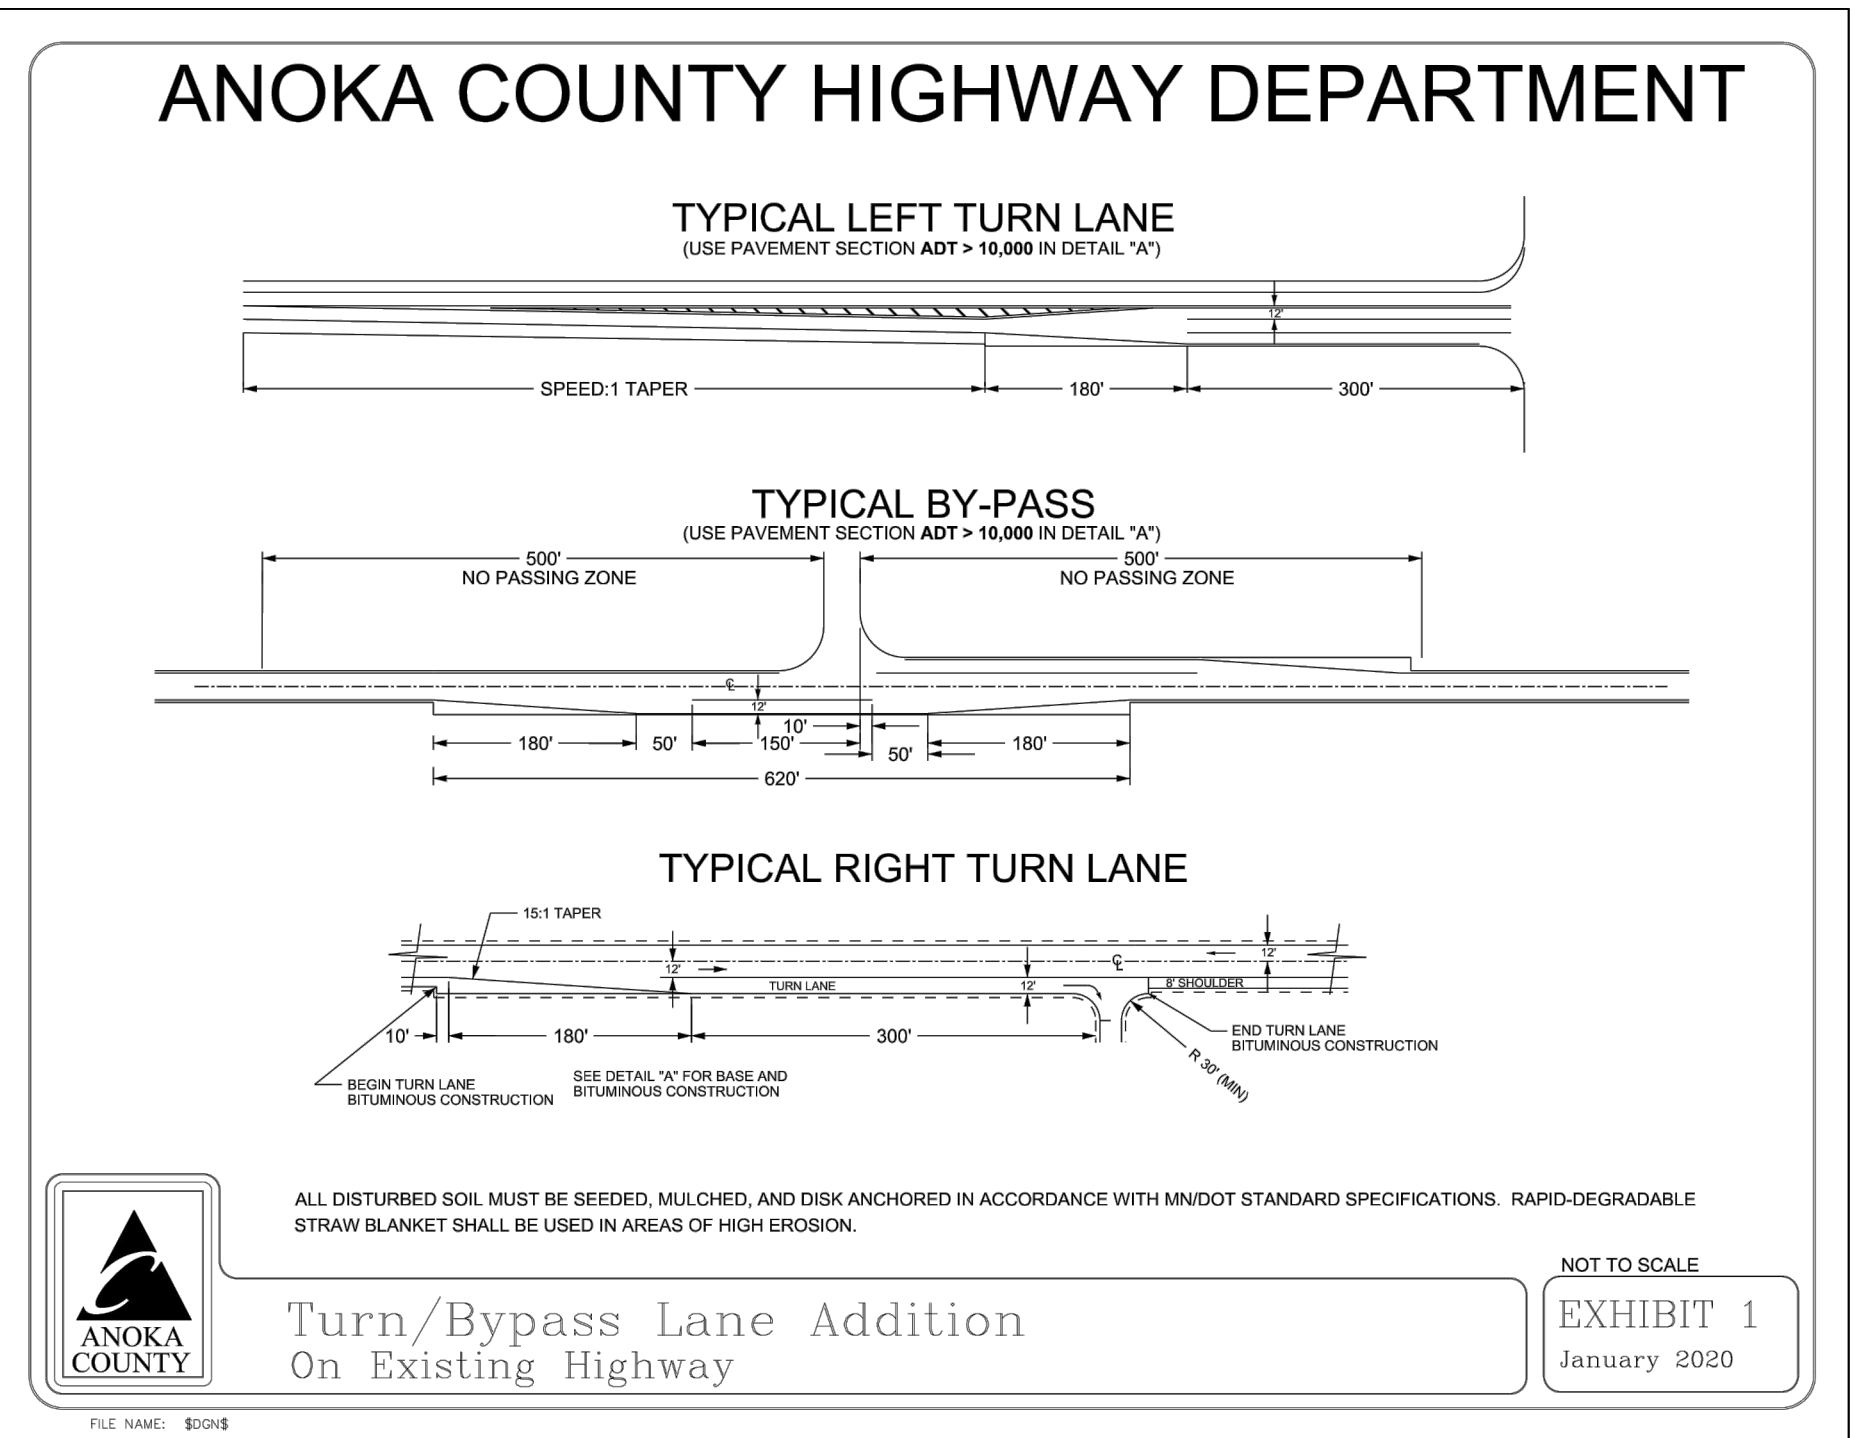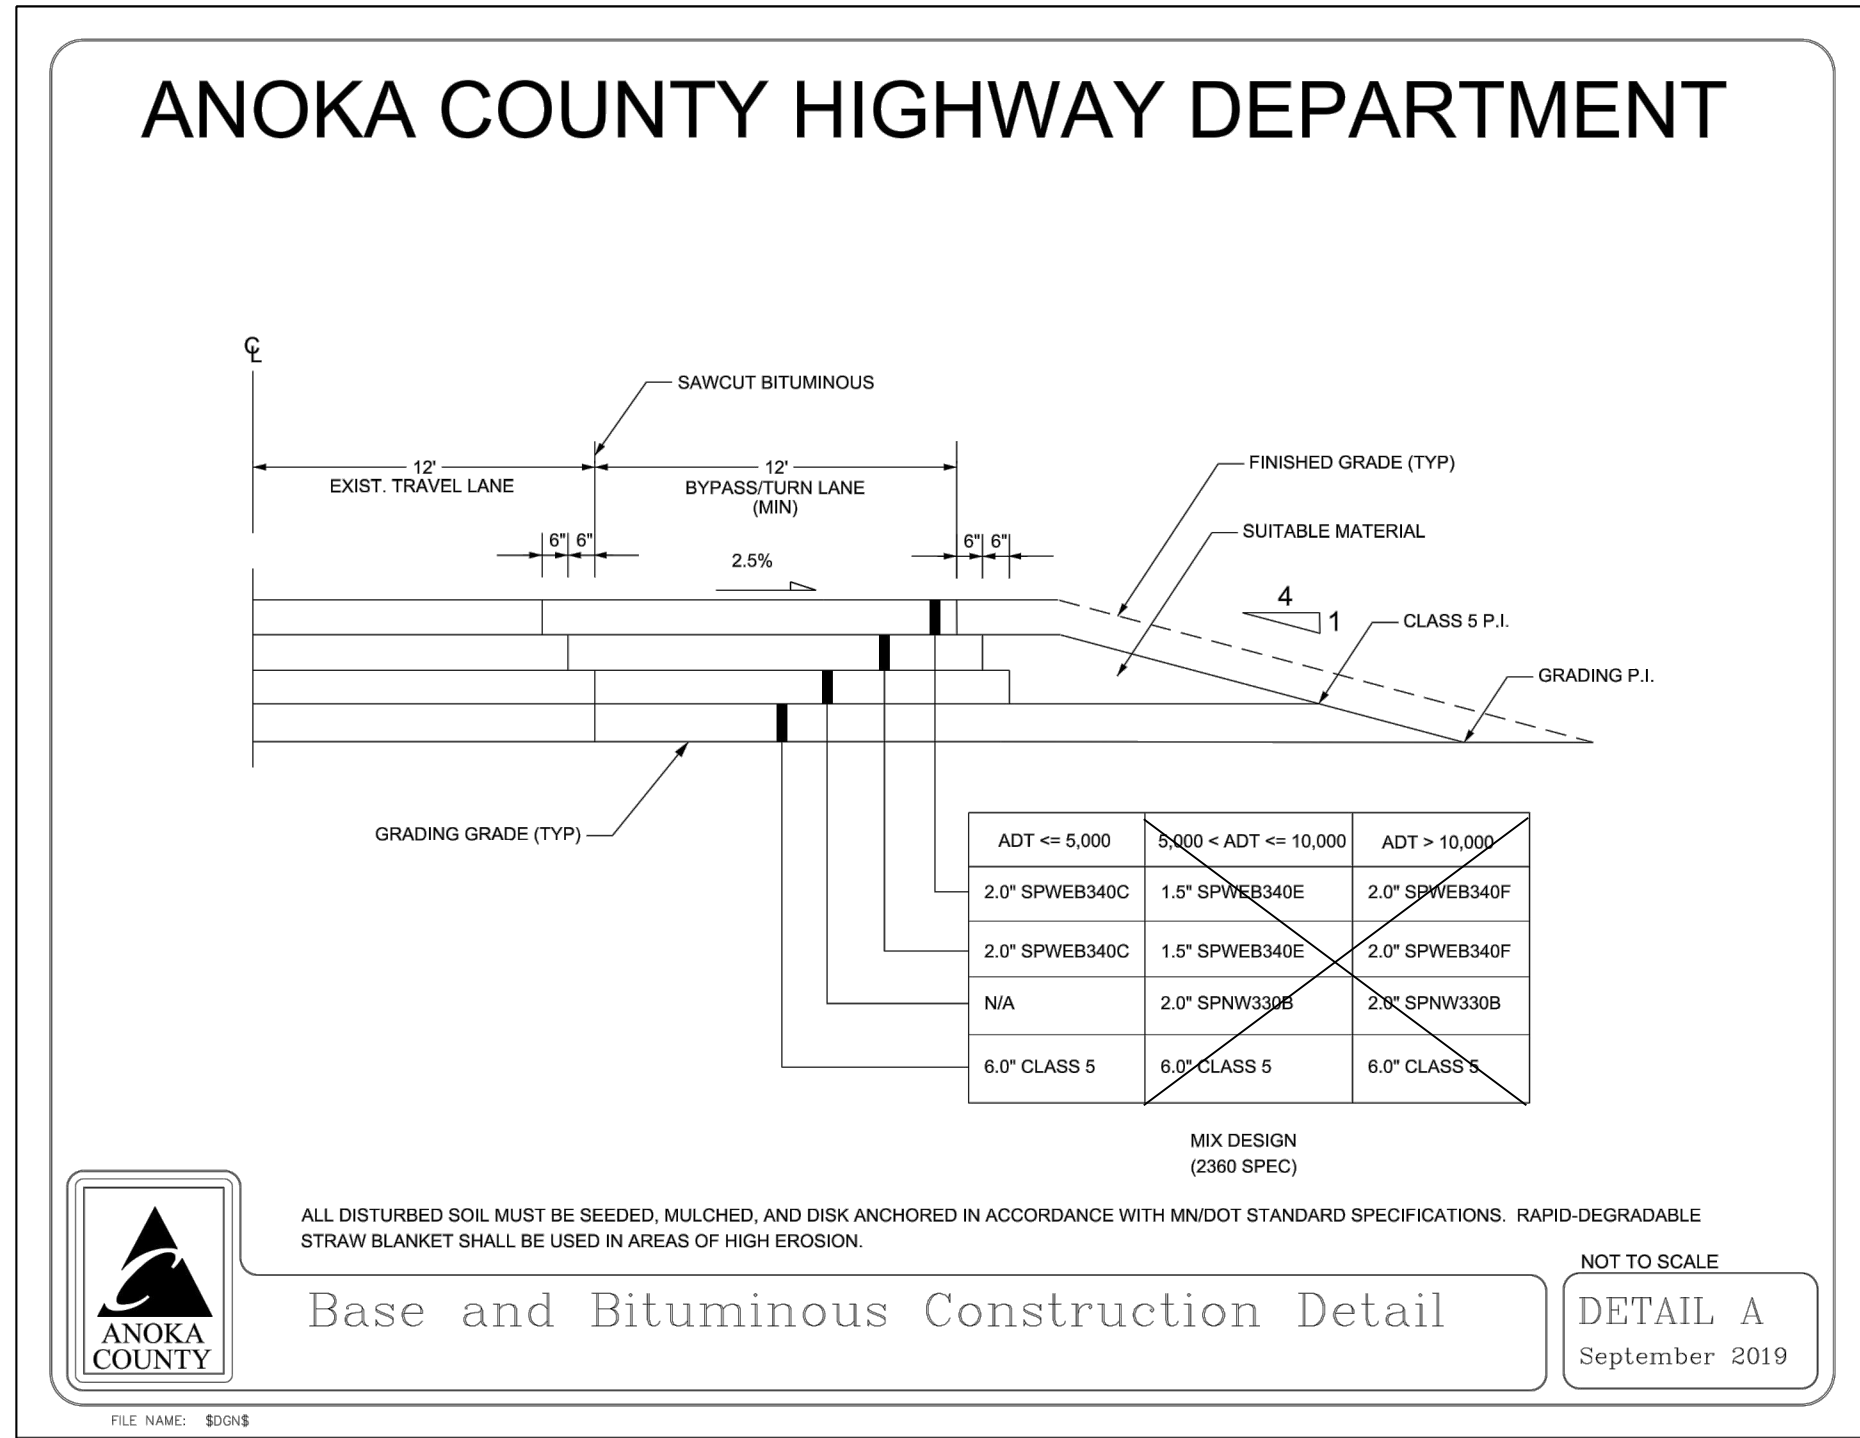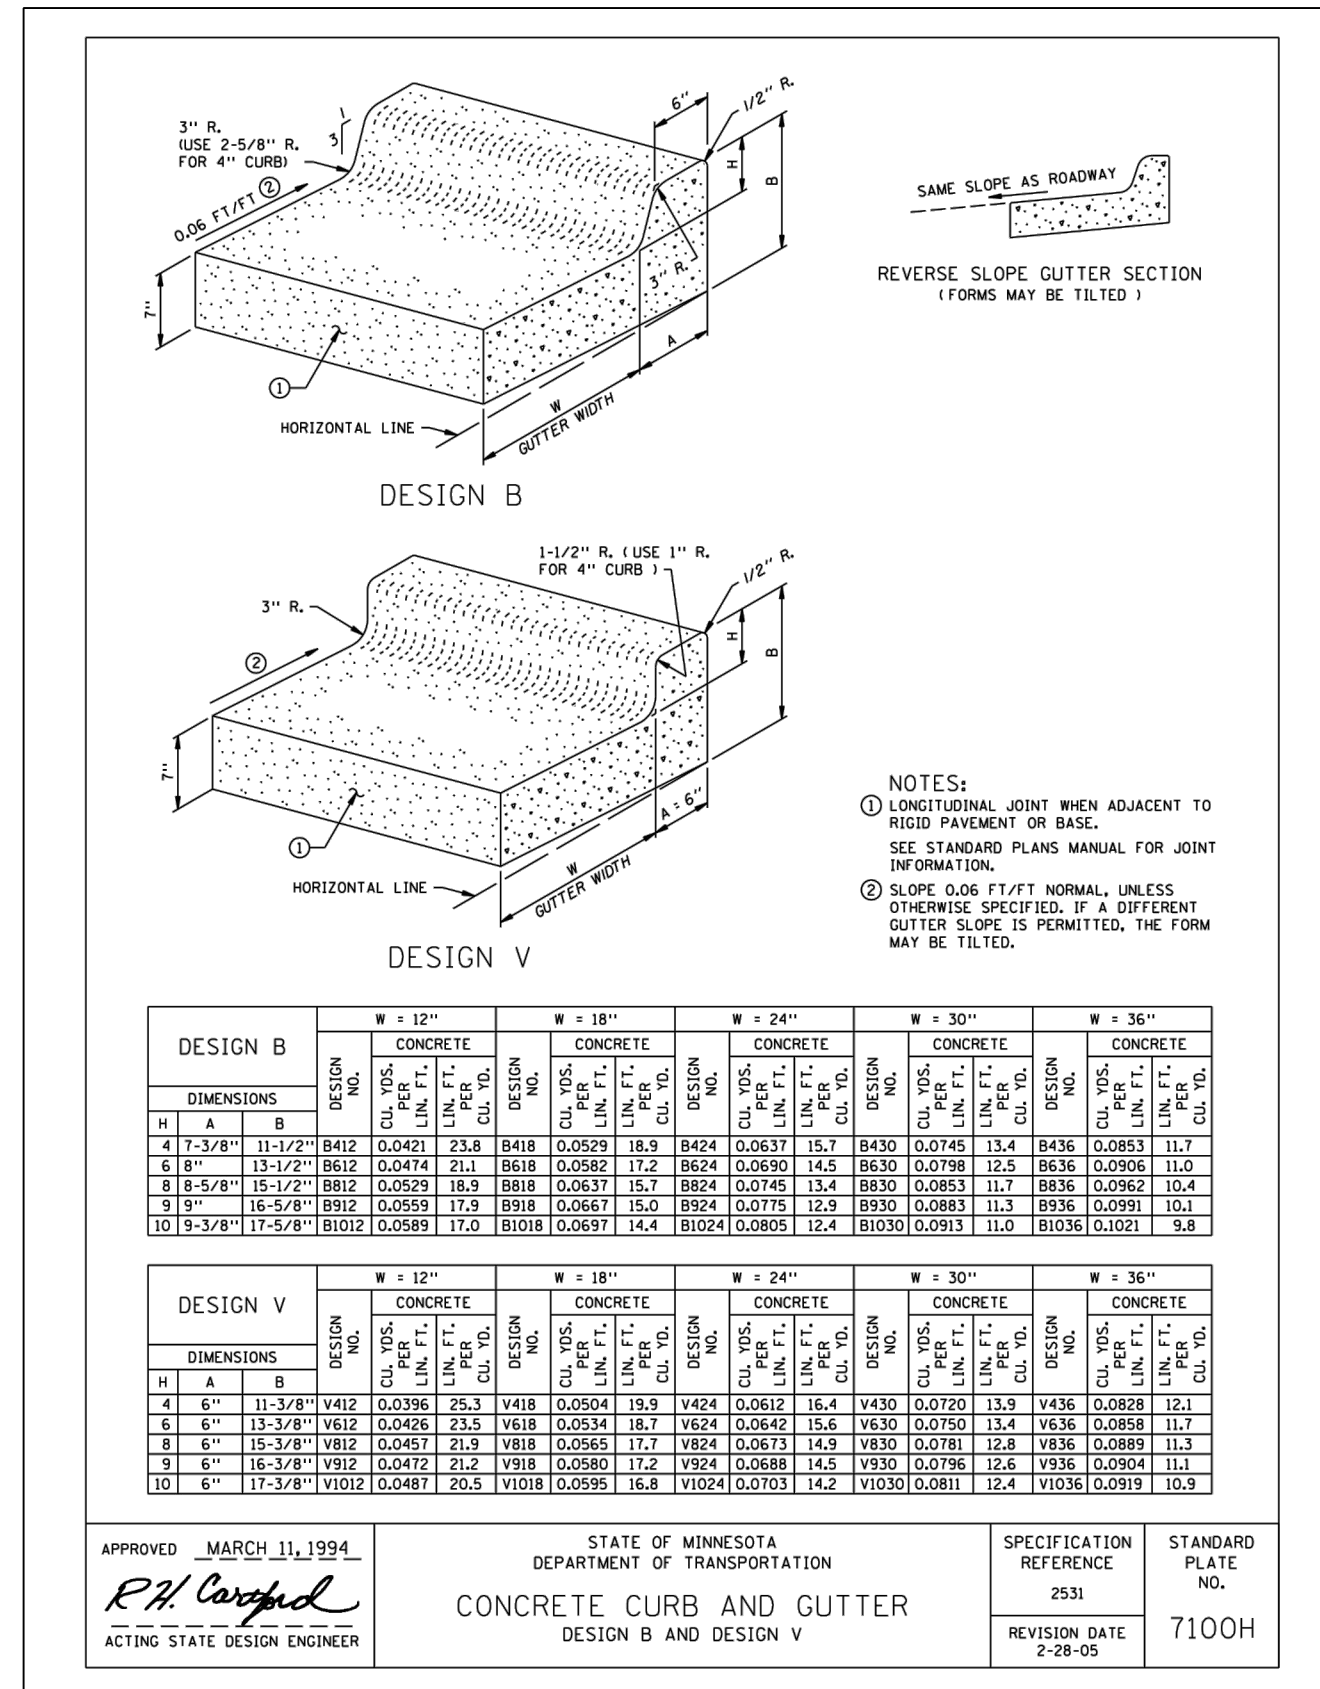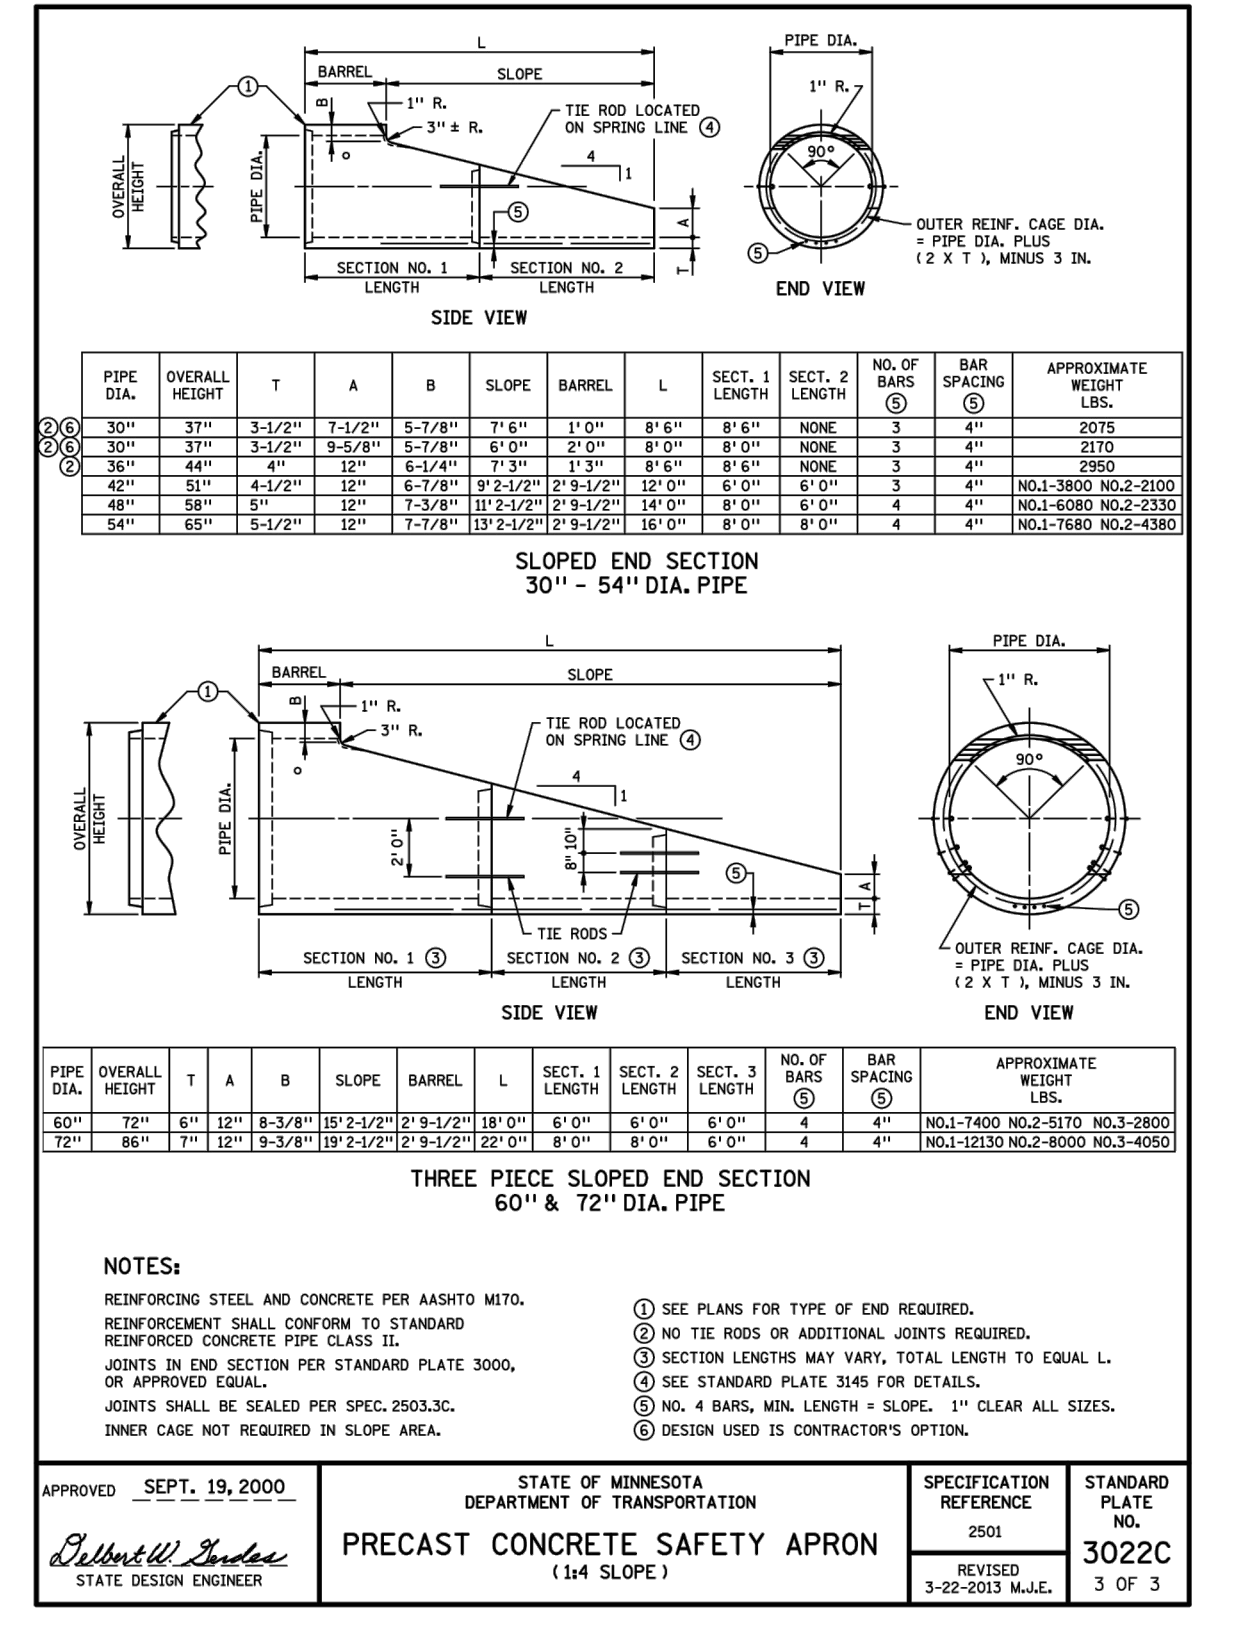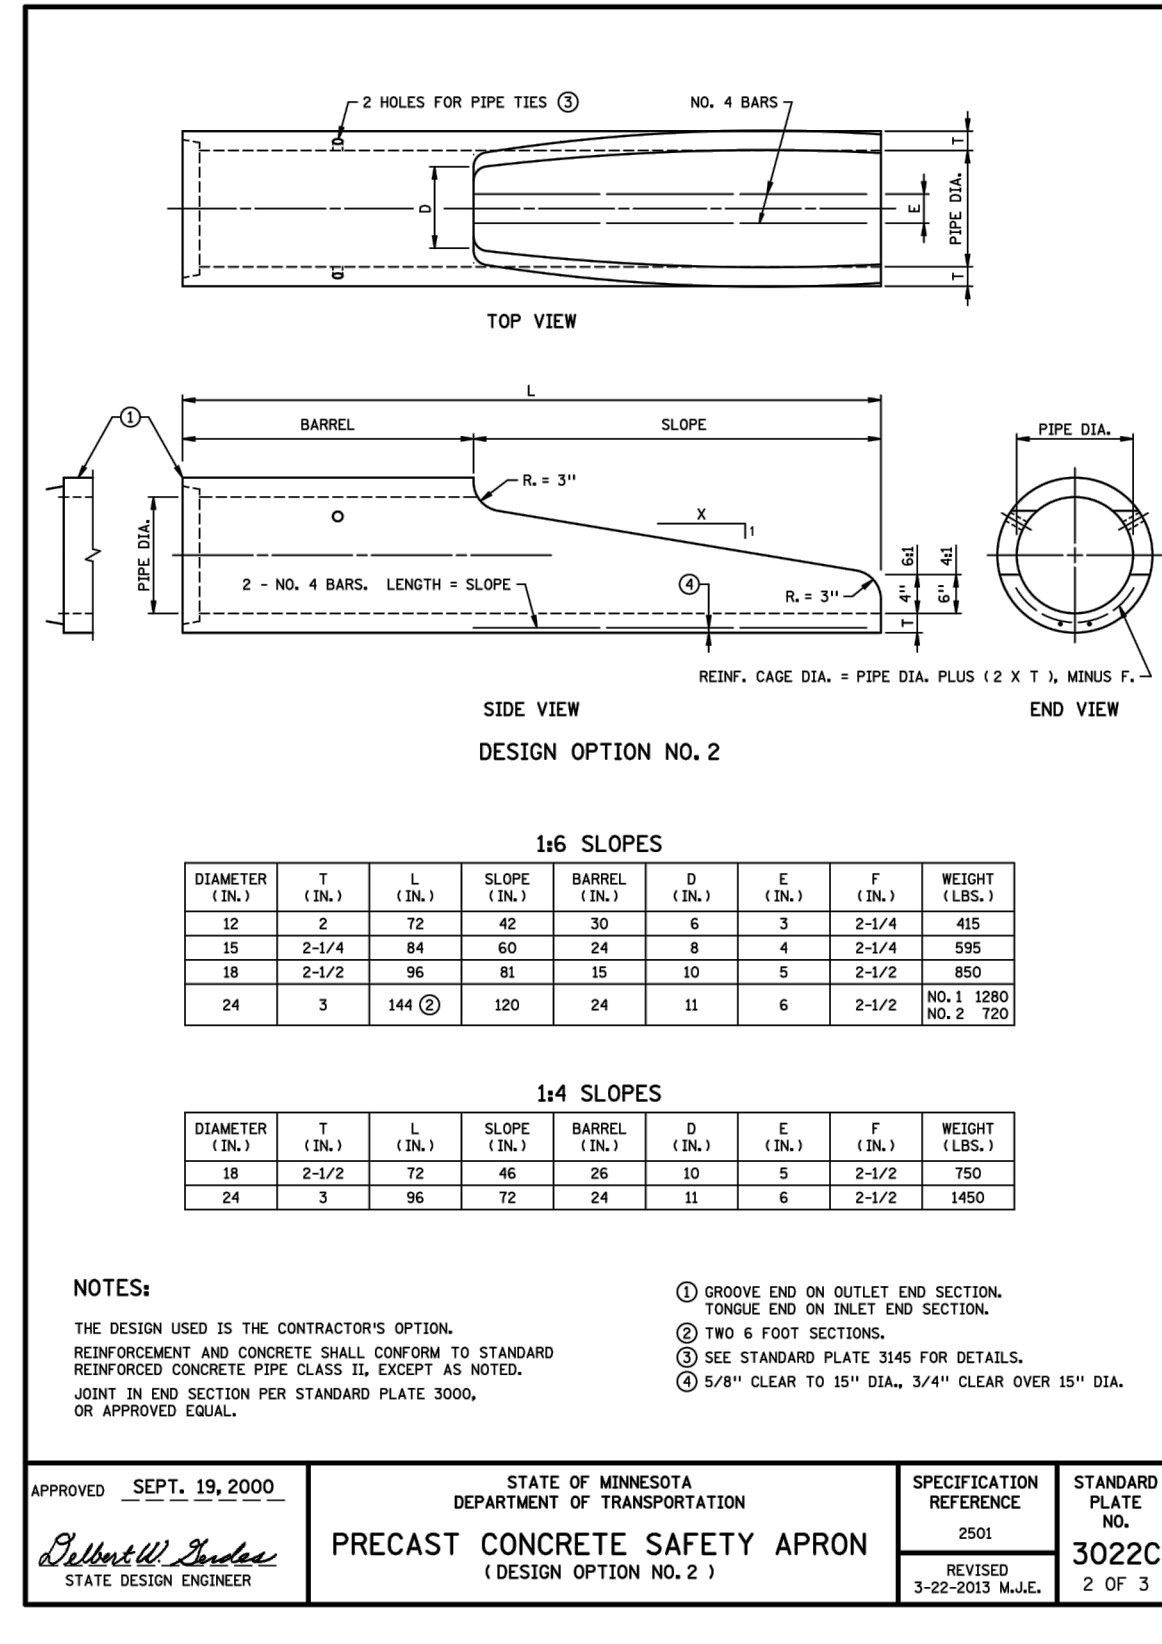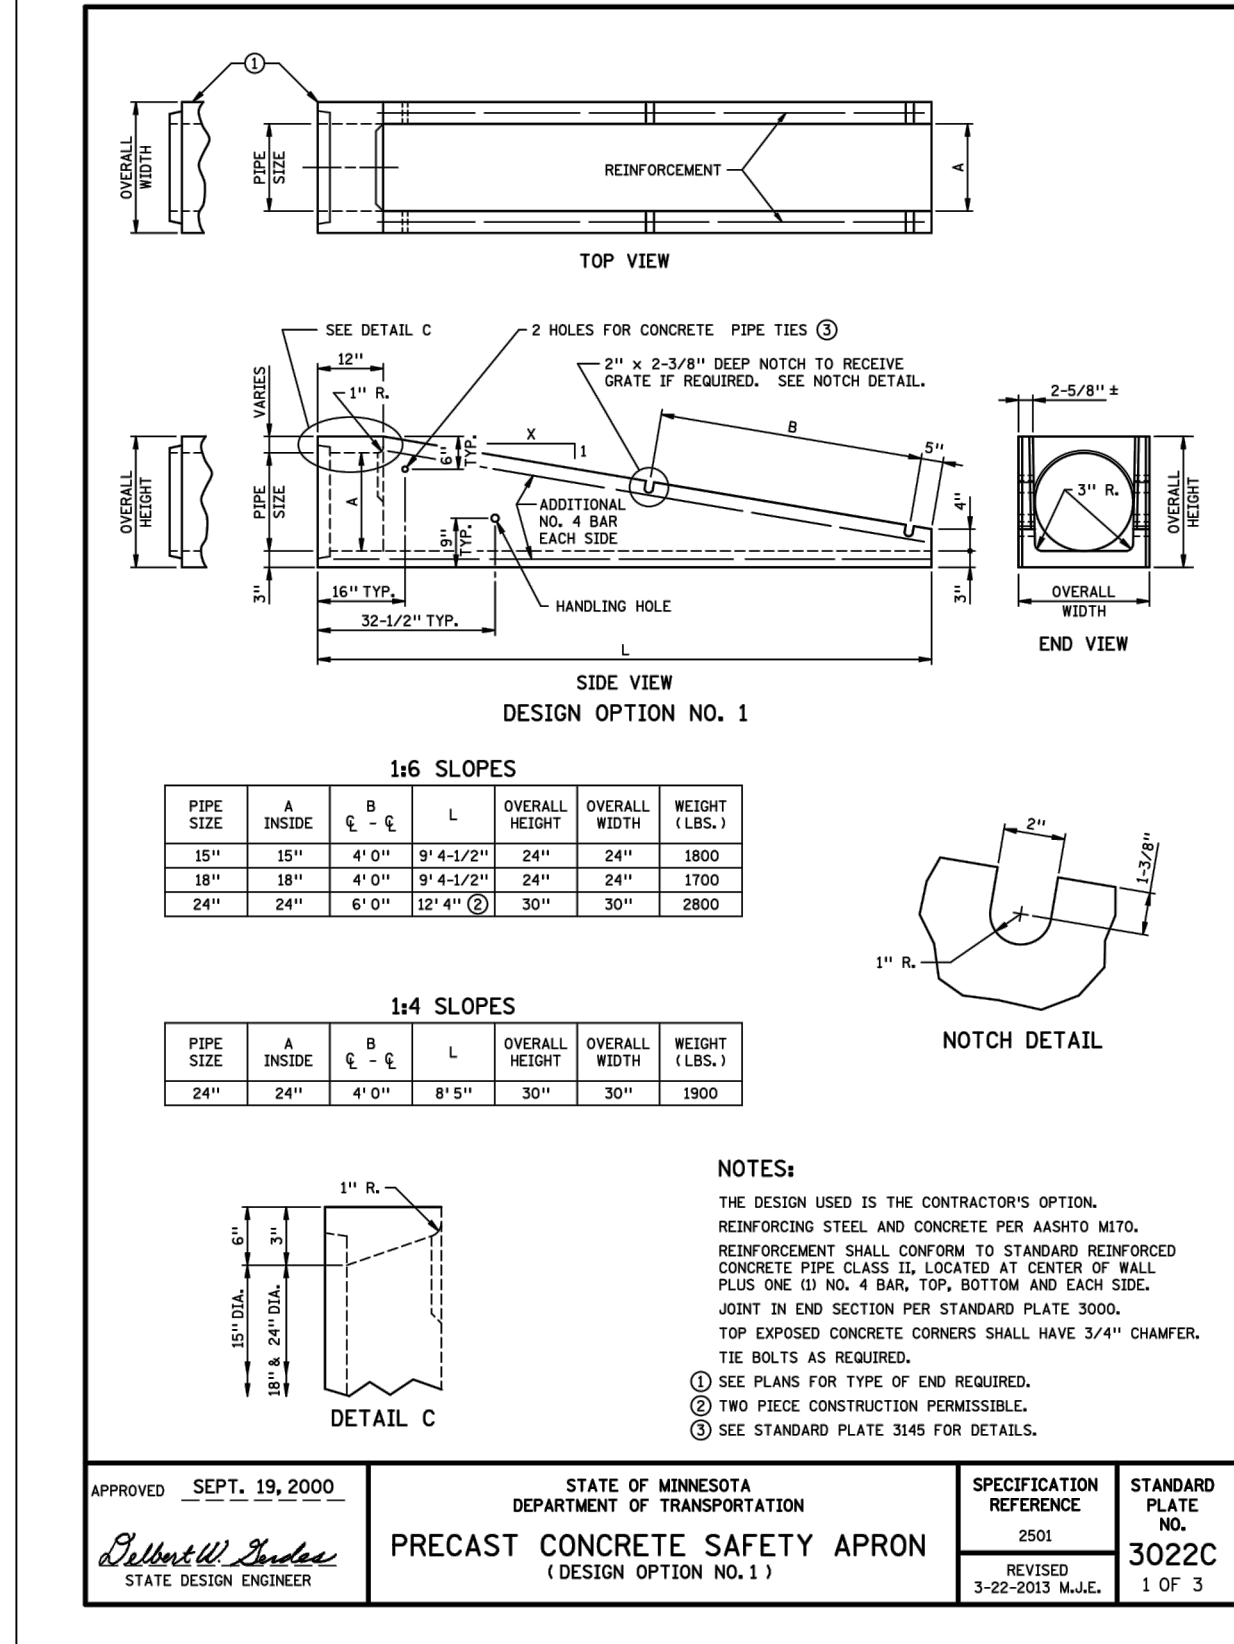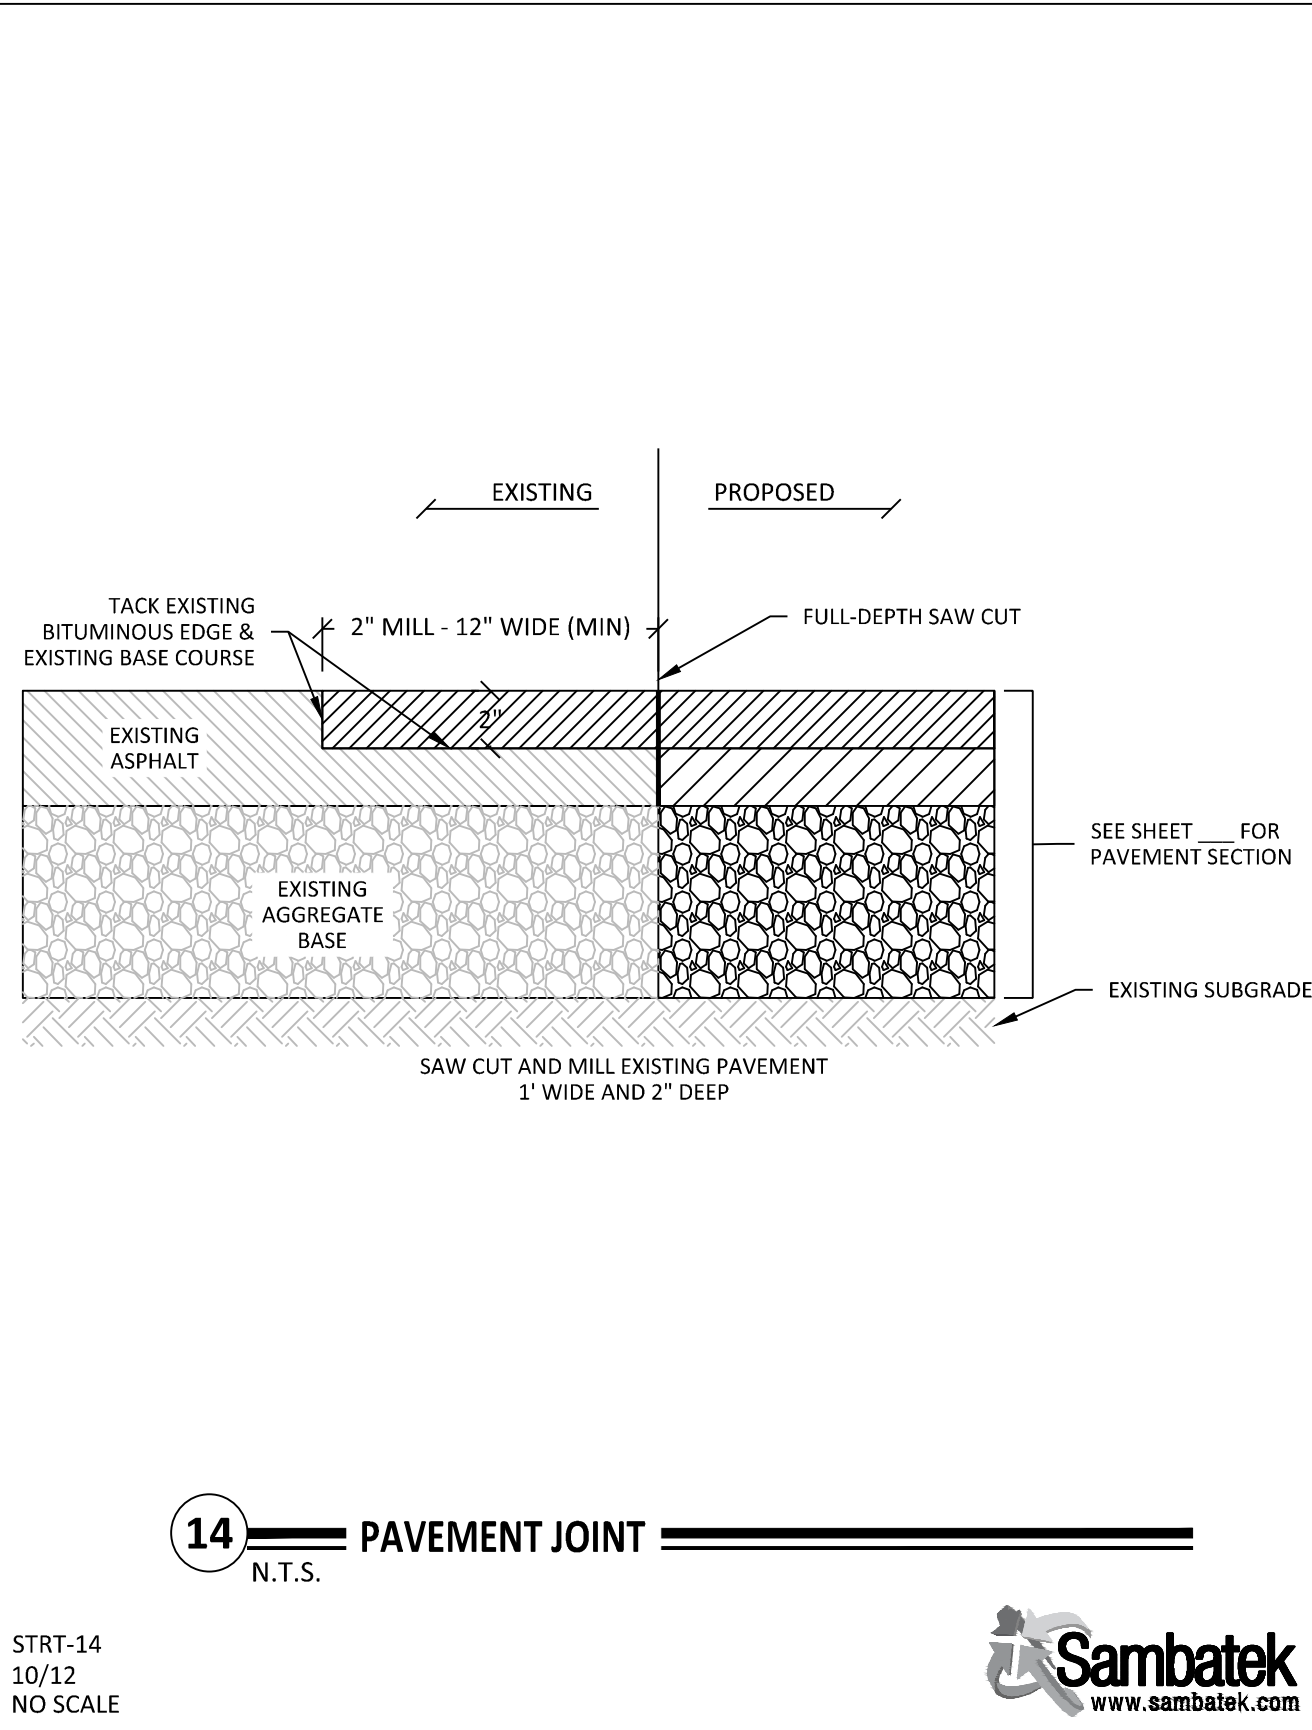

22.05 (LWS TECH) | DAVID DANZL | 8/25/2022 11:55:54 AM  
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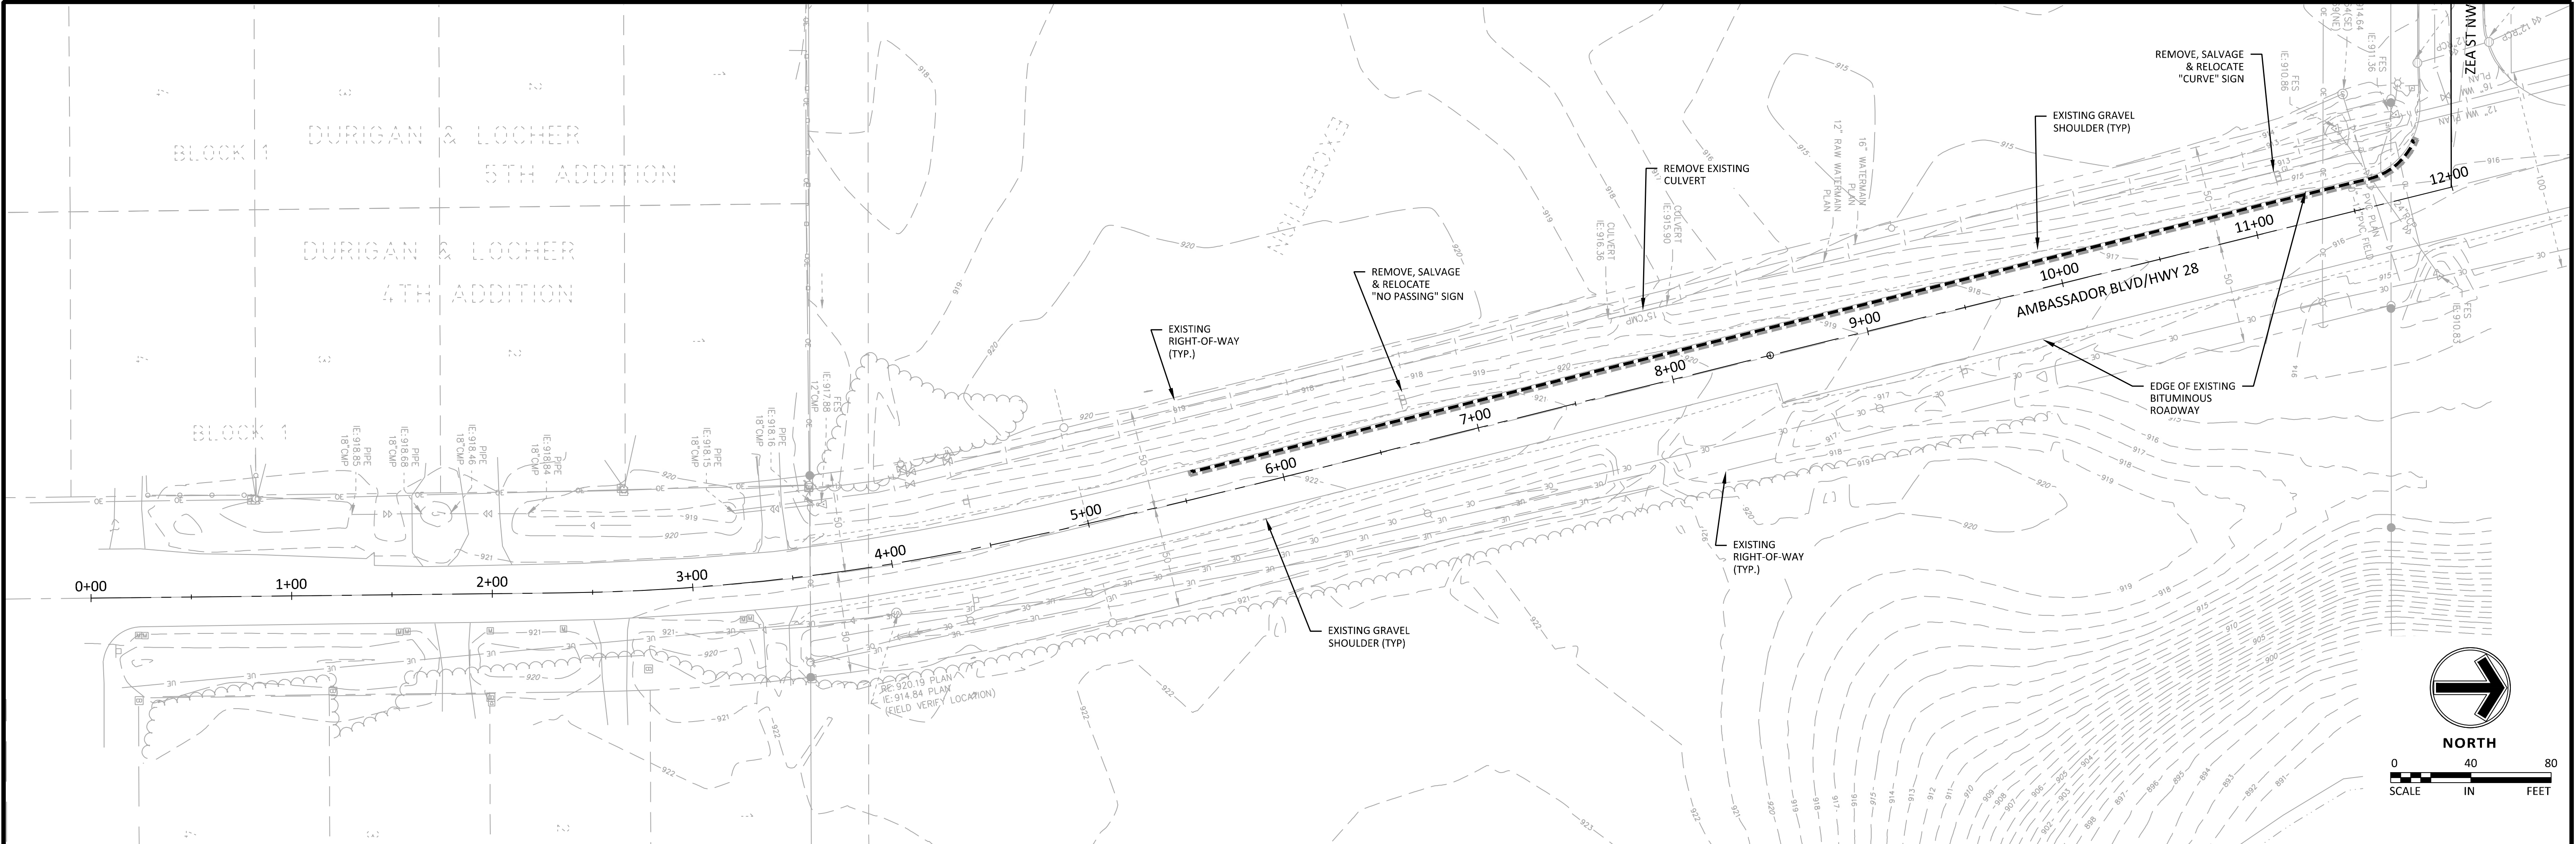
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22377

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**DETAIL SHEET**  
Anoka County, MN  
Ambassador Blvd. Right Turn Lane  
St. Francis, MN

SHEET  
**C3.01**  
3 OF 11  
REV.





LEGEND

- FOUND MONUMENT

○ SET MONUMENT

○ MARKED XXXXX

⊠ ELECTRIC METER

⊛ LIGHT

⊠ AIR CONDITIONER

⊠ GUY ANCHOR

♿ HANDICAP STALL

○ UTILITY POLE

● POST

⊠ SIGN

⊠ MAILBOX
- ⊠ WATERMAIN

⊠ SANITARY SEWER

⊠ STORM SEWER

⊠ FLARED END SECTION

⊠ TELEPHONE PEDESTAL

⊠ ELECTRIC TRANSFORMER

⊠ GAS METER

— OW — OVERHEAD WIRE

— ○ — CHAIN LINK FENCE

— ⊠ — IRON FENCE

— x — WIRE FENCE

— □ — WOOD FENCE
- — — RIGHT-OF-WAY LINE

— — — EASEMENT LINE

— — — SETBACK LINE

— Δ — RESTRICTED ACCESS

===== CONCRETE CURB

/// BUILDING LINE

——— BUILDING CANOPY

BIT

CONC

DEMOLITION LEGEND

- 2" MILL BITUMINOUS SURFACE
- SAW CUT EXISTING PAVEMENT

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IT SHALL BE THE RESPONSIBILITY OF THE CONTRACTOR TO RELOCATE ALL EXISTING UTILITIES WHICH CONFLICT WITH THE PROPOSED IMPROVEMENTS SHOWN ON THE PLANS.

NO	DATE	BY	CKD	APPR	COMMENT

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DESIGNED BY JJG

CHECKED BY MJN

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EXISTING CONDITIONS & REMOVAL PLAN

Anoka County, MN

Ambassador Blvd. Right Turn Lane

St. Francis, MN


SHEET

C4.01

4 OF 11

REV.



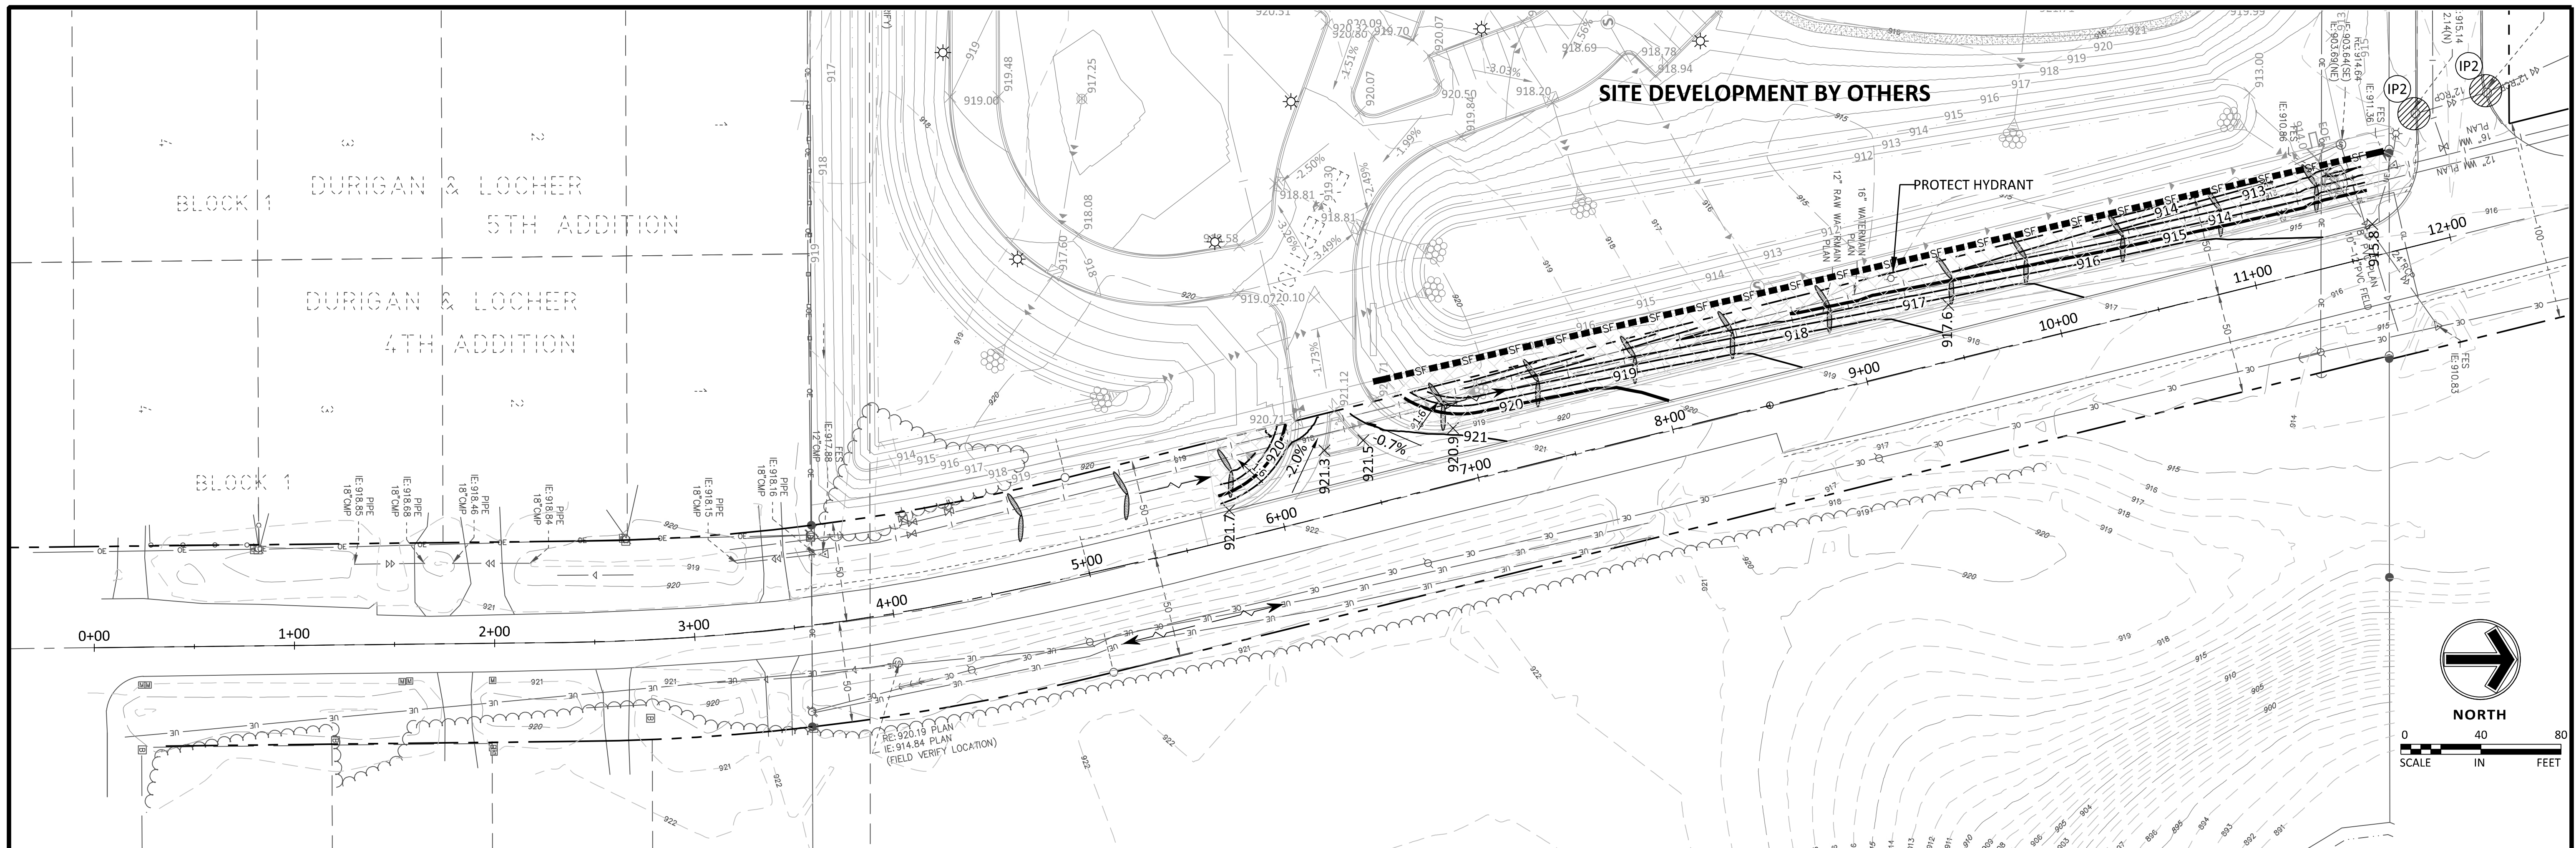

## NOTES

1. CONTRACTOR TO STABILIZE DENUDED AREAS WITHIN 7 DAYS OF ROUGH GRADING OR INACTIVITY.
2. SOIL STOCKPILES SHALL BE FIT WITH SEDIMENT-TRAPPING MEASURES.
3. SOIL STOCKPILES SHALL BE STABILIZED WITHIN 7 DAYS OF INACTIVITY.
4. THE TRANSPORT OF SEDIMENT BY RUNOFF OR VEHICLE TRACKING ONTO PAVED SURFACES SHALL BE MINIMIZED.
5. ALL TRACKED SEDIMENT SHALL BE SWEEPED AT THE END OF EACH DAY.
6. UPON DISCOVERY, ALL NONFUNCTIONAL BMPs WILL BE REPAIRED, REPLACED, OR SUPPLEMENTED BY THE END OF THE NEXT BUSINESS DAY.

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[illegible]

ITEM	UNIT	QUANTITY
SILT FENCE	LINEAR FEET	518
EROSION CONTROL BLANKET	SQUARE YARD	1,555
BIO-ROLL	LINEAR FEET	312
CONSTRUCTION ENTRANCE	UNIT	0
INLET PROTECTION DEVICE (IP-1)	UNIT	0
INLET PROTECTION DEVICE (IP-2)	UNIT	2

## LEGEND

**CURB & GUTTER**

**STORM SEWER**

**DRAINAGE DITCH**

**CONTOUR**

**RIP RAP**

**OVERFLOW ELEV.**

**SILT FENCE**

**SILT DIKE**

**LIMITS OF DISTURBANCE**

**SOIL BORINGS**

**DIRECTION OF OVERLAND FLOW**

**TEMPORARY DIVERSION DITCH**

**CHECK DAM**

**LIMITS OF DRAINAGE SUB-BASIN**

**BIO-ROLL**

**INLET PROTECTION DEVICE**

**TEMPORARY STONE CONSTRUCTION ENTRANCE**

**TEMPORARY SEDIMENT BASIN**

**TEMPORARY STORAGE AND PARKING AREA**

**TEMPORARY STABILIZATION MEASURES (SEED, MULCH, MATS OR BLANKETS AS OUTLINED IN THE SWPPP)**

**EROSION CONTROL BLANKET - MNDOT 3885, CATEGORY 20**

**PROPOSED**

**EXISTING**

**SF**

**SD**

**SB**

**TS**

**TSM**

**ST 5**

**902.5**

[illegible]

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Print Name: Michael Nielson

*Michael Nielson*

Date 08/29/2022 License # 23623

PRELIMINARY

## DESIGN REVIEW

PERMIT SUBMITTAL

---

CONSTRUCTION DOCUMENTS

DRAWN BY

DESIGNED BY

CHECKED BY

PROJECT NO.  
22377



## EROSION CONTROL PLAN


Anoka County, MN  
Ambassador Blvd. Right Turn Lane

St. Francis, MN

SHEET


C5.01  
5 OF 11  
REV.



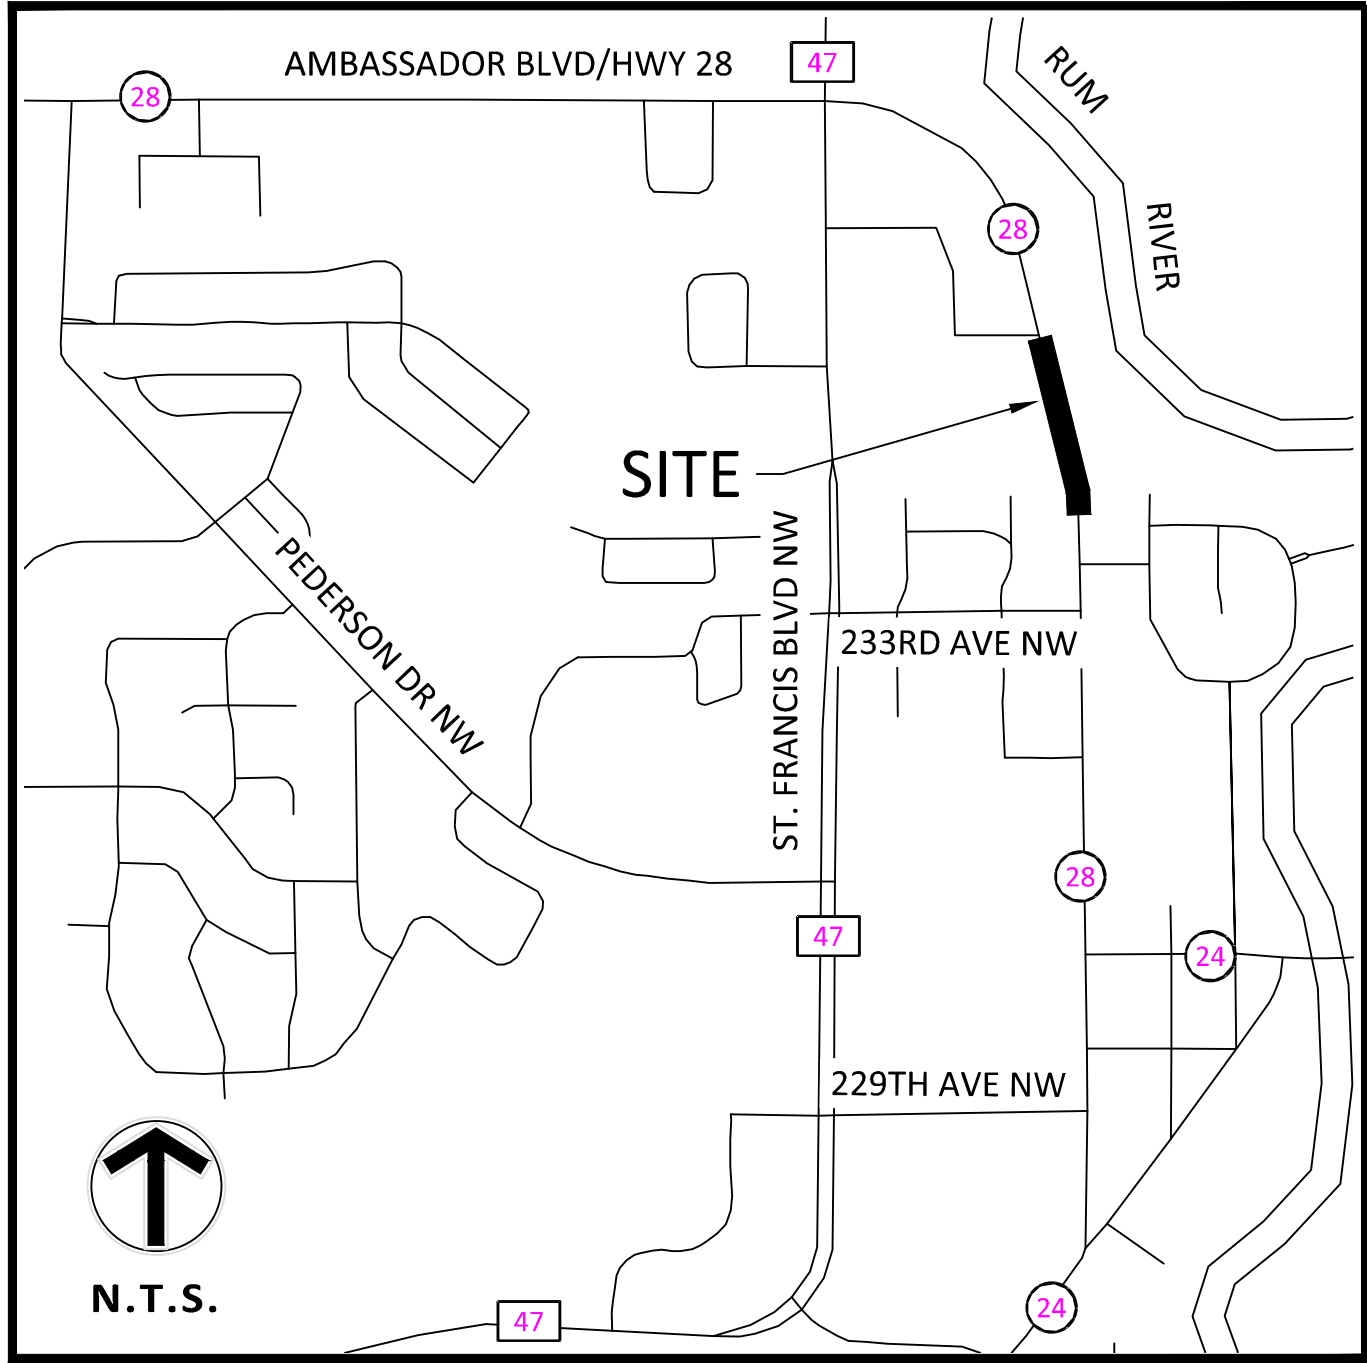

SITE LOCATION MAP

NOT TO SCALE

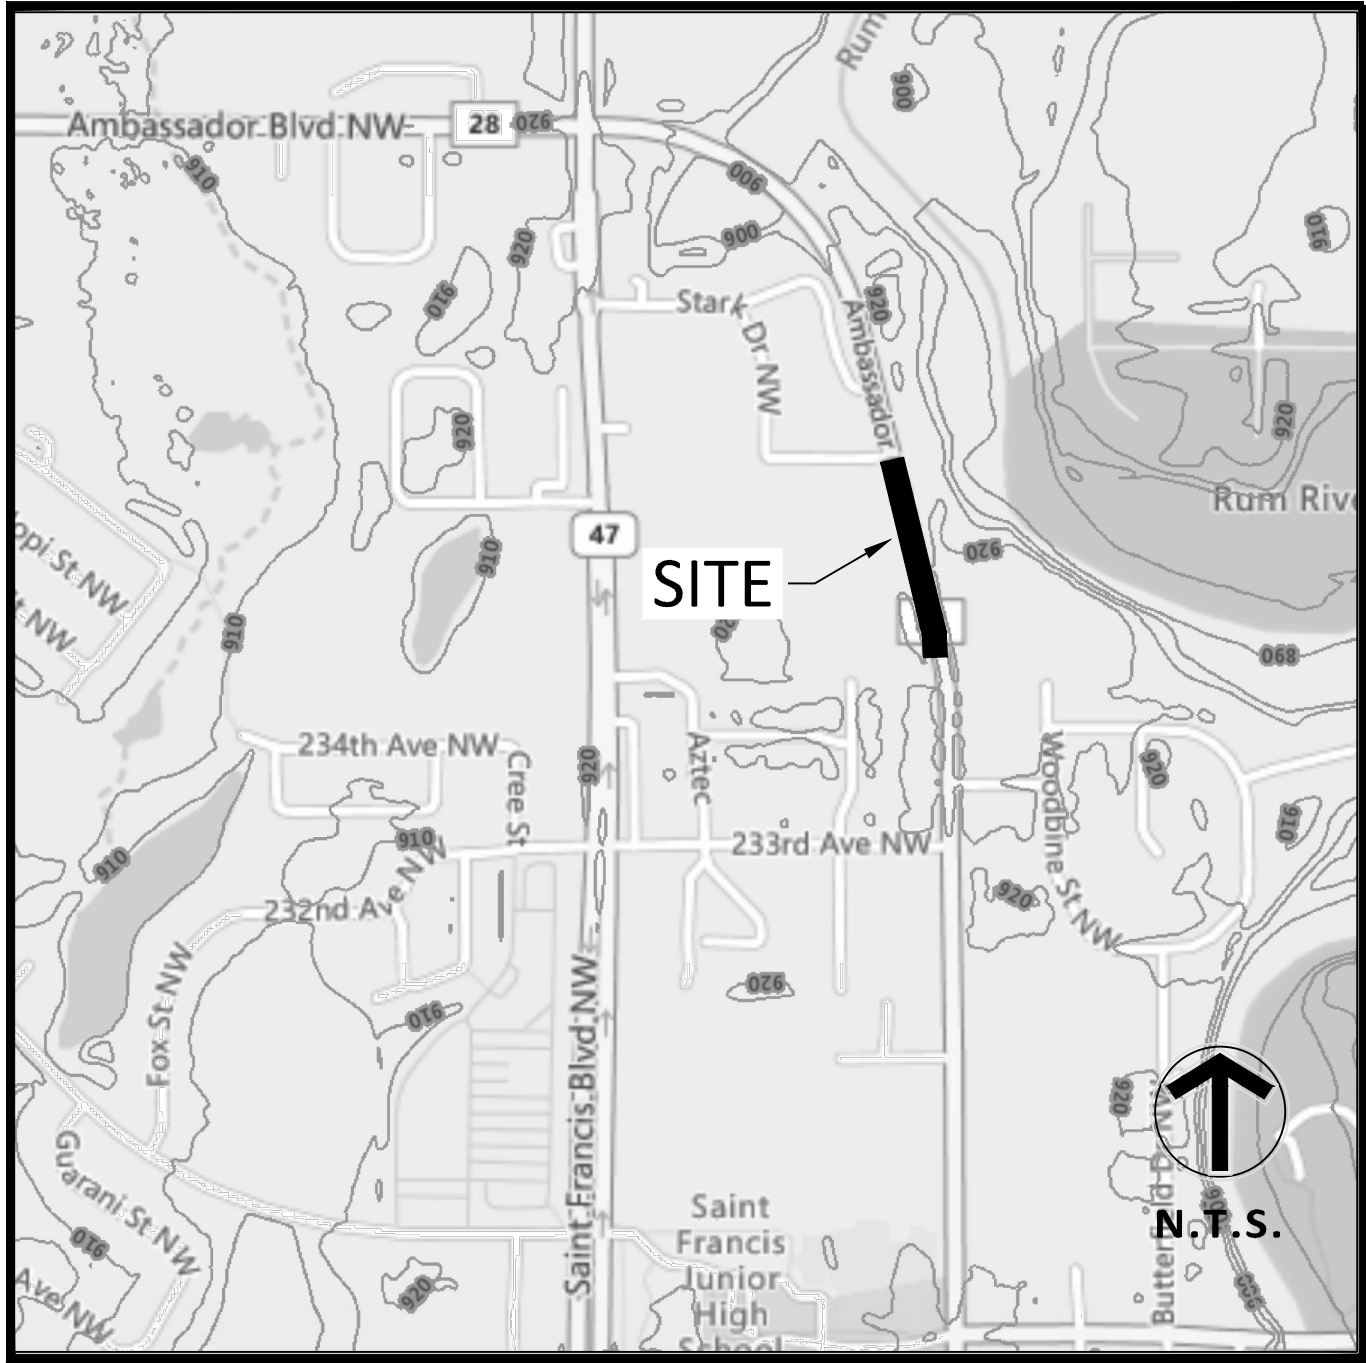

USGS MAP

NOT TO SCALE


AREA SUMMARY IN ACRES

PAVEMENT AREA	XX.XX AC±
BUILDING AREA	XX.XX AC±
SEEDS AREA	XX.XX AC±
TOTAL DISTURBED	0.66 AC±
PRE - CONSTRUCTION IMPERVIOUS	XX.XX AC±
POST - CONSTRUCTION IMPERVIOUS	XX.XX AC±

MAINTENANCE NOTES:


DEVELOPER/OWNER: XXXXXX XXXXXX XXXXXX XXX-XXX-XXXX
SITE OPERATOR / GENERAL CONTRACTOR
SUPERINTENDENT:

SEQUENCE OF CONSTRUCTION

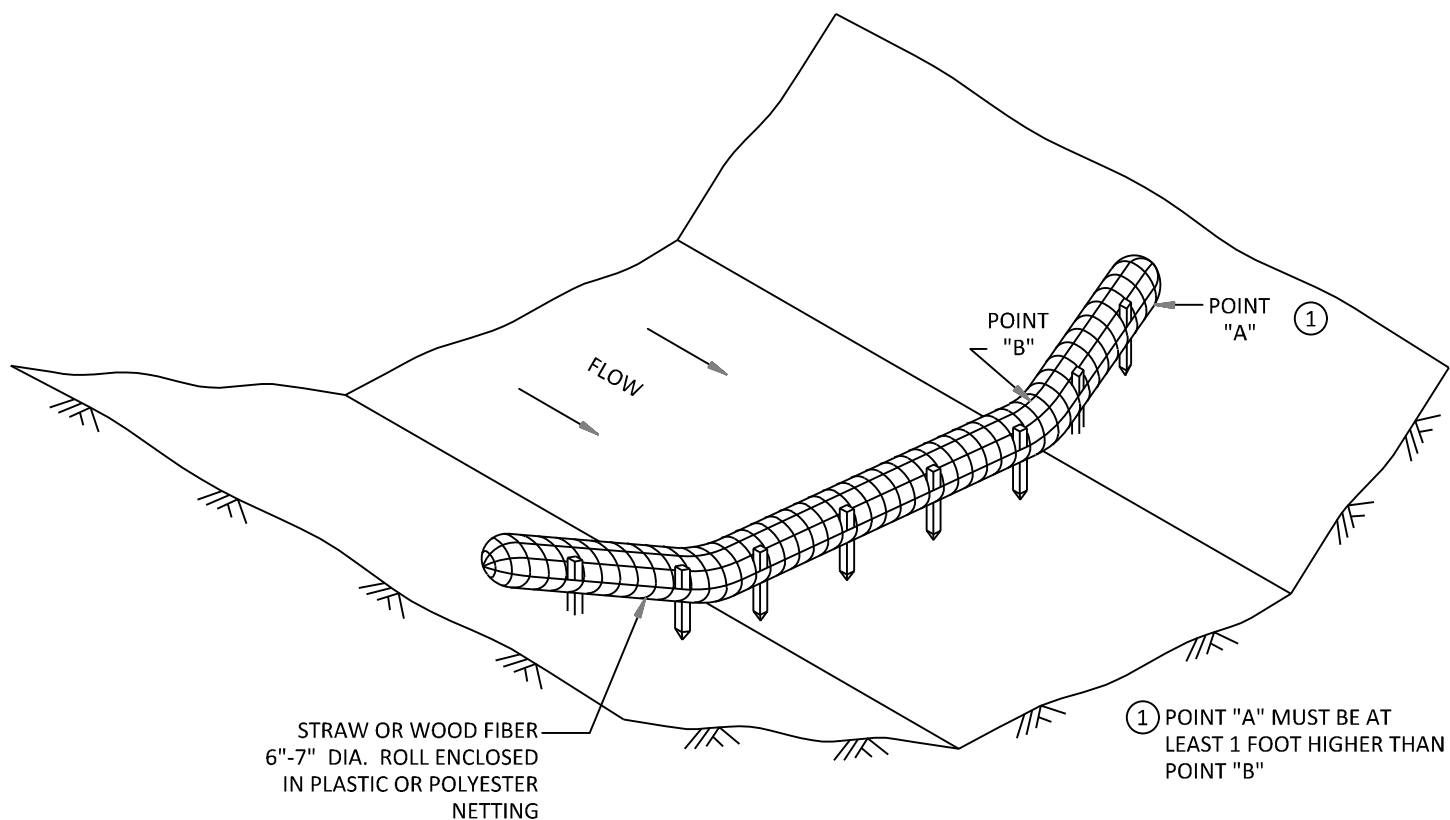


BR BIO-ROLLS

N.T.S.

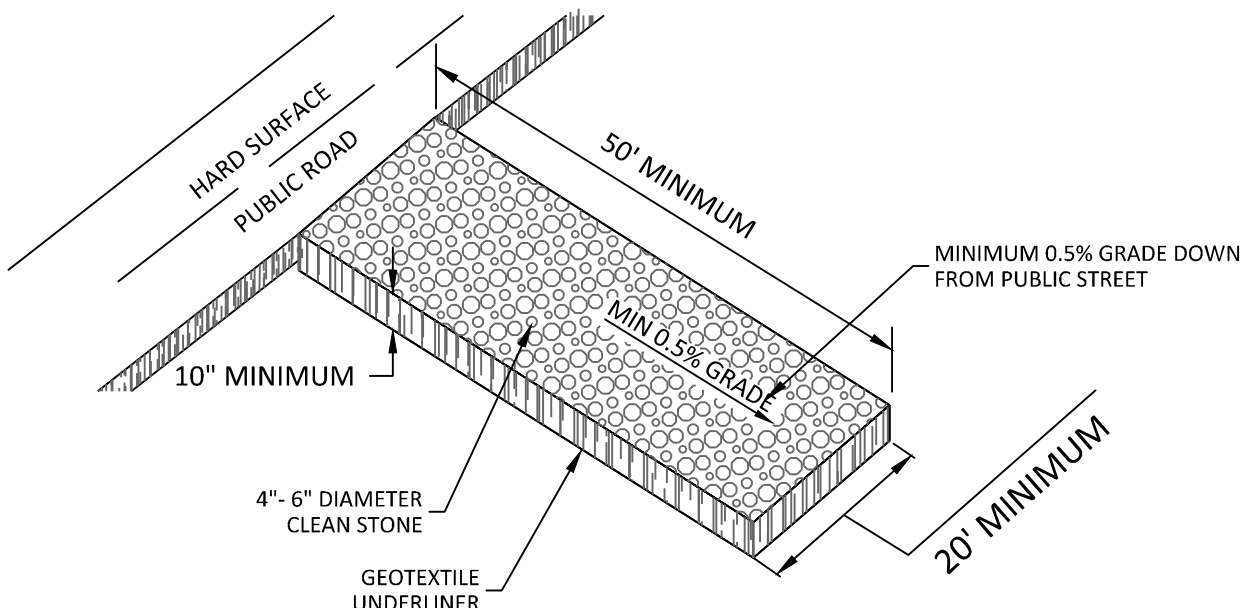

TEMPORARY STONE CONSTRUCTION EXIT

N.T.S.

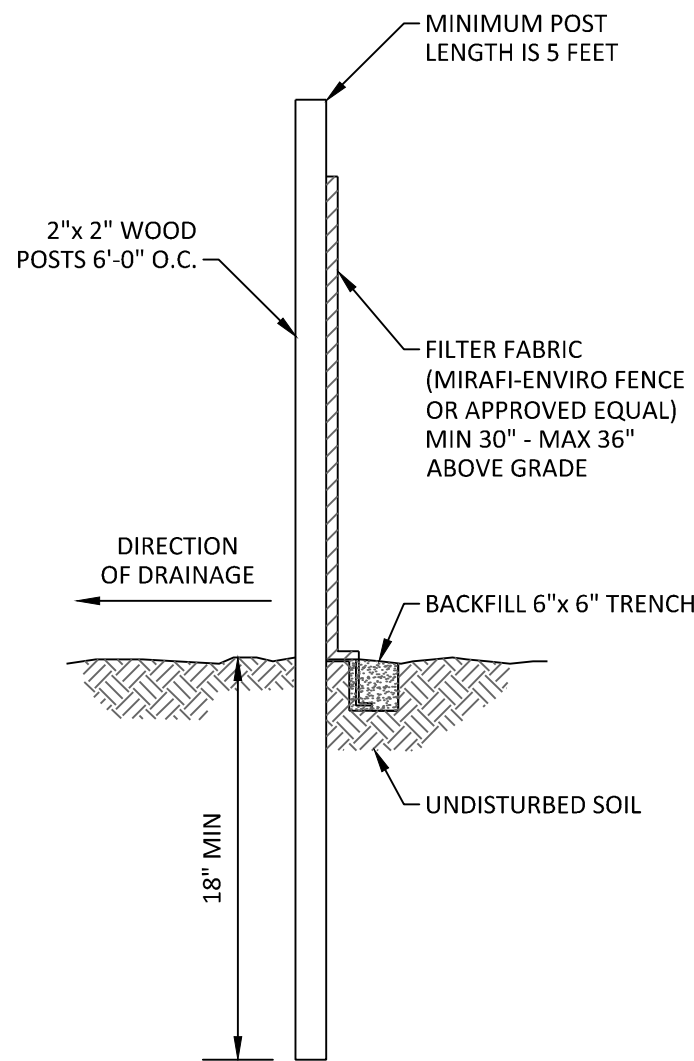


NOTES:

1. MAXIMUM SPACING BETWEEN POSTS (CENTER TO CENTER) SHALL NOT EXCEED 6 FEET IN SPACING.
2. A MINIMUM OF 5 FASTENERS PER POST

SF PREASSEMBLED SILT FENCE- WOOD POSTS (MNDOT 3886)

N.T.S.

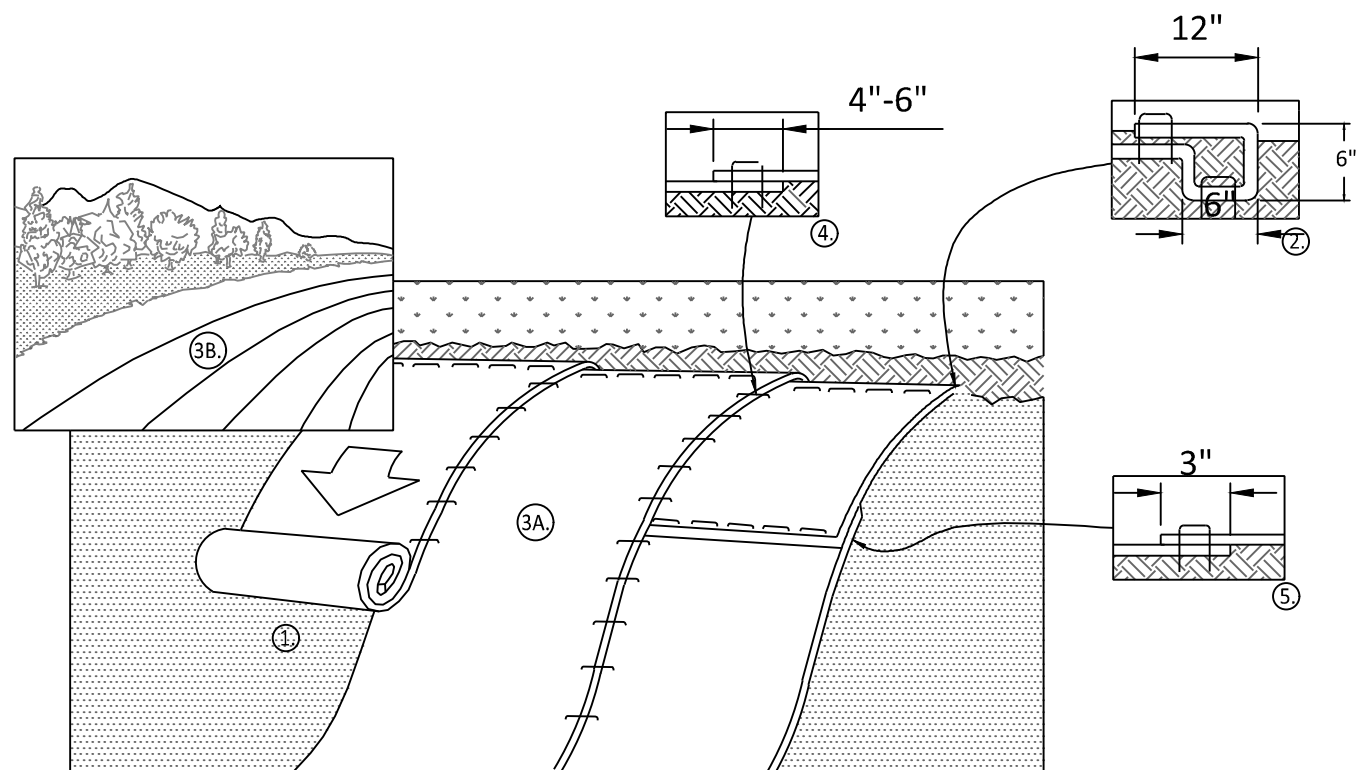

1. PREPARE SOIL BEFORE INSTALLING BLANKETS, INCLUDING ANY NECESSARY APPLICATION OF LIME, FERTILIZER, AND SEED.
2. BEGIN AT THE TOP OF THE SLOPE BY ANCHORING THE BLANKET IN A 6" DEEP X 6" WIDE TRENCH WITH APPROXIMATELY 12" OF BLANKET EXTENDED BEYOND THE UP-SLOPE PORTION OF THE TRENCH AS SHOWN IN DETAIL 2. ANCHOR THE BLANKET WITH A ROW OF STAPLES/STAKES APPROXIMATELY 12" APART IN THE BOTTOM OF THE TRENCH. BACKFILL AND COMPACT THE TRENCH AFTER STAPLING. APPLY SEED TO COMPACTED SOIL AND FOLD REMAINING 12" PORTION OF BLANKET BACK OVER SEED AND COMPACTED SOIL. SECURE BLANKET OVER COMPACTED SOIL WITH A ROW OF STAPLES/STAKES SPACED APPROXIMATELY 12" APART ACROSS THE WIDTH OF THE BLANKET.
3. ROLL THE BLANKETS (A.) DOWN OR (B.) HORIZONTALLY ACROSS THE SLOPE. BLANKETS WILL UNROLL WITH APPROPRIATE SIDE AGAINST THE SOIL SURFACE. ALL BLANKETS MUST BE SECURELY FASTENED TO SOIL SURFACE BY PLACING STAPLES/STAKES IN APPROPRIATE LOCATIONS AS PER MANUFACTURER'S RECOMMENDATION.
4. THE EDGES OF PARALLEL BLANKETS MUST BE STAPLED WITH MINIMUM 6" OVERLAP. TO ENSURE PROPER SEAM ALIGNMENT, PLACE THE EDGE OF THE OVERLAPPING BLANKET (BLANKET BEING INSTALLED ON TOP) EVEN WITH THE SEAM STITCH ON THE PREVIOUSLY INSTALLED BLANKET.
5. CONSECUTIVE BLANKETS SPICED DOWN THE SLOPE MUST BE PLACED END OVER END (SHINGLE STYLE) WITH AN APPROXIMATE 3" OVERLAP. STAPLE THROUGH OVERLAPPED AREA, APPROXIMATELY 12" APART ACROSS ENTIRE BLANKET WIDTH.
6. PLACE STAPLES/STAKES PER MANUFACTURE'S RECOMMENDATION FOR THE APPROPRIATE SLOPE BEING APPLIED.

- NOTES:
1. IN LOOSE SOIL CONDITIONS, THE USE OF STAPLE OR STAKE LENGTHS GREATER THAN 6" MAY BE NECESSARY TO PROPERLY SECURE THE BLANKETS.
  2. FOLLOW EROSION CONTROL TECHNOLOGY COUNCIL SPECIFICATION FOR PRODUCT SELECTION.

EROSION CONTROL BLANKET

NOT TO SCALE

NO	DATE	BY	CKD	APPR	COMMENT

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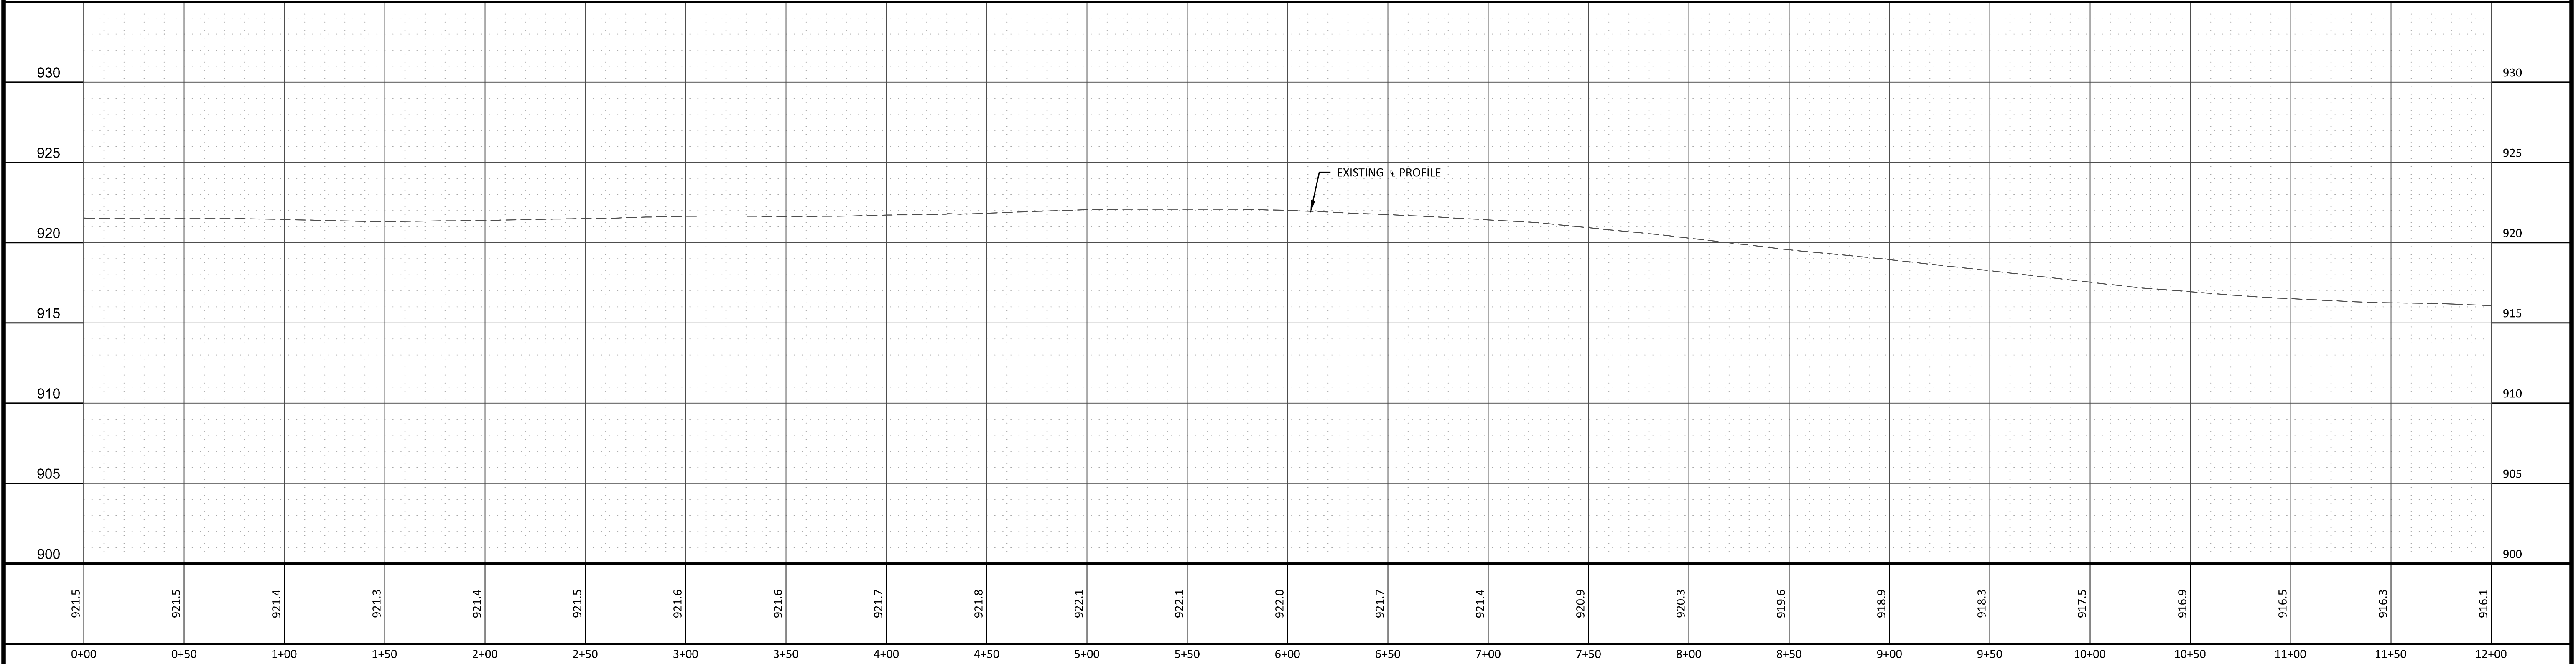
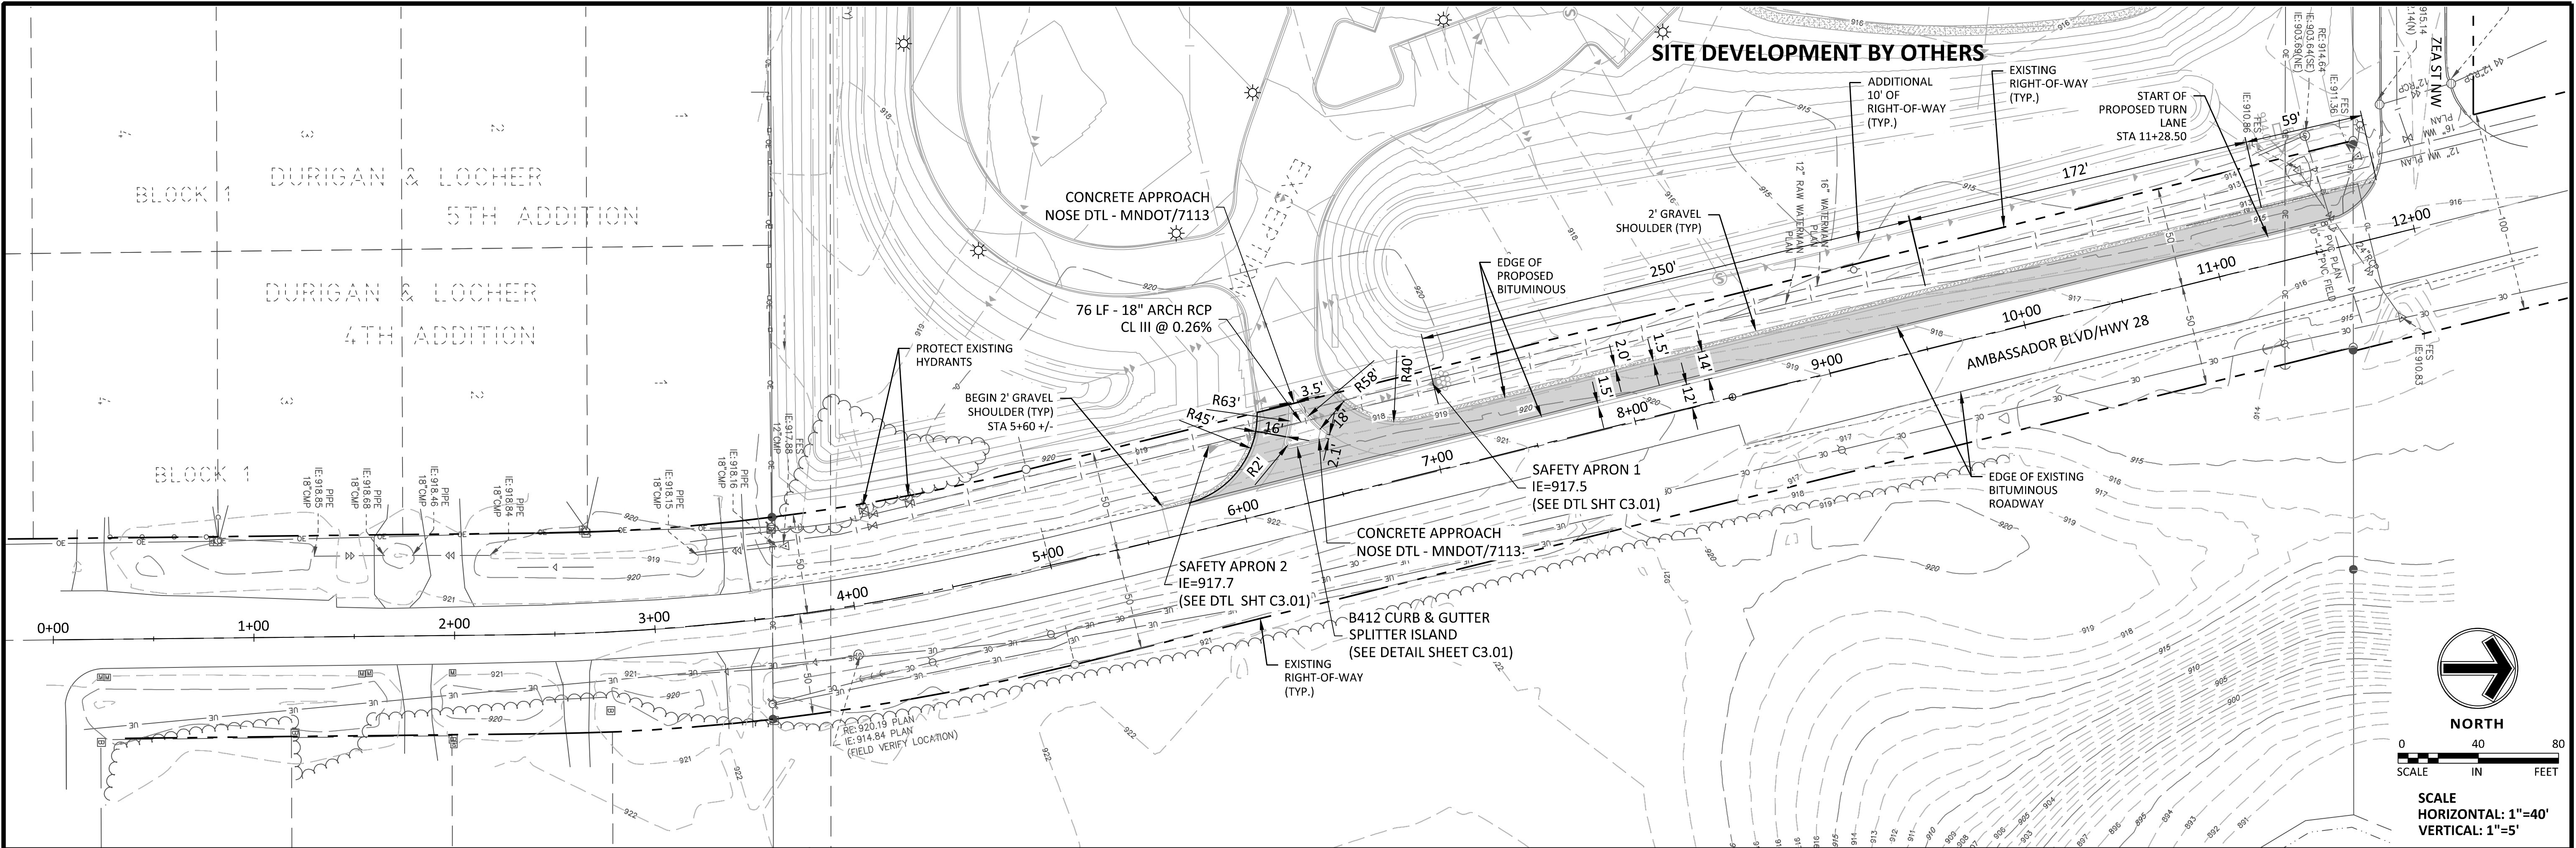
EROSION CONTROL NOTES & DETAILS

Anoka County, MN  
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SHEET  
C5.02  
6 OF 11  
REV.





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RIGHT TURN LANE PLAN

Anoka County, MN

Ambassador Blvd. Right Turn Lane

St. Francis, MN

SHEET


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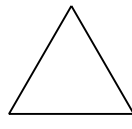
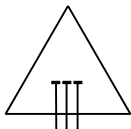
REV.

22:05 (LWS TECH) | DAVID DANZL | 9/28/2022 3:21:55 PM  
L:\PROJECTS\22377\CADD\CIVIL\SHEETS\22377-C3.01-STRT.DWG; LAYOUT 1





STRIPING KEY

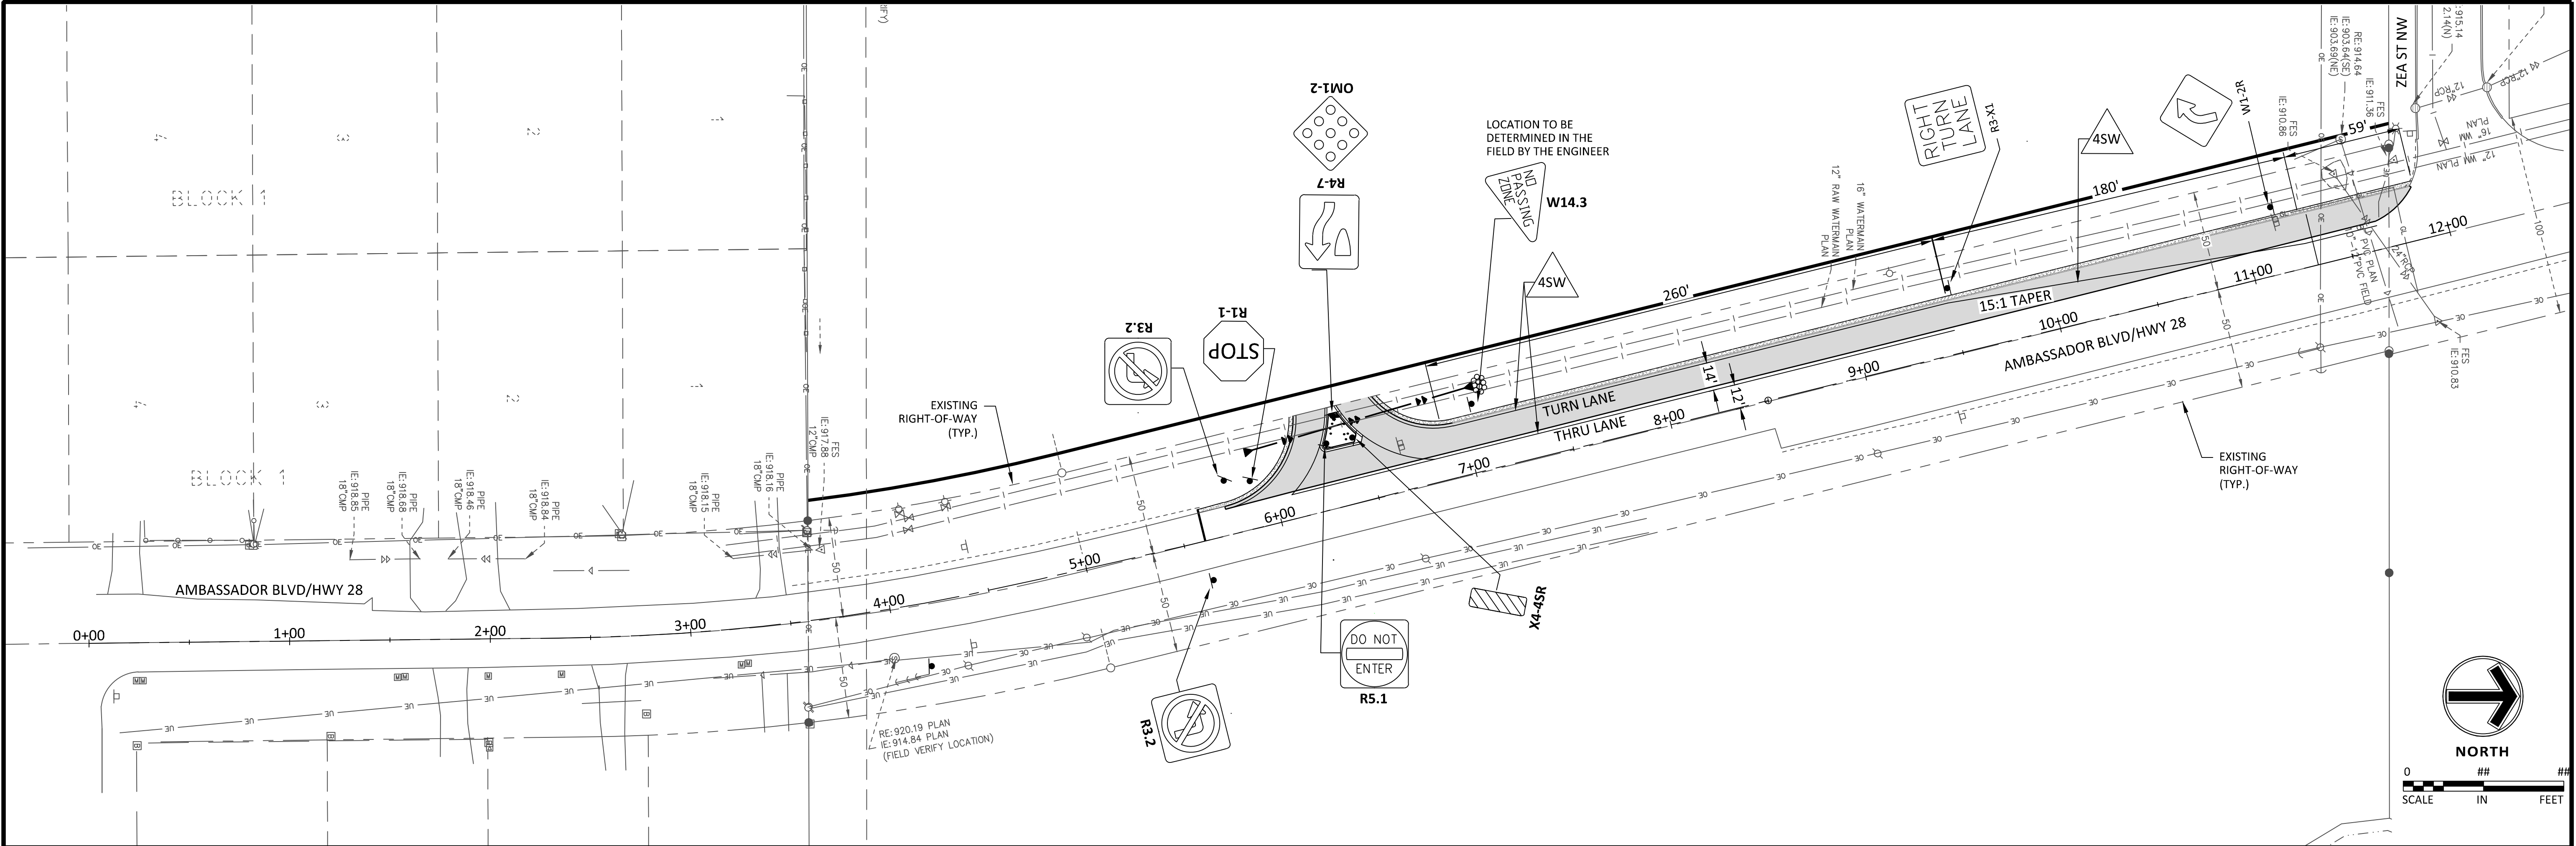

EPOXY

COLOR

W=WHITE  
Y=YELLOW


PATTERN

S=SOLID  
B=BROKEN  
D=DOUBLE  
T=DOTTED


LINE WIDTH

4=4" 24=24"  
6=6"  
12=12"


LEGEND

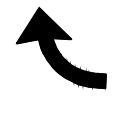

RIGHT TURN ARROW (EPOXY)

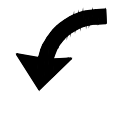

LEFT TURN ARROW (EPOXY)

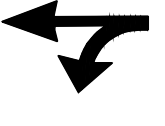

THRU-LEFT TURN ARROW (EPOXY)

- NOTES:**
- ALL STRIPING AND STREET MARKINGS SHALL BE EPOXY UNLESS OTHERWISE NOTED.
  - INSTALL NEW SIGN AT LOCATION SHOWN ON PLAN.

NO	DATE	BY	CKD	APPR	COMMENT

I hereby certify that this plan, specification, or report was prepared by me or under my direct supervision and that I am a duly licensed Professional Engineer under the laws of the State of Minnesota.

Print Name: Michael Nielson



Date 08/29/2022 License # 23623

PRELIMINARY

DESIGN REVIEW

PERMIT SUBMITTAL

CONSTRUCTION DOCUMENTS

DRAWN BY DJD

DESIGNED BY JJG

CHECKED BY MJN

PROJECT NO. 22377



**Sambatek**  
www.sambatek.com

Engineering | Surveying | Planning | Environmental

SIGNING AND STRIPING PLAN

Anoka County, MN

Ambassador Blvd. Right Turn Lane

St. Francis, MN

SHEET


**C7.01**

8 OF 11

REV.



22:05 (LWS TECH) | DAVID DANZL | 8/25/2022 12:50:14 PM  
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GENERAL NOTES FOR TRAFFIC CONTROL:

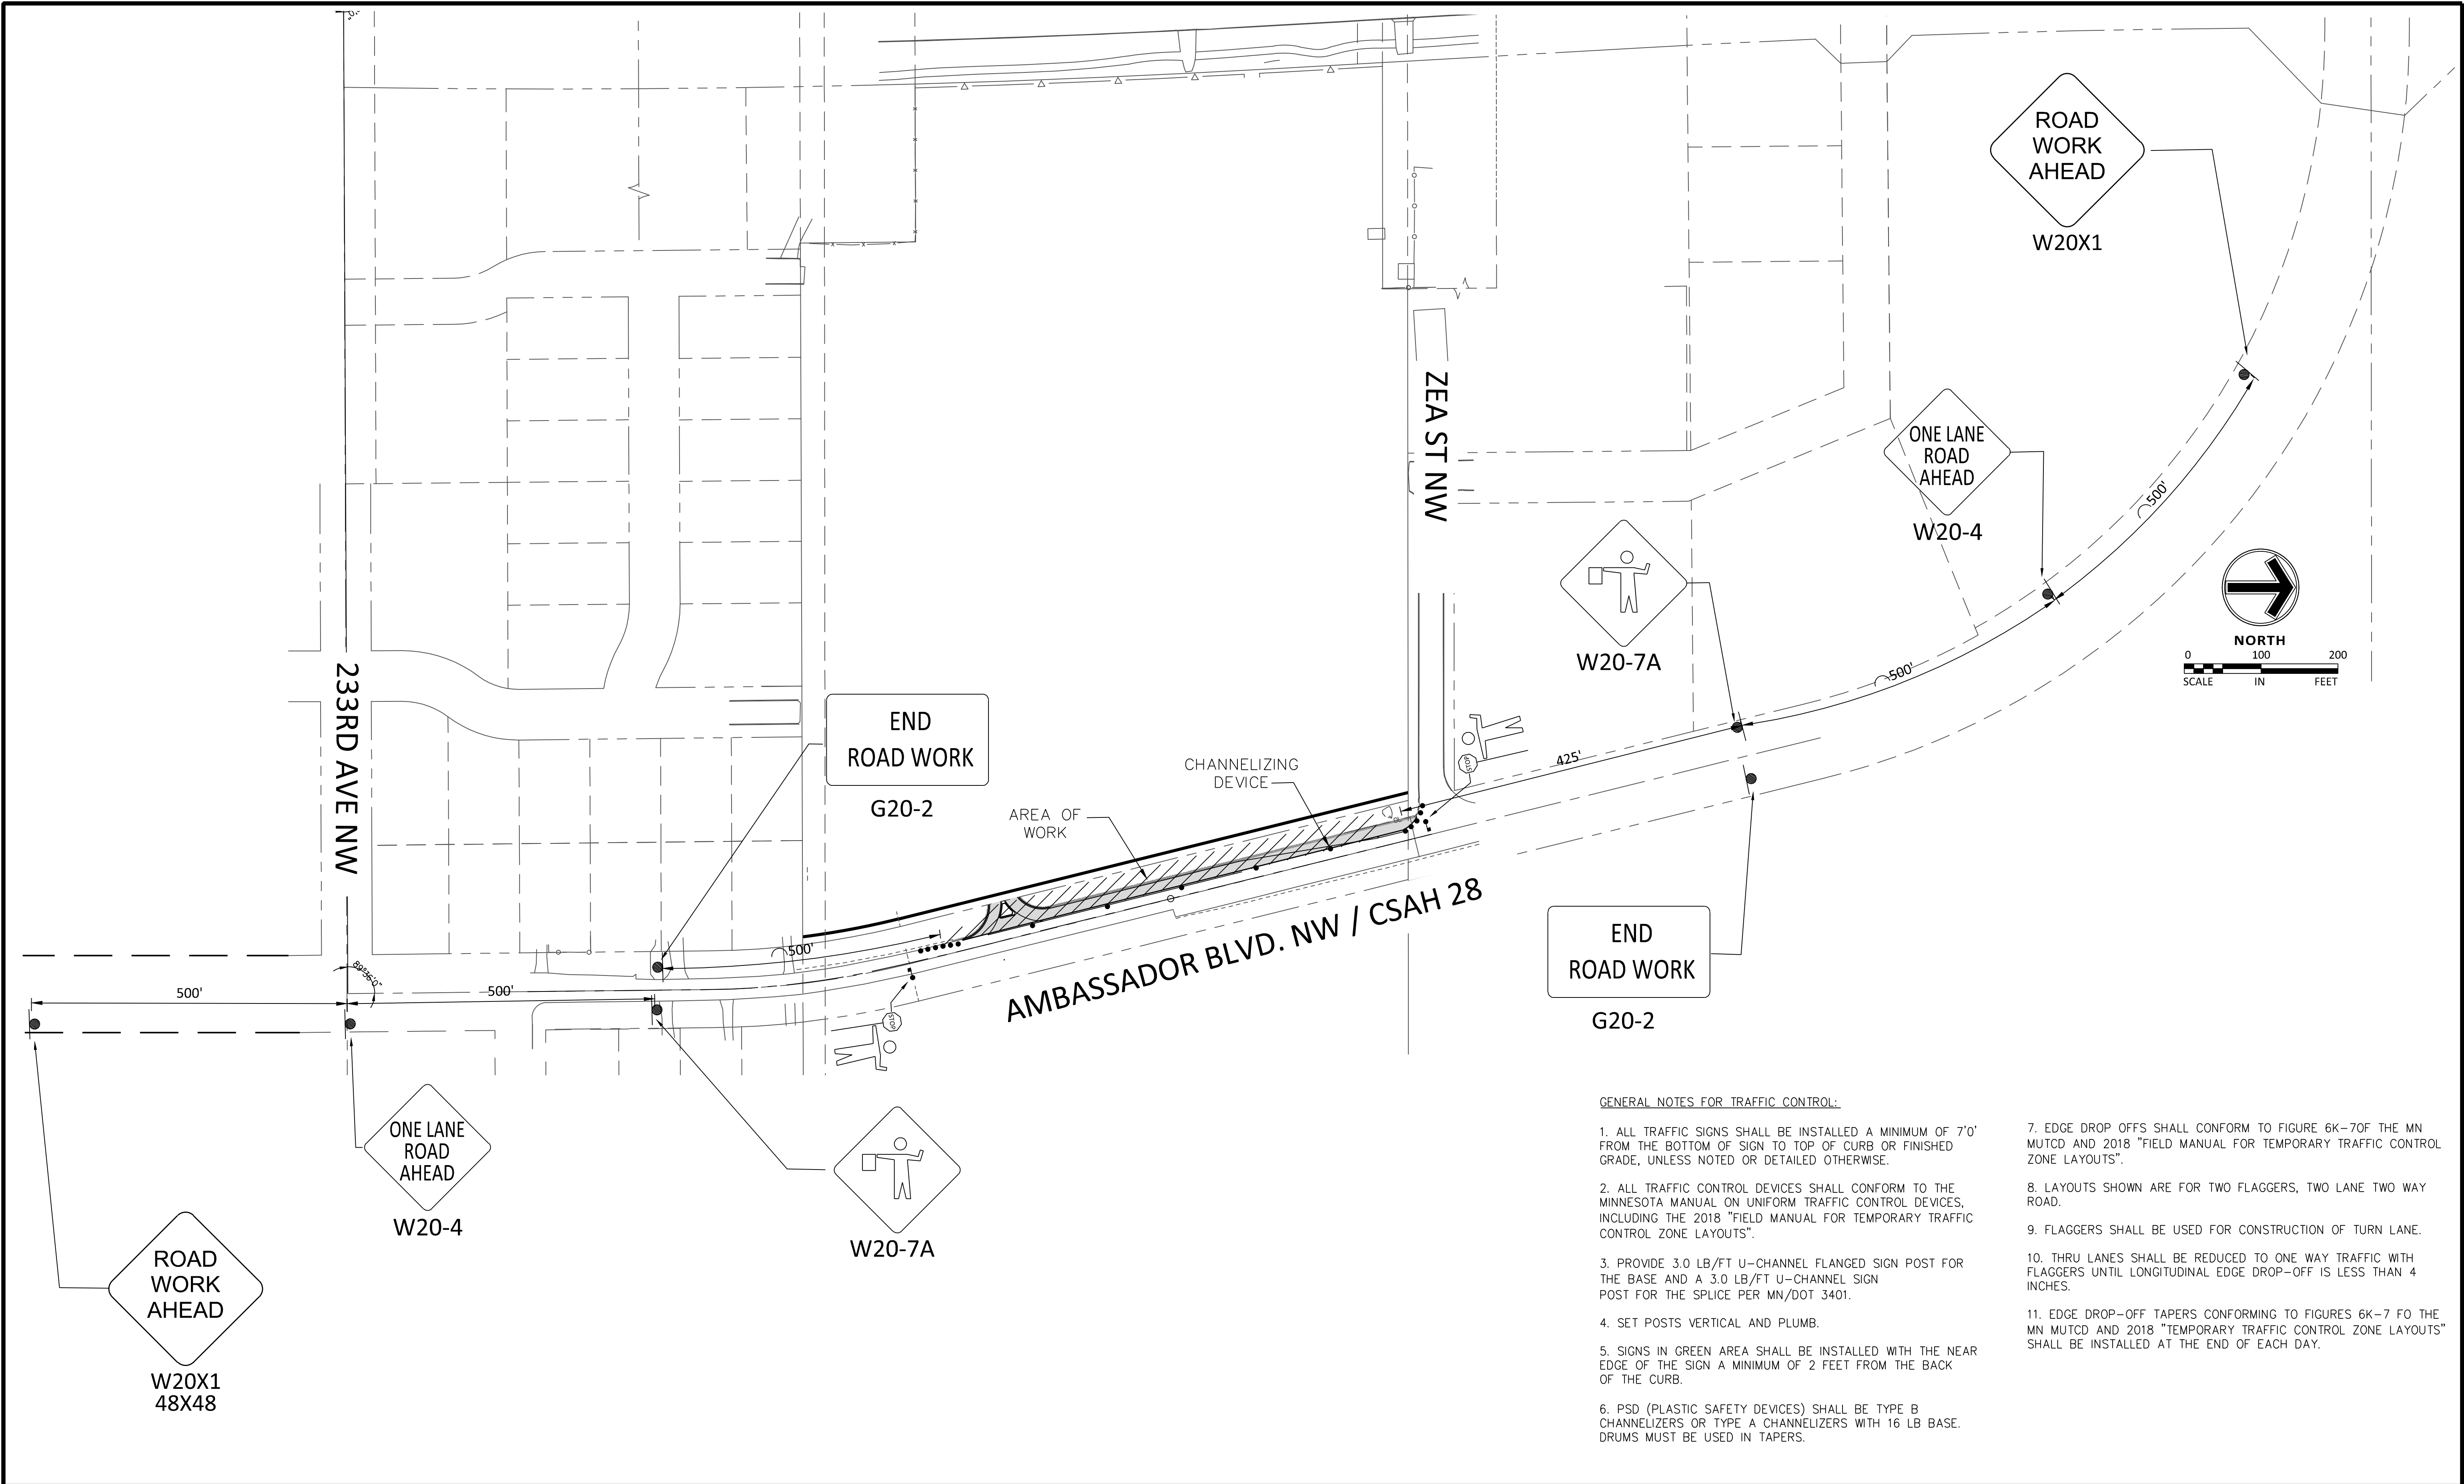1. ALL TRAFFIC SIGNS SHALL BE INSTALLED A MINIMUM OF 7'0" FROM THE BOTTOM OF SIGN TO TOP OF CURB OR FINISHED GRADE, UNLESS NOTED OR DETAILED OTHERWISE.
2. ALL TRAFFIC CONTROL DEVICES SHALL CONFORM TO THE MINNESOTA MANUAL ON UNIFORM TRAFFIC CONTROL DEVICES, INCLUDING THE 2018 "FIELD MANUAL FOR TEMPORARY TRAFFIC CONTROL ZONE LAYOUTS".
3. PROVIDE 3.0 LB/FT U-CHANNEL FLANGED SIGN POST FOR THE BASE AND A 3.0 LB/FT U-CHANNEL SIGN POST FOR THE SPLICE PER MN/DOT 3401.
4. SET POSTS VERTICAL AND PLUMB.
5. SIGNS IN GREEN AREA SHALL BE INSTALLED WITH THE NEAR EDGE OF THE SIGN A MINIMUM OF 2 FEET FROM THE BACK OF THE CURB.
6. PSD (PLASTIC SAFETY DEVICES) SHALL BE TYPE B CHANNELIZERS OR TYPE A CHANNELIZERS WITH 16 LB BASE. DRUMS MUST BE USED IN TAPERS.
7. EDGE DROP-OFFS SHALL CONFORM TO FIGURE 6K-70F THE MN MUTCD AND 2018 "FIELD MANUAL FOR TEMPORARY TRAFFIC CONTROL ZONE LAYOUTS".
8. LAYOUTS SHOWN ARE FOR TWO FLAGGERS, TWO LANE TWO WAY ROAD.
9. FLAGGERS SHALL BE USED FOR CONSTRUCTION OF TURN LANE.
10. THRU LANES SHALL BE REDUCED TO ONE WAY TRAFFIC WITH FLAGGERS UNTIL LONGITUDINAL EDGE DROP-OFF IS LESS THAN 4 INCHES.
11. EDGE DROP-OFF TAPERS CONFORMING TO FIGURES 6K-7 FO THE MN MUTCD AND 2018 "TEMPORARY TRAFFIC CONTROL ZONE LAYOUTS" SHALL BE INSTALLED AT THE END OF EACH DAY.

NO	DATE	BY	CKD	APPR	COMMENT

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*Michael Nielson*

Date 08/29/2022 License # 23623

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PROJECT NO. 22377



TRAFFIC CONTROL PLAN

Anoka County, MN

Ambassador Blvd. Right Turn Lane

St. Francis, MN

SHEET

C7.02

9 OF 11

REV.



22.05 (LWS TECH) | DAVID DANZL | 8/2/2022 9:28:01 AM  
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*Michael Nielson*

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DJD

DESIGNED BY  
JJG

CHECKED BY  
MJN

PROJECT NO.  
22377



CROSS SECTIONS

Anoka County, MN  
Ambassador Blvd. Right Turn Lane









St. Francis, MN

SHEET

**C8.01**

10 OF 11

REV.

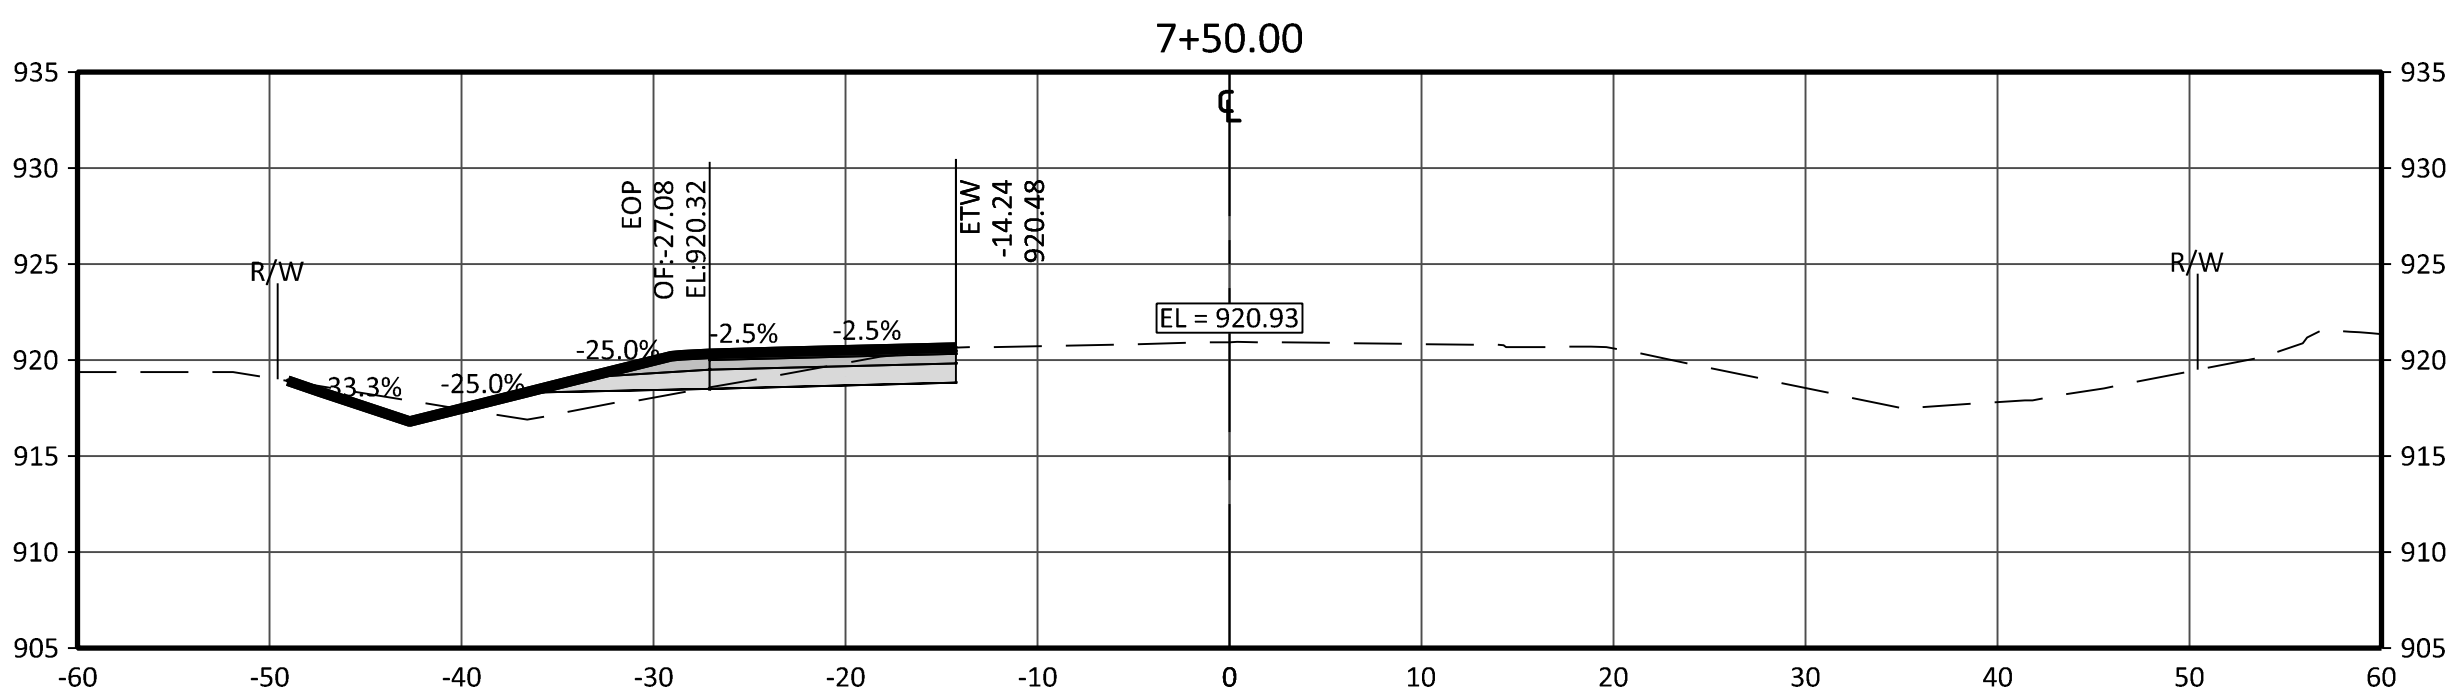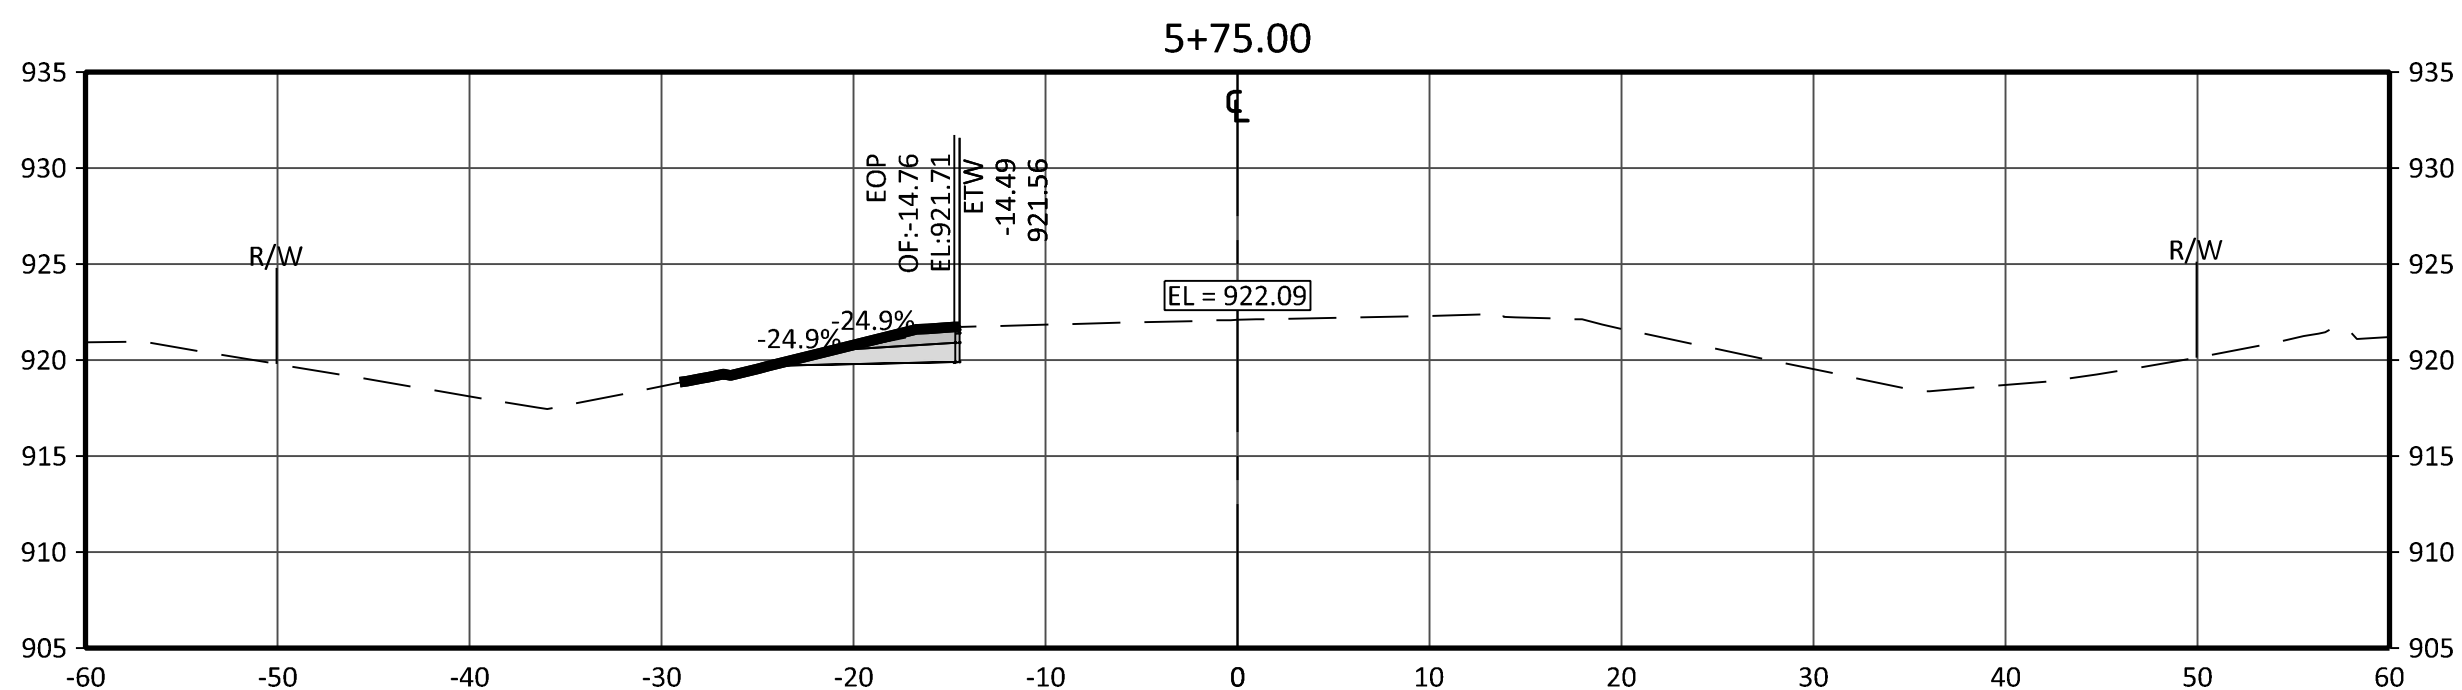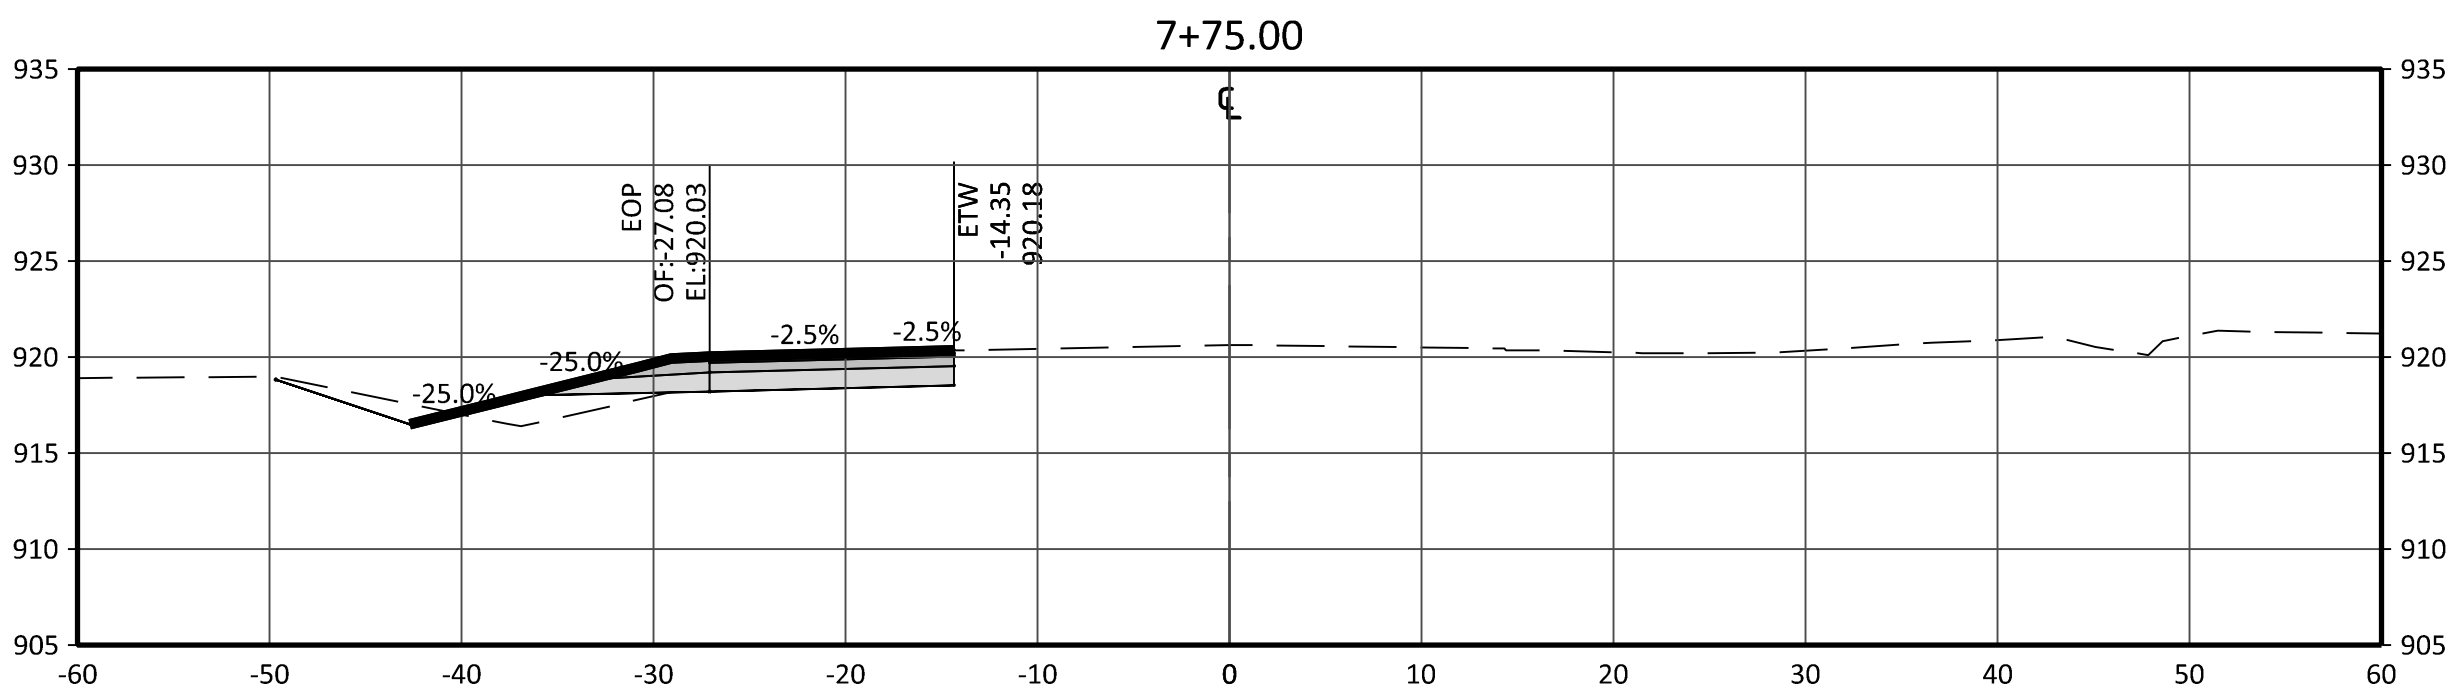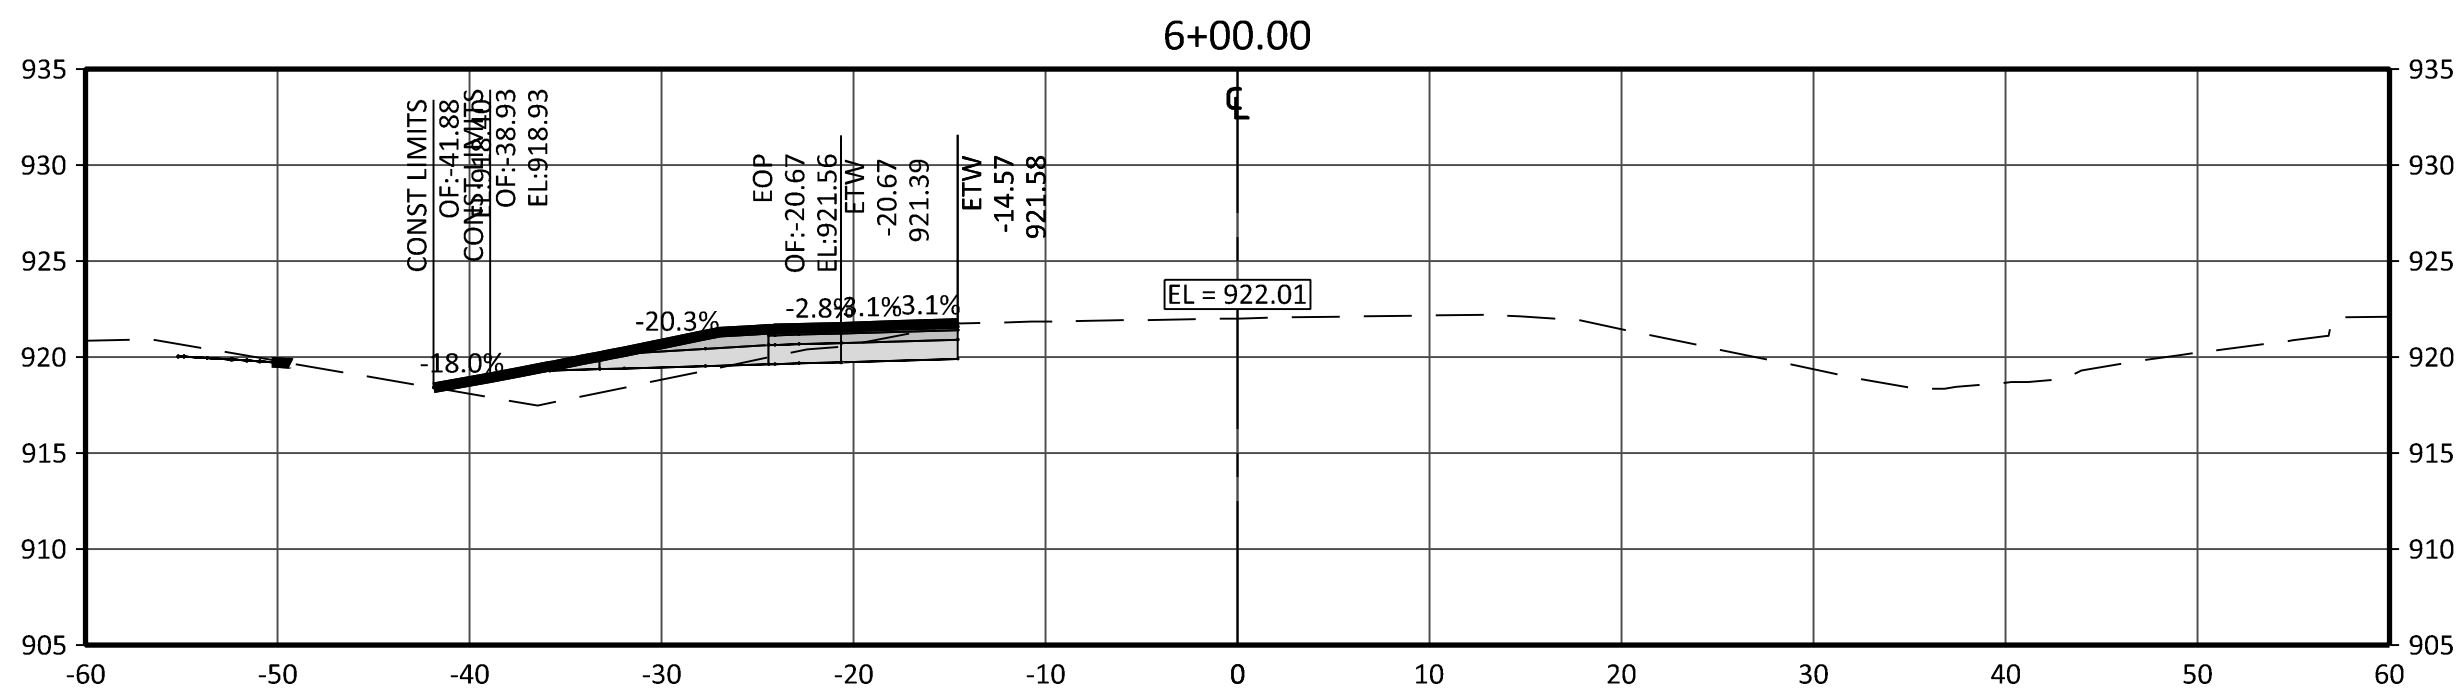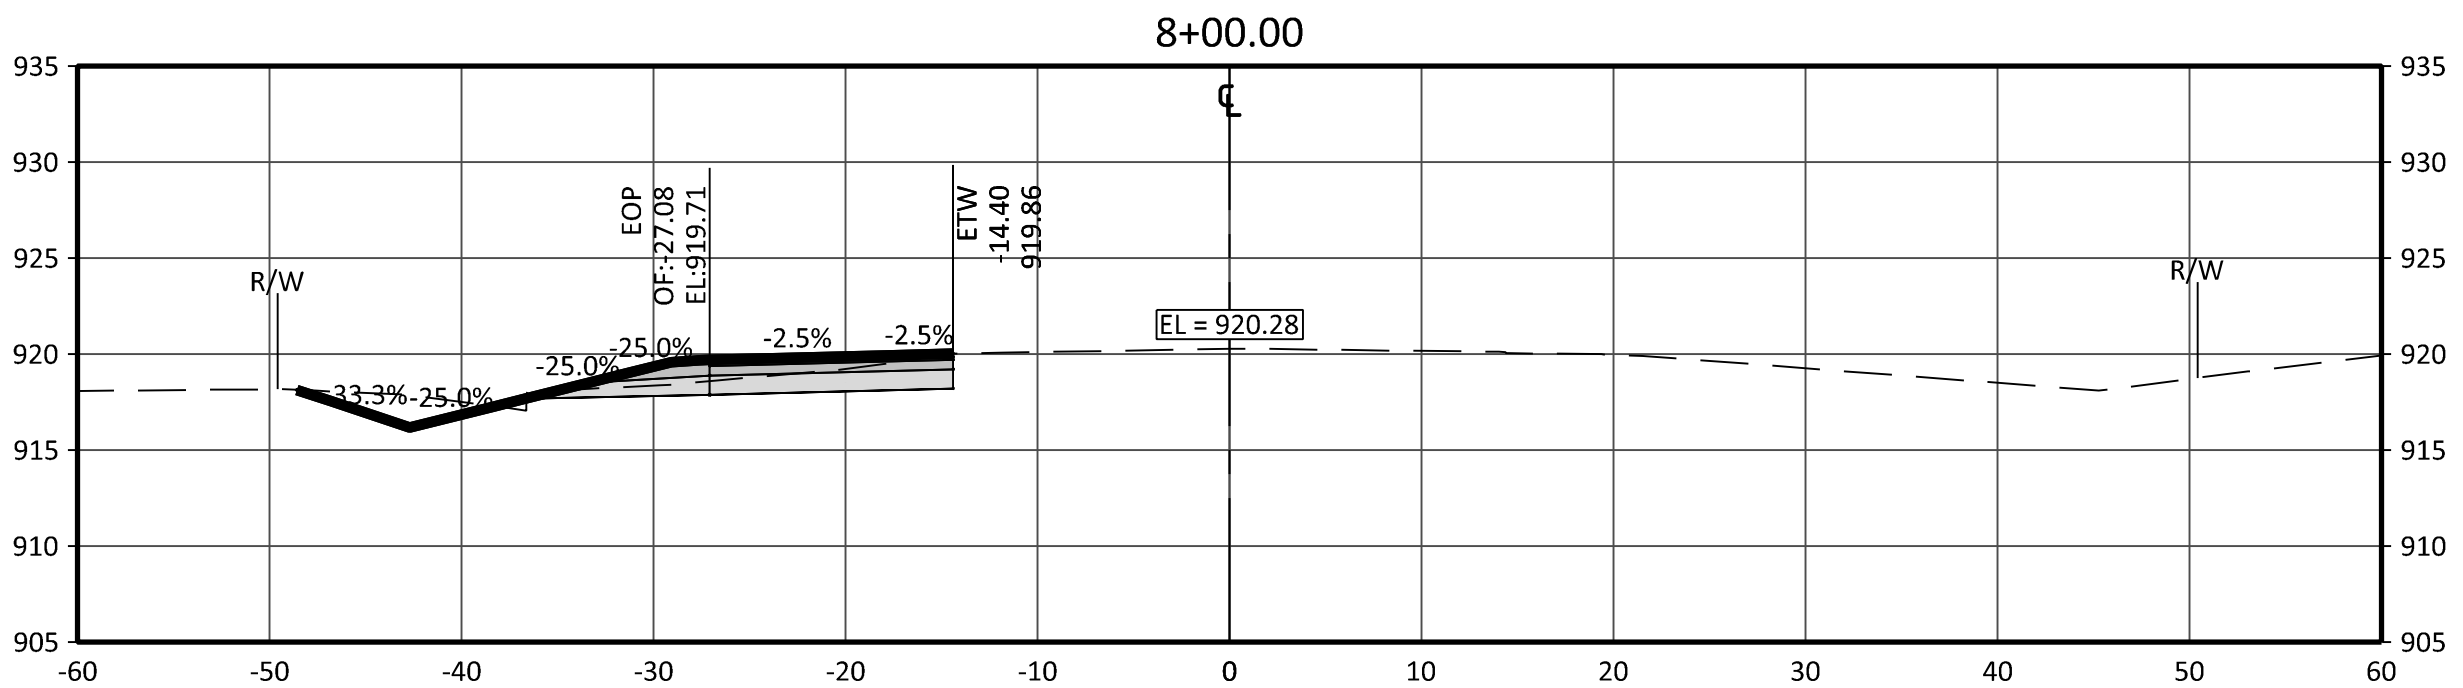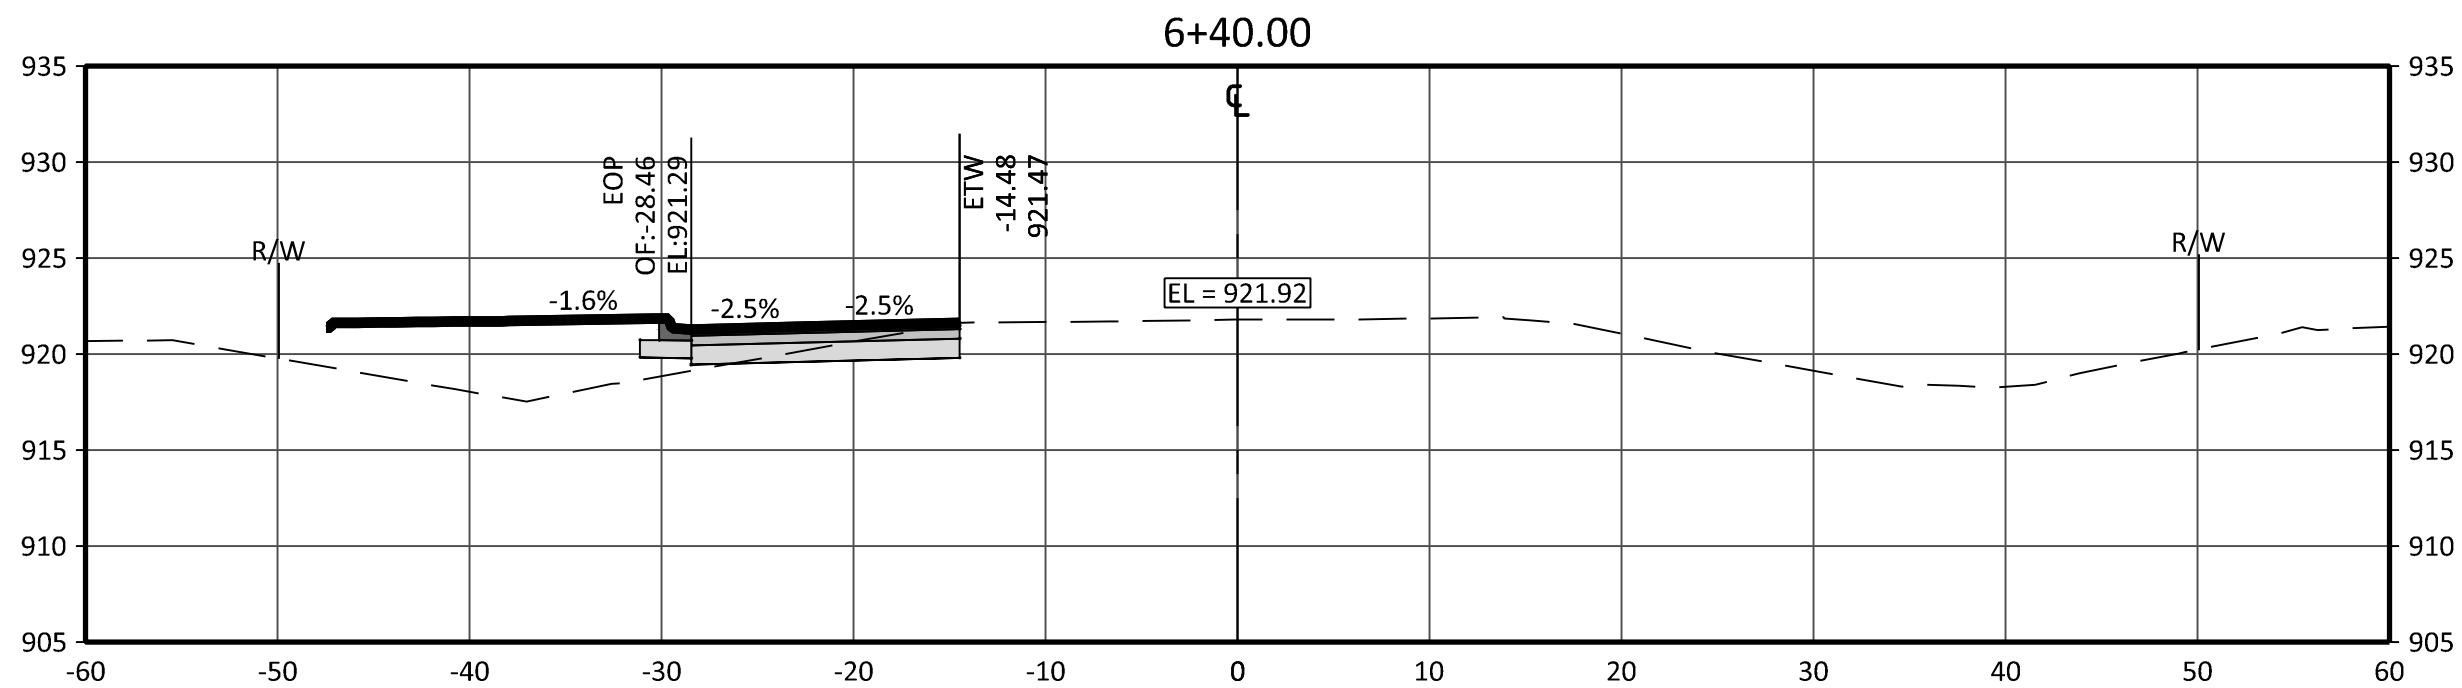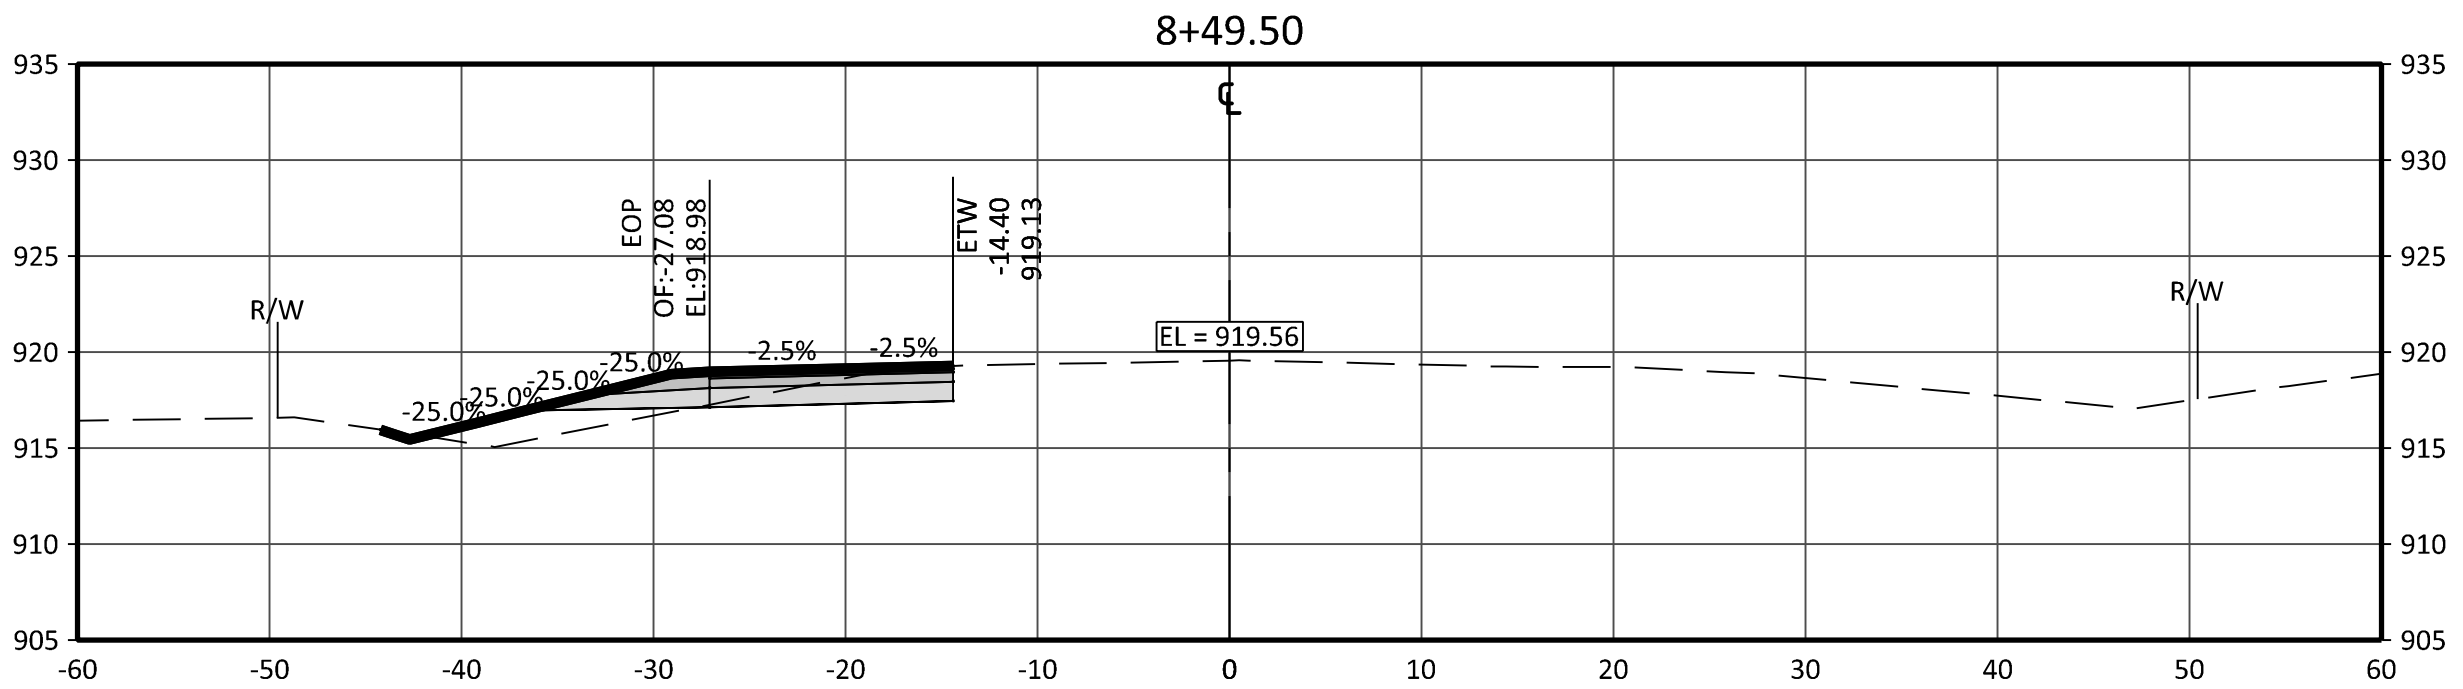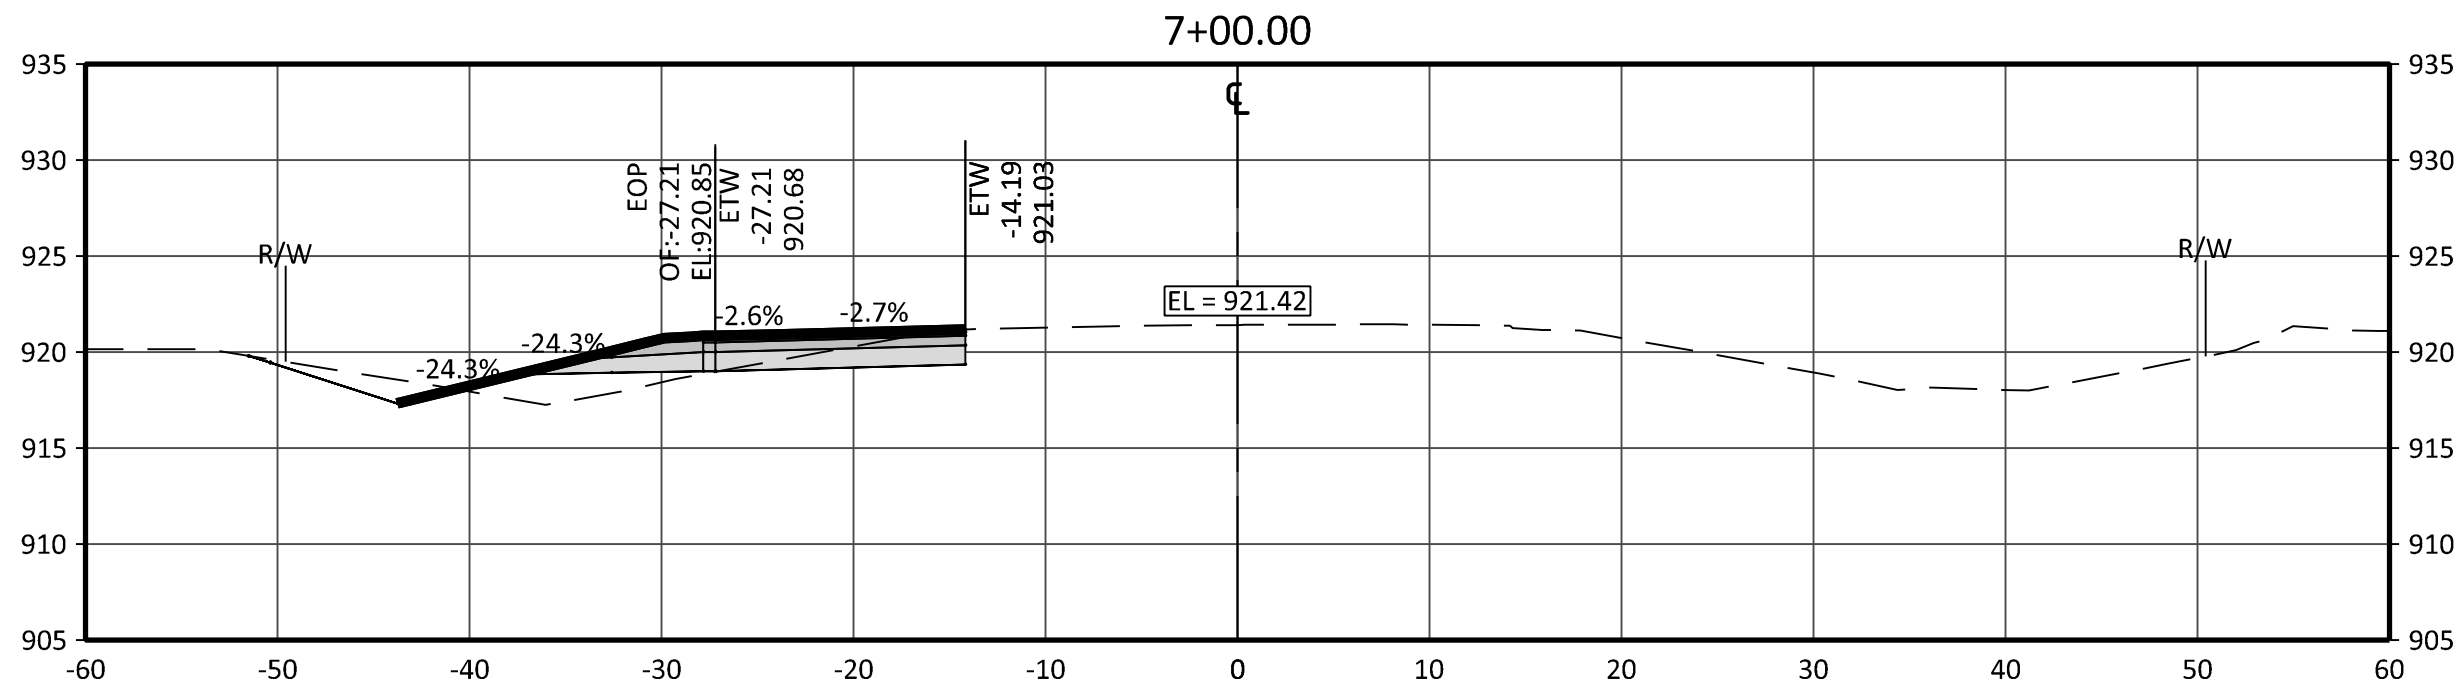








**LEGEND**

R/W = RIGHT-OF-WAY  
C = CENTERLINE OF ROAD  
OF = CENTERLINE OFFSET  
EL = ELEVATION  
ETW = EDGE OF TRAVEL WAY  
EOP = EDGE OF PAVEMENT

SCALE  
HORIZONTAL: 1"=10'  
VERTICAL: 1"=10'



22.05 (LWS TECH) | DAVID DANZL | 8/2/2022 9:28:01 AM  
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**LEGEND**  
R/W = RIGHT-OF-WAY  
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OF = CENTERLINE OFFSET  
EL = ELEVATION  
ETW = EDGE OF TRAVEL WAY  
EOP = EDGE OF PAVEMENT
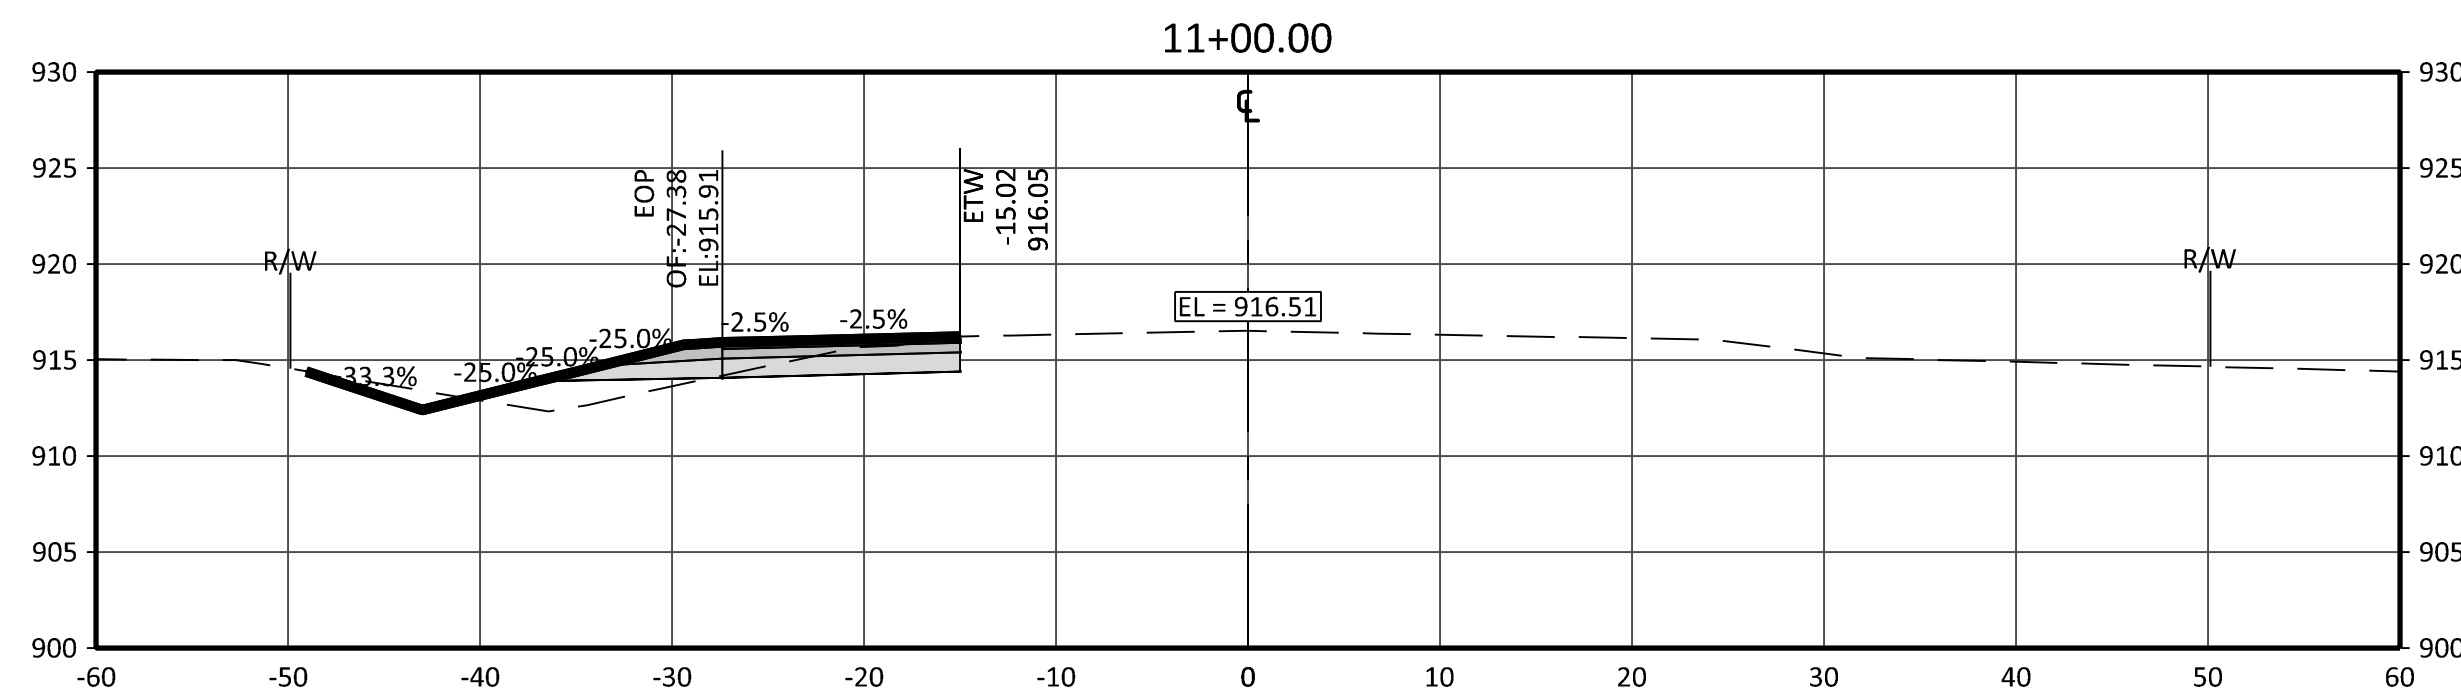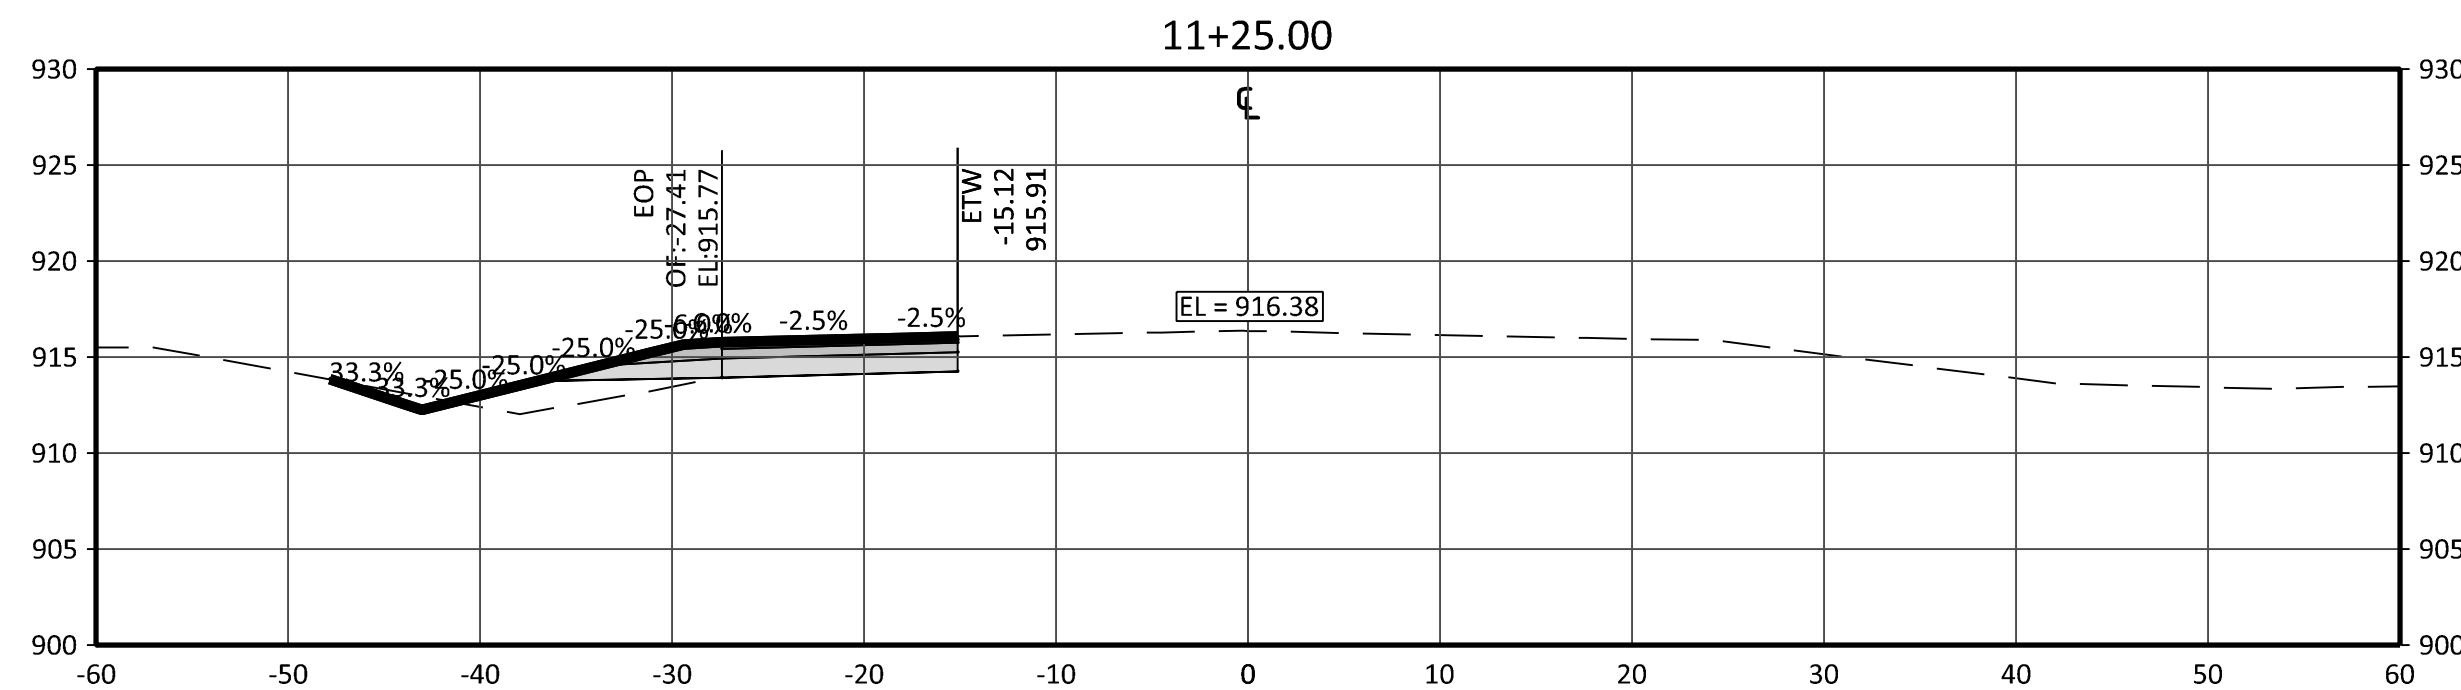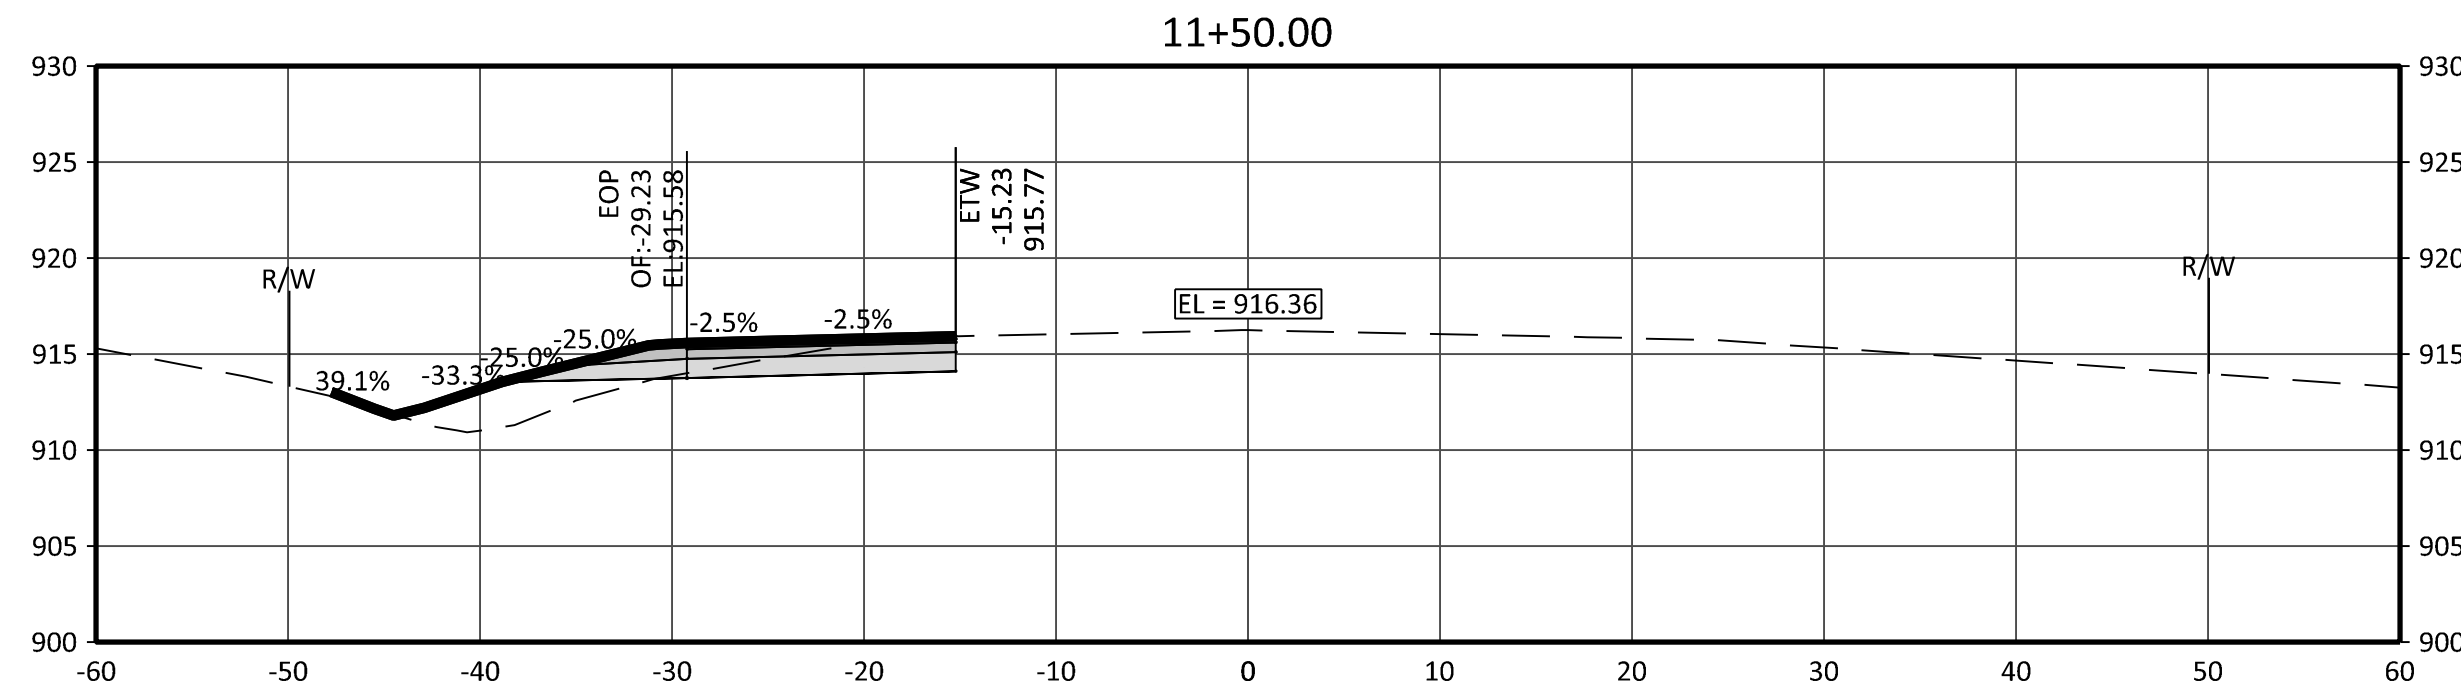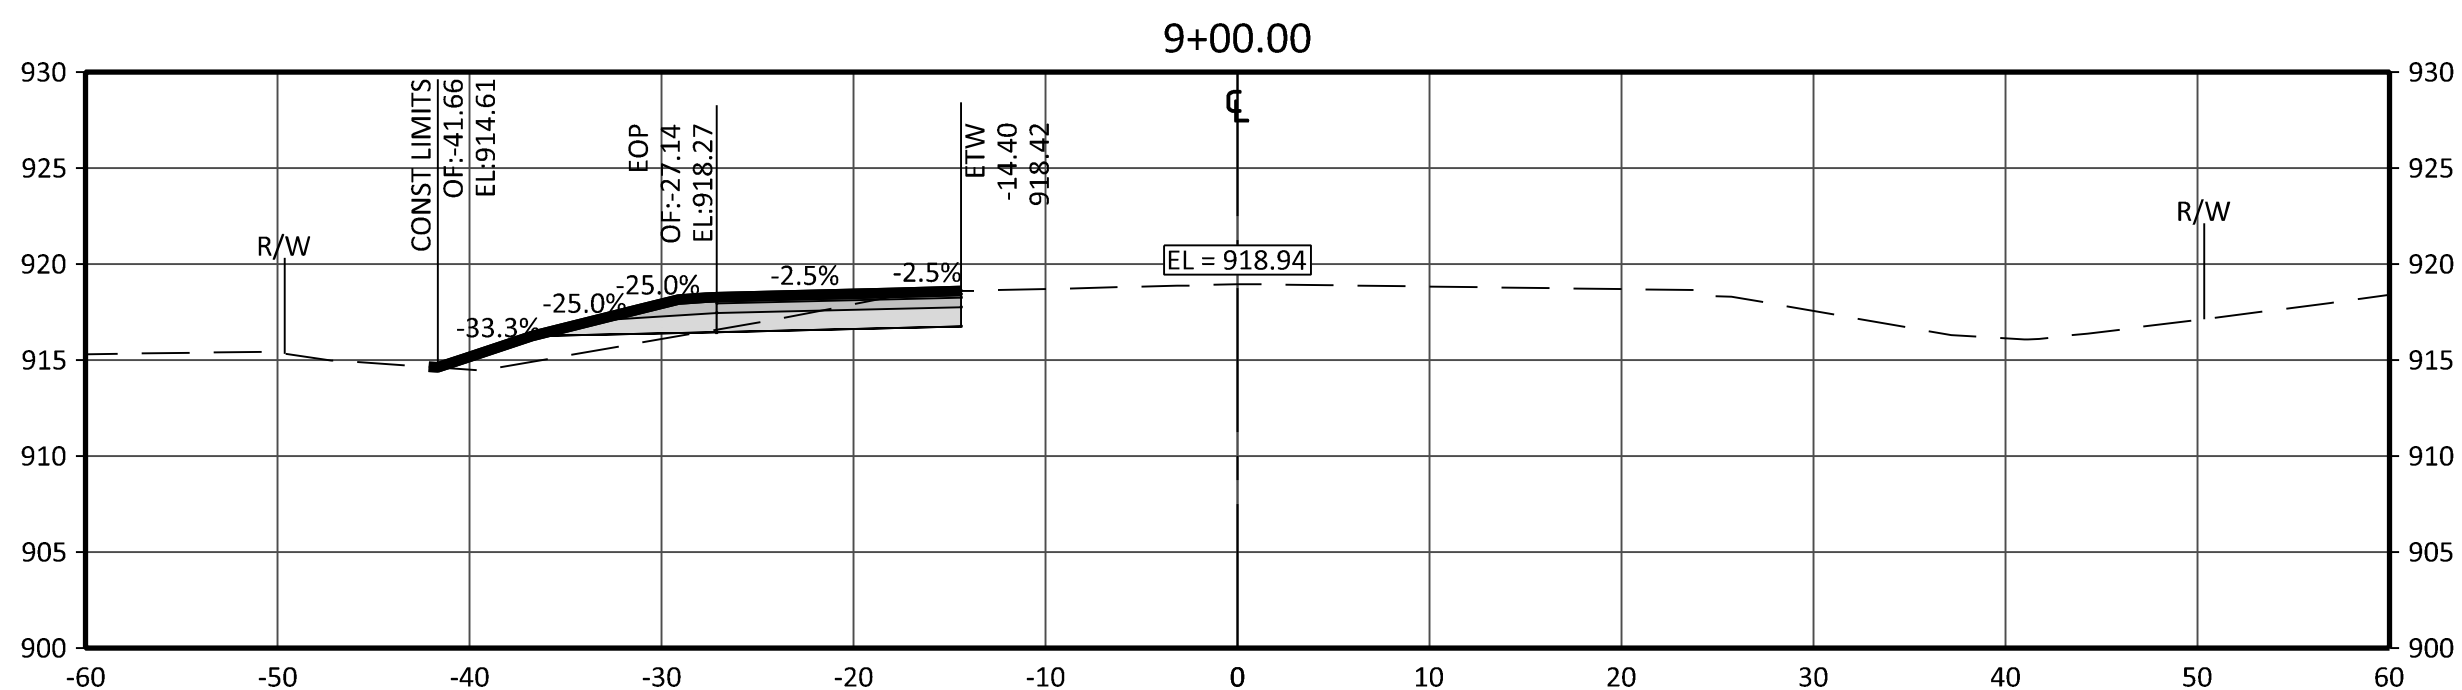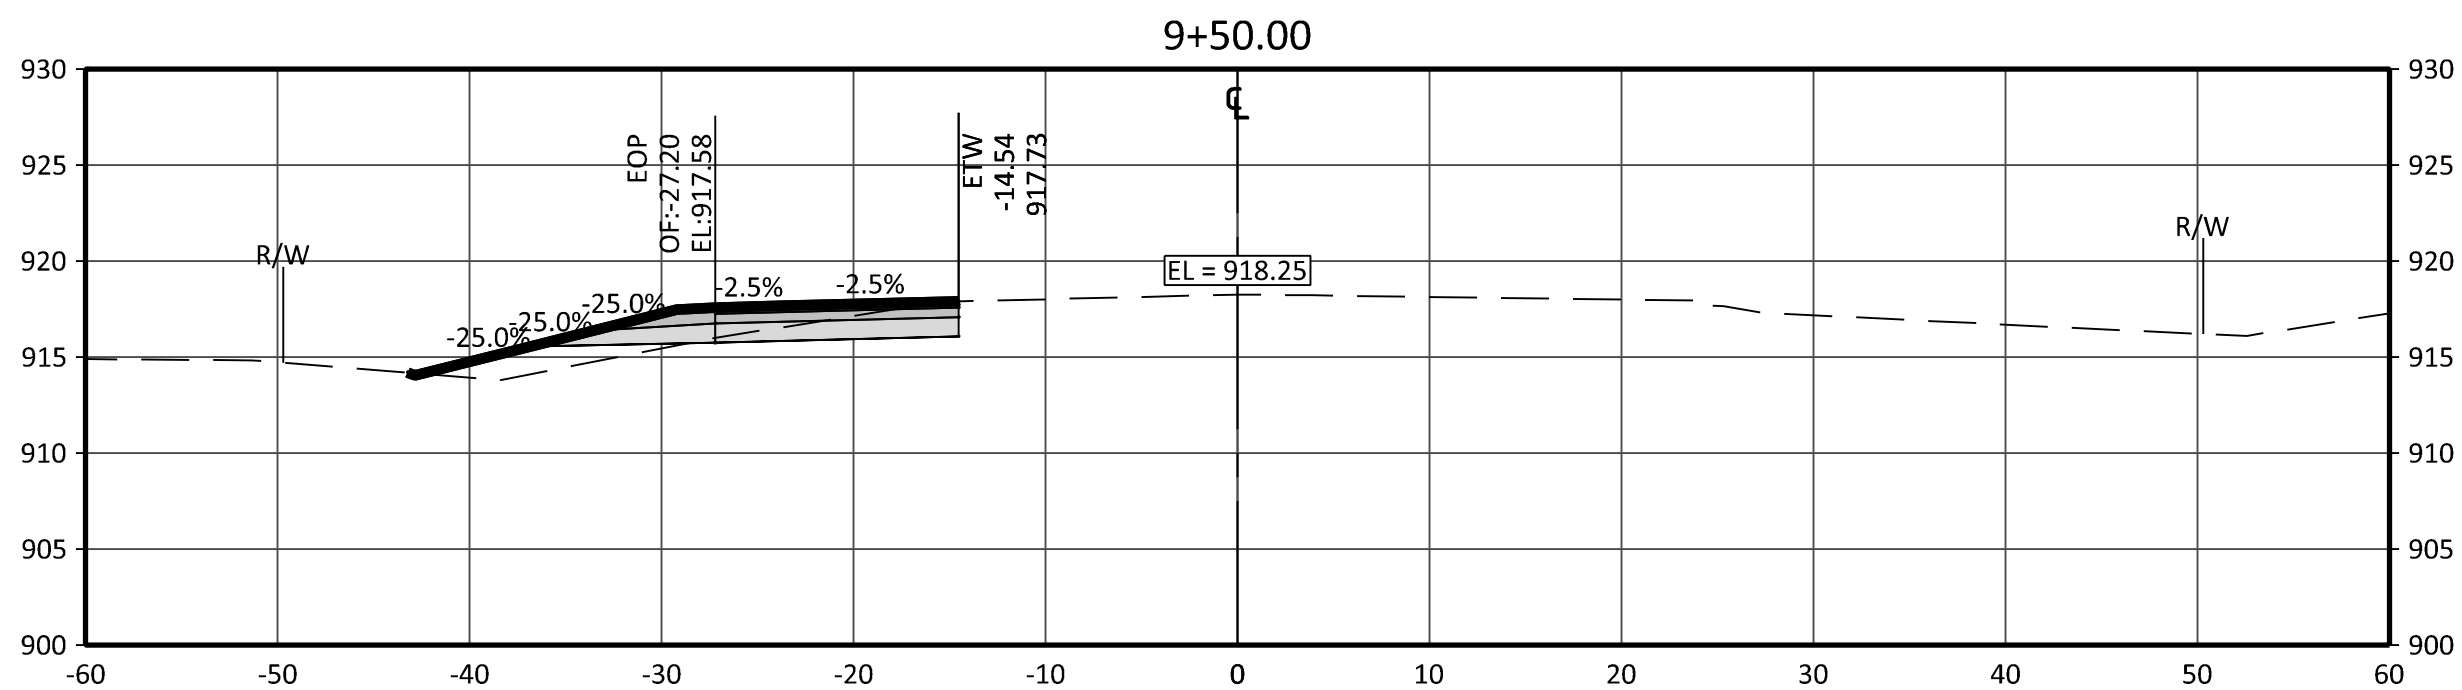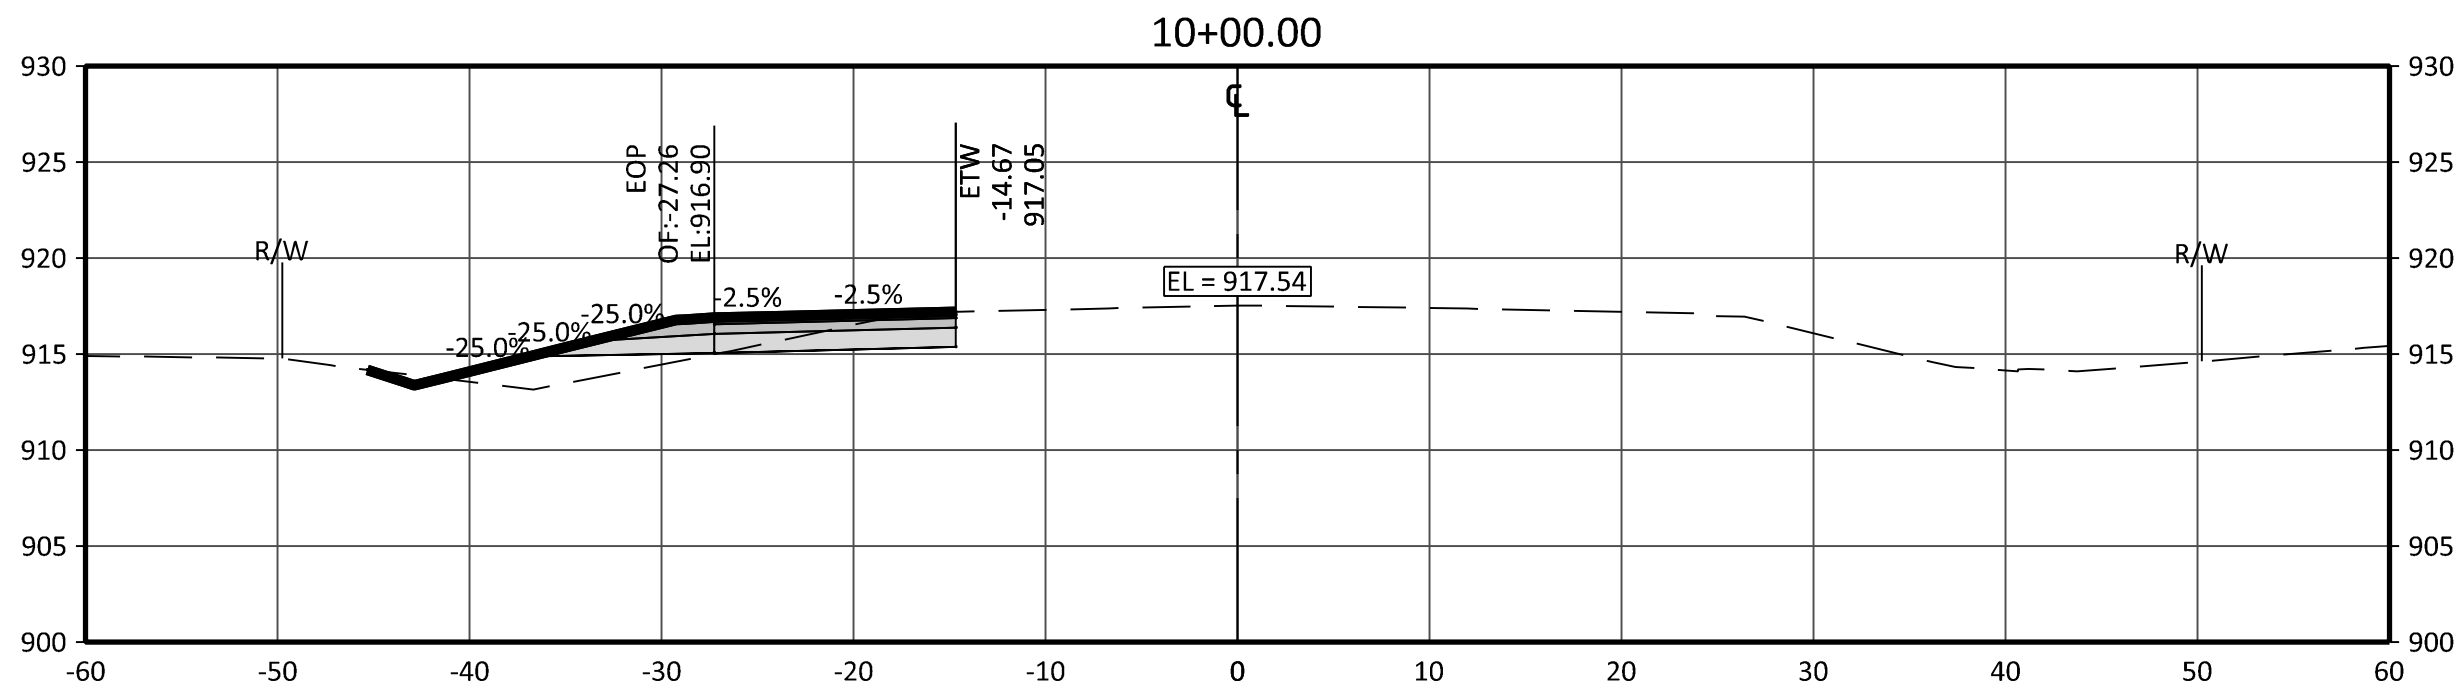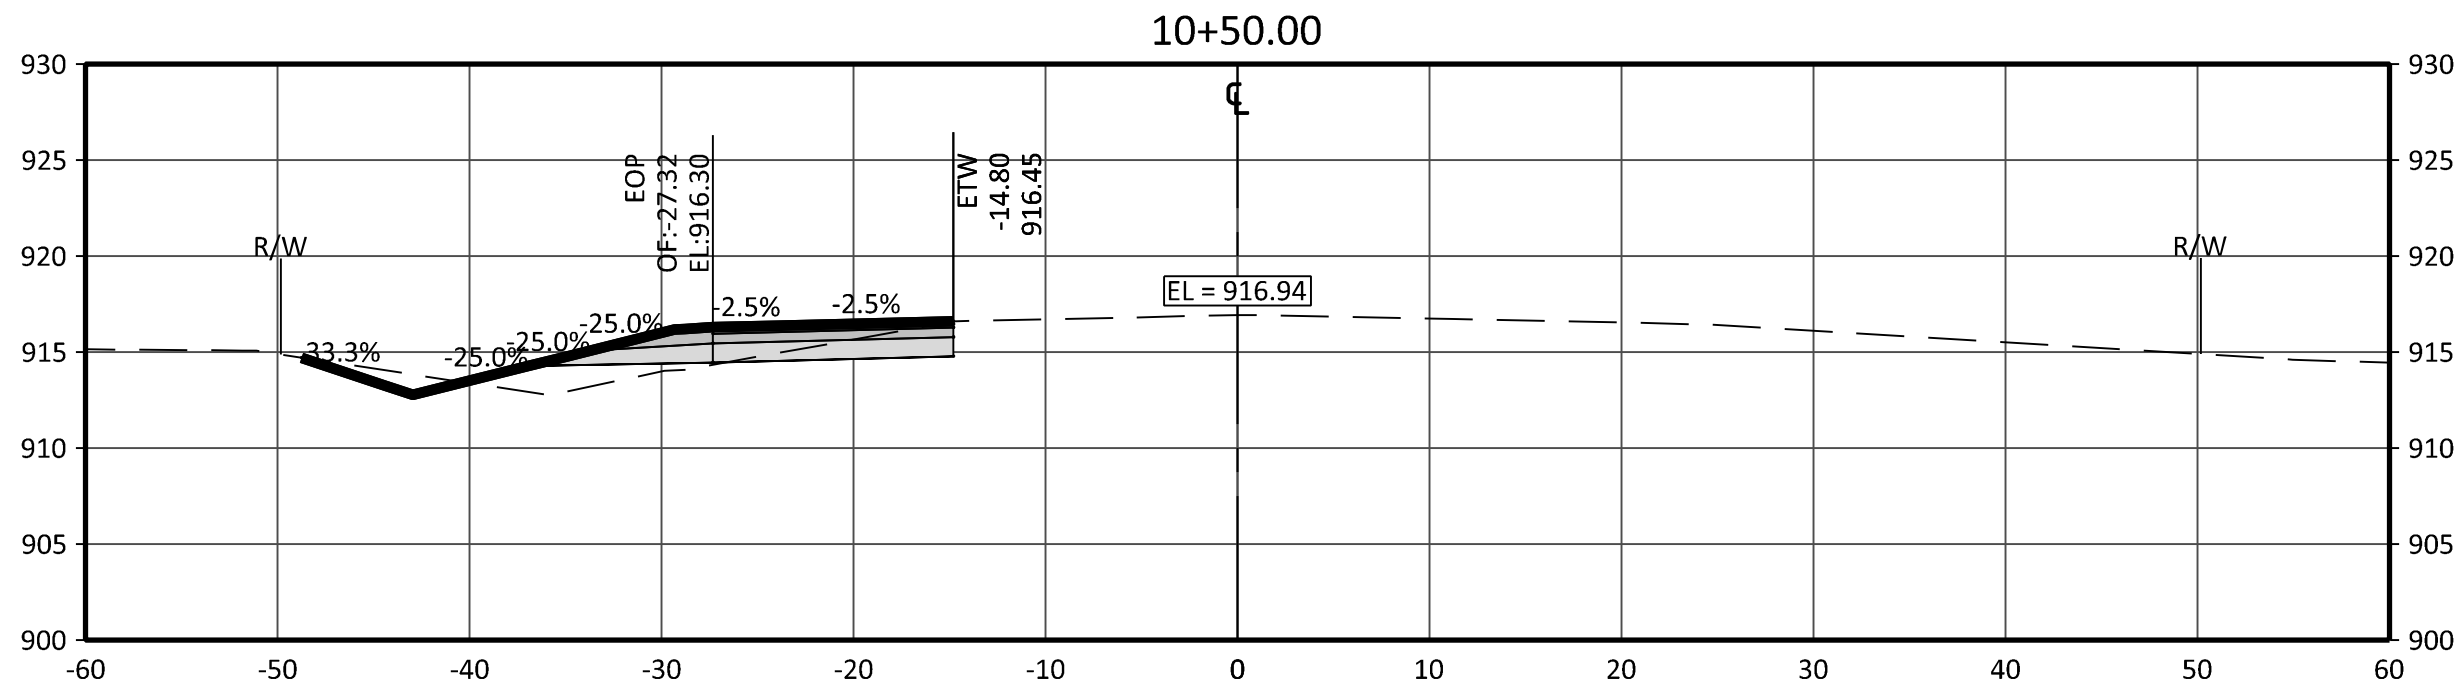
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M/JN  
PROJECT NO.  
22377



## CROSS SECTIONS

Anoka County, MN  
Ambassador Blvd. Right Turn Lane  
St. Francis, MN

SHEET  
C8.02  
11 OF 11  
REV.