DocuSign Envelope ID: 415559CF-F99	ANOKA COUNTY TRAN 1440 BUNKER ANDOVER 763-33	ISPORTATION DIVISION LAKE BLVD NW , MN 55304 24-3176 anokacountymn.gov	NOT VALID UNLESS SIGNED BY ANOKA COUNTY PERMIT NUMBER RIGHT OF WAY X COMMERCIAL ACCESS
		R PLACING OBSTRUCTIONS ON THE (TERED PRIOR TO PERMIT APPROVAL	COUNTY HIGHWAY SYSTEM
APPLICANT NAME Wruck	Excavating	CONTACT PERSON Kyle Peder	sen
ADDRESS 15920 US HWY	10	CITY Becker	
PHONE NUMBER 320310	5205	EMAIL kyle@wruckcompanym	in.com
COMPANY OR INDIVIDUA	PERFORMING WORK Wruck	Excavating	
CONTACT PERSON Tony V	Vruck	EMAIL Tony@wruckcompany	mn.com
		PHONE NUMBER 320-267-185	5
PERMIT WORK TO START	11/01/2023		
PERMIT WORK TO BE CON	11/30/2023		
DURATION OF JOB 2 wee	ks		
ARE YOU BEING ASKED TO	RELOCATE DUE TO A COUNTY	PROJECT? No	
ANOKA COUNTY PROJECT	NUMBER		

WORK SITE ADDRESS 9730 University Ave METHOD OF INSTALLATION/CONSTRUCTION open cut

NATURE OF WORK Bring sewer and water into lot.

SITE PLAN

DITCH/BLVD



IF THE ROADWAY IS ENCROACHED, YOU MUST ATTACH A TRAFFIC CONTROL PLAN AND/OR REFERENCE THE MOST CURRENT VERSION OF THE MN TEMPORARY TRAFFIC CONTROL FIELD MANUAL (3+ DAYS REQUIRES PLANS TO BE SIGNED BY A LICENSED PE).

CITY Coon Rapids

X BITUMINOUS

X CONCRETE

NONE

GRAVEL

IS SIGNING AND STRIPING REQUIRED? No

DEPTH FROM SURFACE 8ft (60" minimum under county roads)

6" PVC Sanitary, 6" Water service SIZE AND KIND OF PIPE/CABLE

NUMBER OF EXCAVATIONS 2

SIZE OF EXCAVATIONS 12ft x 16ft x 9ft (Length, width, and depth)

LOCATION OF EXCAVATIONS ALL EXCAVATIONS ARE TO BE PROTECTED AT ALL TIMES AND THEN BACKFILLED WHEN UNATTENDED AND/OR OVERNIGHT Specific written descriptions of excavations - if shown on attached drawing, drawing shall be specific with depth and distance from centerline, curb, or other distinguishable location. Traffic control plans cannot be approved without specific excavation descriptions.

Excavation #1: (Sanitary Tie in at Inv: 900.80) 12ft L x 16ft W x 8ft depth. MH is 6ft off curb line. Excavation #2: (water tie in at Inv: 903.1) 12ft L x16ft W x 8ft depth.

THIS PERMIT COVERS THE RIGHT OF WAY IN ANOKA COUNTY ONLY

ACTD reserves the right to make changes to these special conditions.



ANOKA COUNTY TRANSPORTATION DIVISION 1440 BUNKER LAKE BLVD NW ANDOVER, MN 55304 PERMIT PHONE: 763-324-3176 highwaypermits@anokacountymn.gov

GENERAL INFORMATION

One permit must be approved for each county road on which work will be performed prior to any work within the right of way by any utility/contractor. Emergency conditions which threaten the safety of the public and require immediate repair are exceptions to this rule. Under those circumstances, the utility/contractor is permitted to begin and/or complete the necessary repairs. The Anoka County Transportation Division (ACTD) shall be notified of emergency repairs as soon as feasible and a written permit is to be completed within two business days of occurrence.

A license-permit bond is generally required of the contractor as part of the registration process, the amount of which will be determined by the nature of the utility work.

A sketch or drawing shall accompany each permit application which will show the location of the proposed work/utility with reference to the county highway center line and right of way line. A complete set of plans is required for all sewer/water projects.

It shall be the responsibility of the applicant to determine which of the special conditions apply to each permit.

ACTD reserves the right to revoke any utility permit and halt work, if, upon inspection of any job site, the special conditions are not met, and/or a hazard exists for the applicant or public safety is threatened. The failure to comply with the terms and conditions of any applicable Federal, State, Regional, and local laws, rules and regulations, including any provision of Anoka County's Right-of-Way Ordinance shall be cause for immediate revocation of a permit.

The applicant shall notify ACTD immediately upon completion of project so that the ACTD can inspect the site to determine if restoration has been satisfactorily completed.

The undersigned hereby accepts the terms and conditions of this permit and the regulations of Anoka County, and agrees to fully comply therewith to the satisfaction of the ACTD. The county of Anoka, its officials, employees, and agents, shall be held harmless, by the applicant/permittee, from any demands, claims, lawsuits, or damages relating to the work described in this permit.

10/30/2023

DATE

DATE

APPLICANT'S SIGNATURE

727D4EC46AF449A...

AUTHORIZATION OF PERMIT

In consideration of the applicant's agreement to comply in all respects with the regulations of the ACTD covering such operations, permission is hereby granted for the work to be done as described in the above application. Said work to be done in accordance with the general conditions listed above and the special conditions required as hereby stated. It is expressly understood that this permit is conditioned upon replacement or restoration of the county highway and its right of way to their original or to a satisfactory condition. It is further understood that this permit is issued subject to the approval of local city or township authorities having joint supervision over said street or highway.

APPROVED BY:

TITLE: Traffic Technician

NOT VALID UNLESS SIGNED BY ANOKA COUNTY

ANOKA COUNTY TRANSPORTATION DIVISION

1440 BUNKER LAKE BLVD NW

ANDOVER, MN 55304

PERMIT PHONE: 763-324-3176

highwaypermits@anokacountymn.gov

SPECIAL CONDITIONS

TRAFFIC CONTROL

cally Respo

1) Detours

Anoka Countv

MINNESOTA

- a) Detailed detour layouts shall be submitted to the traffic engineer for approval.
- b) No detours shall be permitted without prior approval of the Anoka county traffic engineer.
- c) A ten day notice must be given prior to the installation of any detour.
- d) It shall be the responsibility of the applicant to notify Anoka county central communications, local government bodies, and any affected bus companies ten days prior to any road closures/detours.
- e) Immediately upon completion of work and/or detours, all posts, barricades, and signs shall be removed from the right of way.

2) Traffic control devices

a) All traffic control devices, barricades, flashers, etc., shall be furnished by the applicant and shall be in accordance with the most recent edition of the Minnesota manual on uniform traffic control devices and temporary traffic control zone layouts – field manual of the same manual.

CONSTRUCTION REQUIREMENTS

- 1) Open cutting of bituminous or concrete surfaced roads will be allowed only at the discretion of the county engineer.
- 2) Neither supplies nor excavation materials shall be placed on the bituminous or concrete surface at any time.
- 3) No trenches will be allowed to remain open overnight.
- 4) Materials removed from the trench shall be used as backfill insofar as they are suitable. All backfill material shall conform to MNDOT specifications for compaction. The use of heavy equipment on top of trench, slapping with backhoe bucket and/or back casting to achieve compaction is prohibited. Any additional material required to back fill to the original grade shall be furnished by the applicant at no expense to the ACTD. All the base and surface courses damaged during construction operations shall be restored to a condition equal to or better than before operations began. The applicant shall be responsible for and restore any settlement.
- 5) All culverts, ditches, shoulders, and backslopes shall be restored to their original condition unless otherwise directed by the ACTD. Shoulders which have been previously constructed or reconstructed with special materials shall be replaced in kind. Restoration of signs, guardrails, guard posts, etc., are the sole responsibility of the applicant and shall be restored to their original condition.
- 6) All roadway maintenance required within the limits of the utility project that is related to the applicant's activities shall be the sole responsibility of the applicant for one year after completion of the project. Upon completion of the restoration work, the applicant shall request a final inspection by the ACTD. The ACTD's approved completion date shall be the starting date of the applicant's one-year responsibility.

HORIZONTAL BORING AND JACKING

- 1) All hard surface roadways shall be jacked or bored.
- 2) All crossings of Anoka County maintained roadbeds, shall be made by boring inside a casing or carrier pipe, or by jacking unless otherwise directed by the Anoka County Engineer. The auger shall lead the casing or carrier pipe by at least six inches whenever possible and never lead the carrier pipe by more than one inch.
- 3) The use of pneumatic devices to facilitate the roadbed crossings will be allowed in most cases with prior approval. In the event approval is not granted and applicant uses a pneumatic device to cross a roadbed and encounters an obstruction and/or unstable subbase material which makes forward or reverse motion of pneumatic device impossible, said pneumatic device then becomes part of the roadway subbase and permission to excavate to retrieve device will not be granted.
- 4) If a pneumatic device is used for the work permitted herein, the installation must be kept to a minimum of four feet below the surface of the roadway if the pneumatic device is less than two inches in diameter, and a minimum of five feet below the surface of the roadway if the pneumatic device is two inches in diameter or larger.

BITUMINOUS RESTORATION

- 1) The locations and dimensions of all openings to be made in the bituminous surface shall be approved by the ACTD prior to any cutting or any surface opening operations.
- 2) All openings in bituminous surfaces shall be cut in a straight line with the sides smooth and vertical. No ragged edges will be permitted. Cutting shall be done with a concrete saw.
- 3) All necessary dust control operations shall be carried out by the applicant at no expense to Anoka County.
- 4) The minimum requirement for subgrade replacement shall be the upper twelve inches of material and shall meet MNDOT specifications for class five placed in six inch layers compacted to one hundred percent of optimum density.
- 5) All manhole casings, gate valves, and other utility structures shall be set one quarter inch below the top of the finished surface.
- 6) Bituminous tack coat materials and application thereof shall conform to MNDOT specification 2357.
- 7) All bituminous surfacing shall be replaced as soon as practicable after the base construction. All bituminous surfacing shall be machine laid. Any exceptions must be approved by the ACTD. Bituminous surfacing shall be replaced to original pavement depth or to a minimum of six inches of bituminous mixture (2360), whichever is greater. Bituminous mixtures must be placed in lifts not exceeding three inches in thickness for base and binder courses and not exceeding two inches for the wear course.
- 8) All surface restoration regardless of size shall conform to existing grades.
- 9) Any unnecessary or negligent damage to bituminous surface in conjunction with the installation and/or repair of a utility shall be cut out and replaced in kind as directed by the ACTD.

Anoka County

Respectful, Innovative, Fiscally Responsible

ANOKA COUNTY TRANSPORTATION DIVISION 1440 BUNKER LAKE BLVD NW

ANDOVER, MN 55304

PERMIT PHONE: 763-324-3176

highwaypermits@anokacountymn.gov


CO	NCRETE RESTORATION
1)	Curb and gutter, sidewalks, and driveways shall be restored in accordance with MNDOT specifications 2531 and 2521.
UTI	ILITY LINES
1)	There shall be only a single pole line on the county right of way on either side of the center line thereof.
2)	Exact locations of longitudinal installations on county highways shall be located as directed by the ACTD.
<u>SEC</u>	CTION CORNER MONUMENTS
1)	Utility locations shall not interfere with the location of any section, quarter, witness, or right of way monuments. For assistance in locations, contact the Anoka County Surveyor's Office.
2)	The applicant shall be responsible for replacement of any existing property irons disturbed during construction.
3)	The applicant shall notify the Anoka County Surveyor's Office three working days in advance of any anticipated disturbance of any section, quarter, witness, or right of way monuments.
4)	Any monument disturbed during the course of construction, shall be reset by the Anoka County Surveyor's Office at the expense
	of the applicant.
ATT	ACHING TO BRIDGES/STRUCTURES
1)	No utility is permitted to be hung from, or otherwise attached to, any bridge or structure without having detailed plans approved by the Anoka County Engineer. These plans are to show approaches to the structure, method of installation, type, and dimension of housing for the utility.
ADI	DITIONAL PROVISIONS
1)	 All subcontractors, installers, and crew shall possess a physical or electronic copy of all documents in relation to the approved permit prior to the commencement of work and be kept on site. This includes, but it not limited to the following: a) Approved permit b) Any/all traffic control plans and/or layouts
2)	Shall notify Anoka County Permits at 763-324-3176 or highwaypermits@anokacountymn.gov
	a) At least 36 hours prior to the commencement of work
	b) With time frame of proposed of work
	c) Anticipated traffic control
2	d) When work is complete - including restorations - to request a final inspection
3)	No work during inclement weather or when plows are out in any capacity
4)	All traffic control shall be in accordance with the most current version of the MnDOT Temporary Traffic Control Field Manual

	DS
INITIAL	kp



ANOKA COUNTY



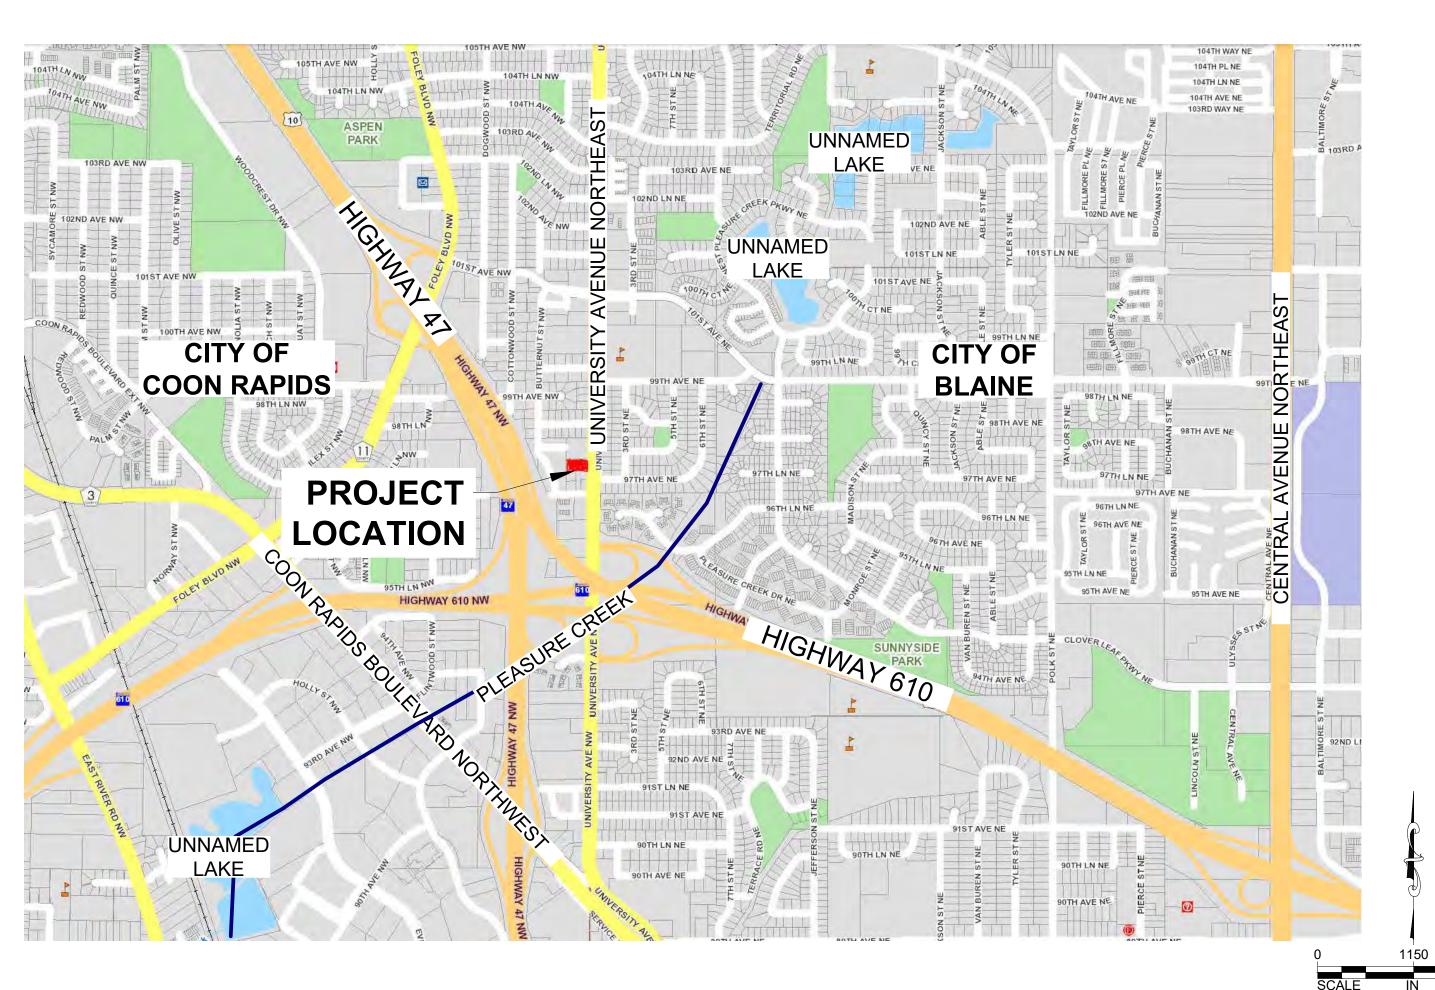

DESIGNED BY:	I HEREBY CERTIFY THAT THIS PLAN, SPECIFICATION, OR REPORT WAS PREPARED BY ME OR UNDER MY DIRECT SUPERVISION AND THAT I AM A		REVISIONS	
	DULY LICENSED PROFESSIONAL ENGINEER UNDER THE LAWS OF THE STATE	04.13.23	CLIENT COMMENTS	
DRAWN BY:	OF MINNESOTA.			
JPF				
CHECKED BY:	JEFFREY A. PRÁSCH, P.E.			
GRP	DATE: 2.28.23 LIC. NO.: 52706			1

SITE DEVELOPMENT PLANS FOR CEDARWOOD **9730 UNIVERSITY AVE. NW COON RAPIDS, MINNESOTA**



VALUE HOMES 12301 CENTRAL AVE. NE, SUITE 101 BLAINE, MINNESOTA 55434

CEDARWOOD

SHEET INDEX

THIS PLAN CONTAINS 9 SHEETS

SHEET NO.	DESCRIPTION
C1	TITLE SHEET
C2-C4	DETAILS
C5	EXISTING CONDITIONS & REMOVALS PLAN
C6	SITE PLAN
C7	GRADING & EROSION CONTROL PLAN
C8	UTILITY PLAN
L1	LANDSCAPE PLAN



Gopher State One Call

THE SUBSURFACE UTILITY INFORMATION DEPICTED IN THESE PLANS ARE SHOWN ACCORDING TO CI/ASCE 38-02, "STANDARD GUIDELINES FOR THE COLLECTION AND DEPICTION OF EXISTING SUBSURFACE UTILITY DATA," LEVEL D STANDARDS.

LEGEND

IMPAIRED WATERS


2300 FEET


9730 UNIVERSITY AVE. NW COON RAPIDS, MINNESOTA


TITLE SHEET


PROJECT: 90259A

SHEET NO. C1 OF C8

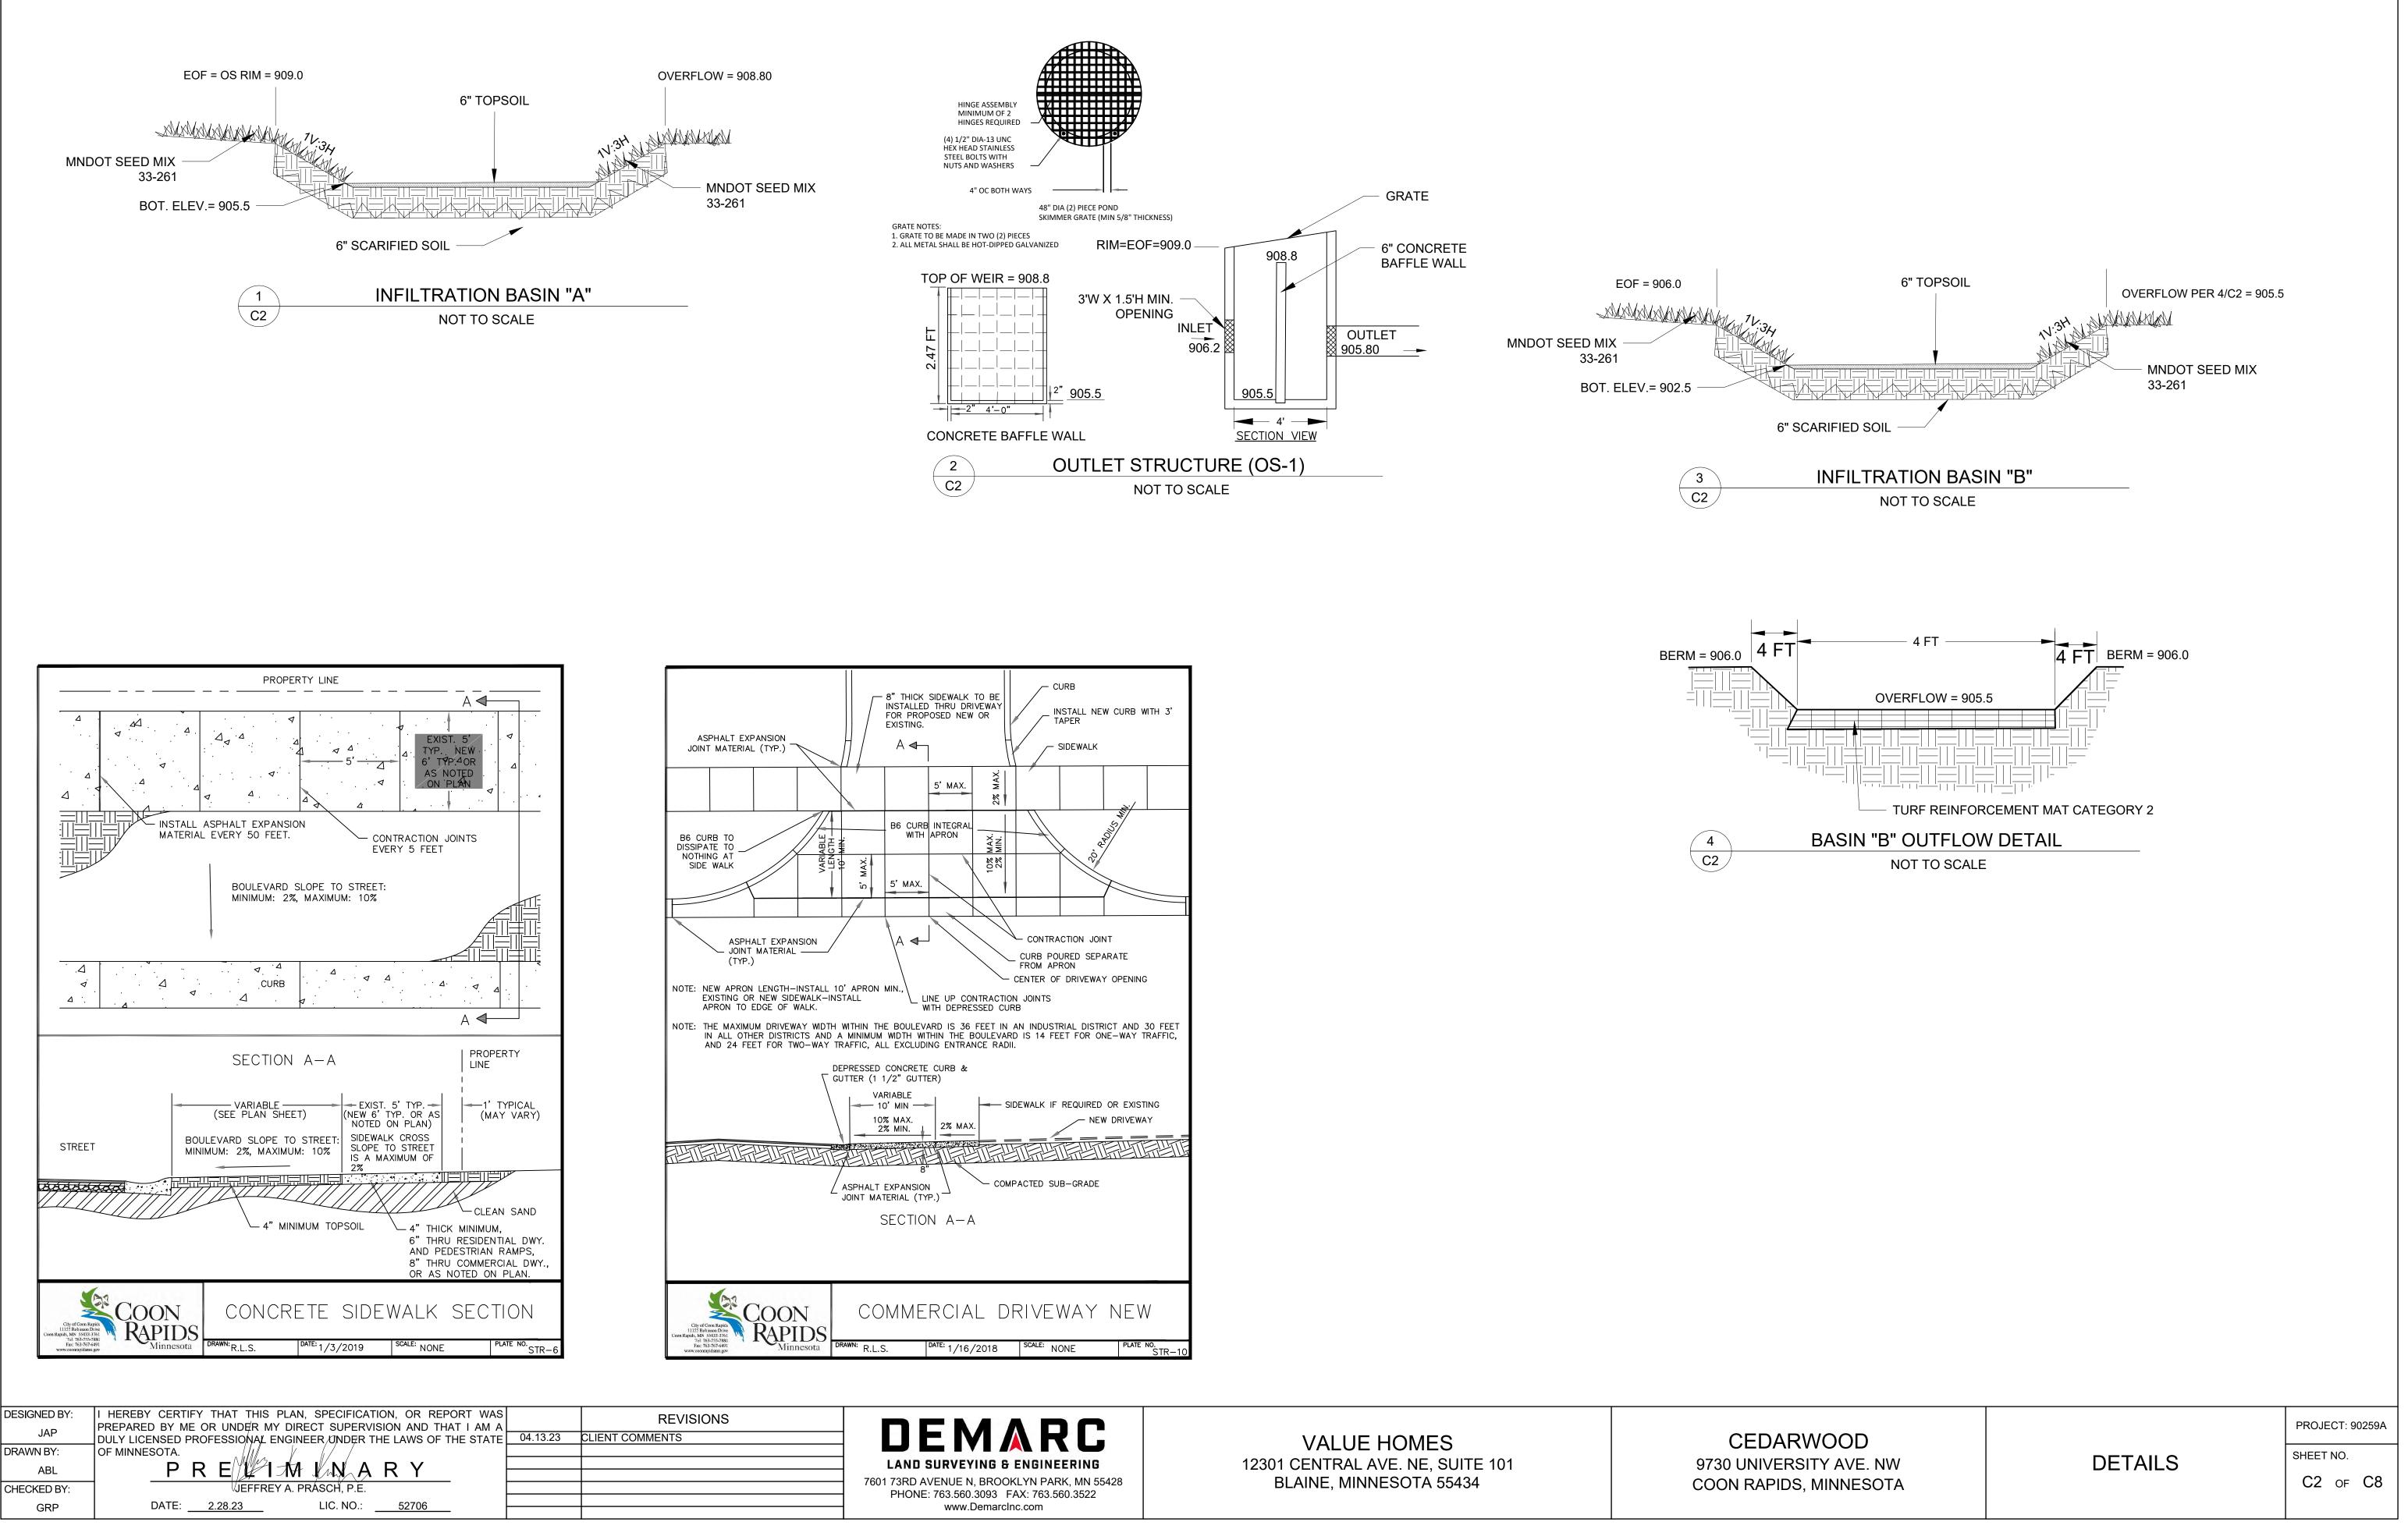

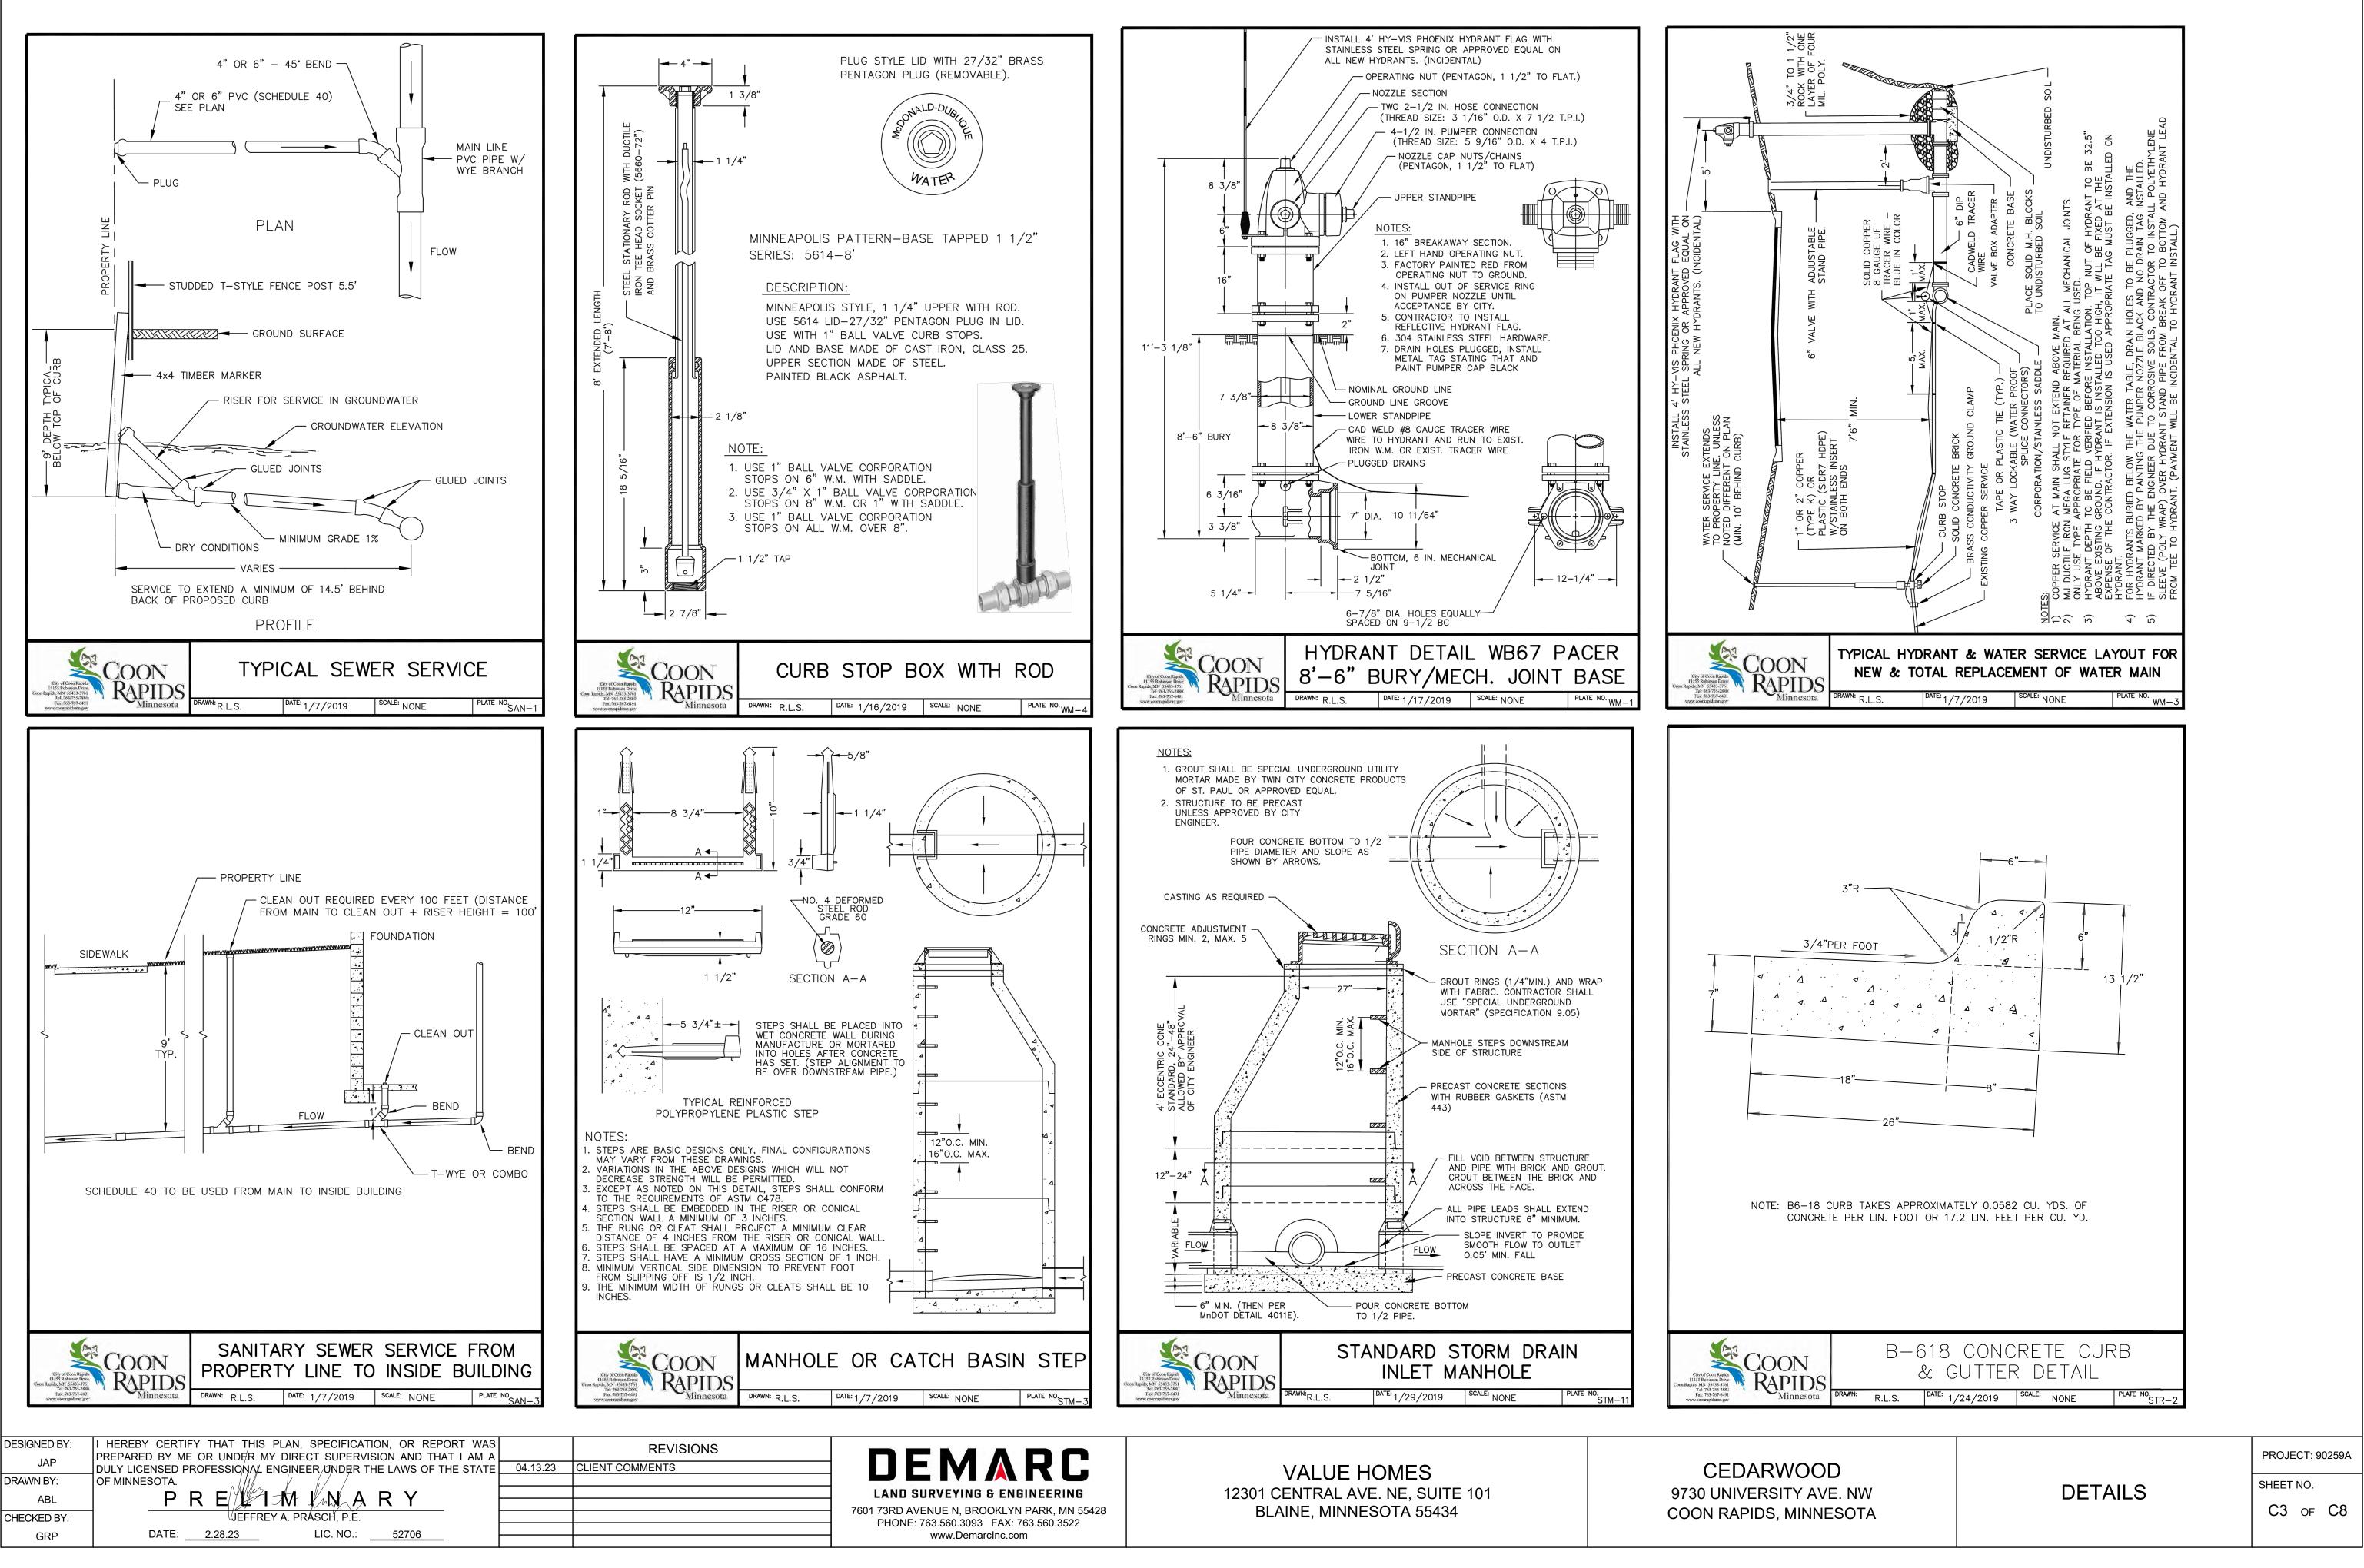

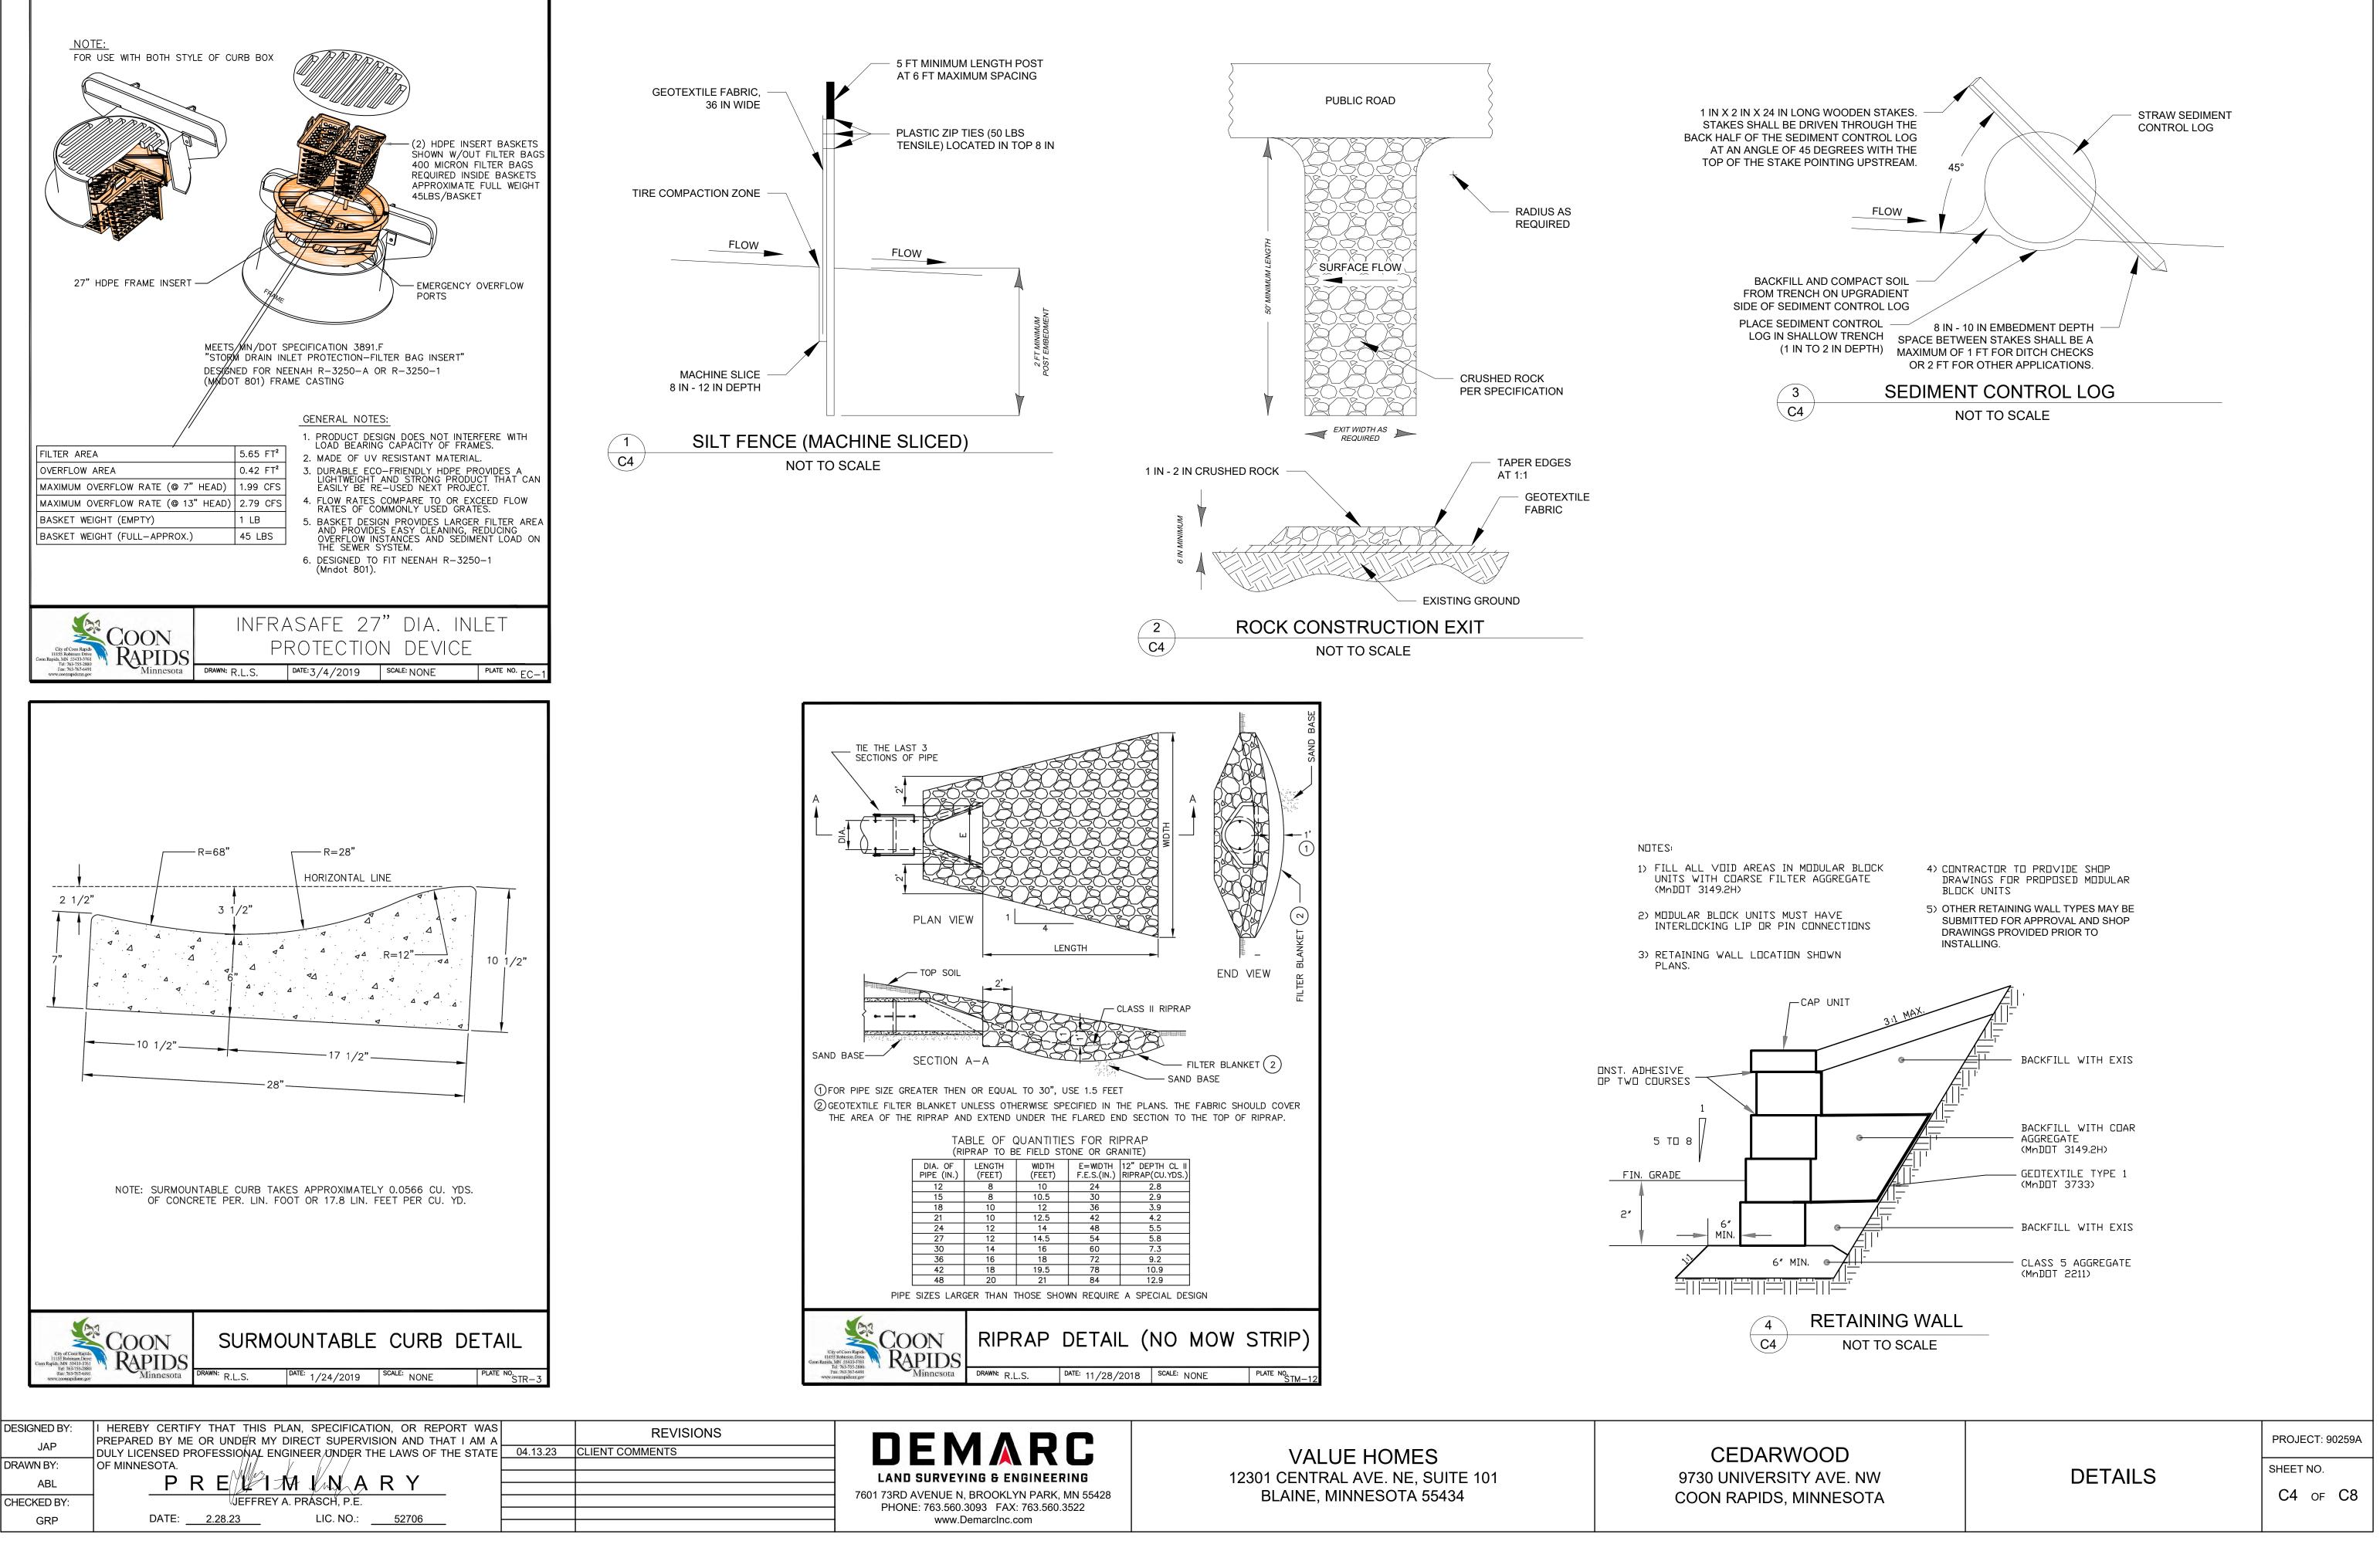

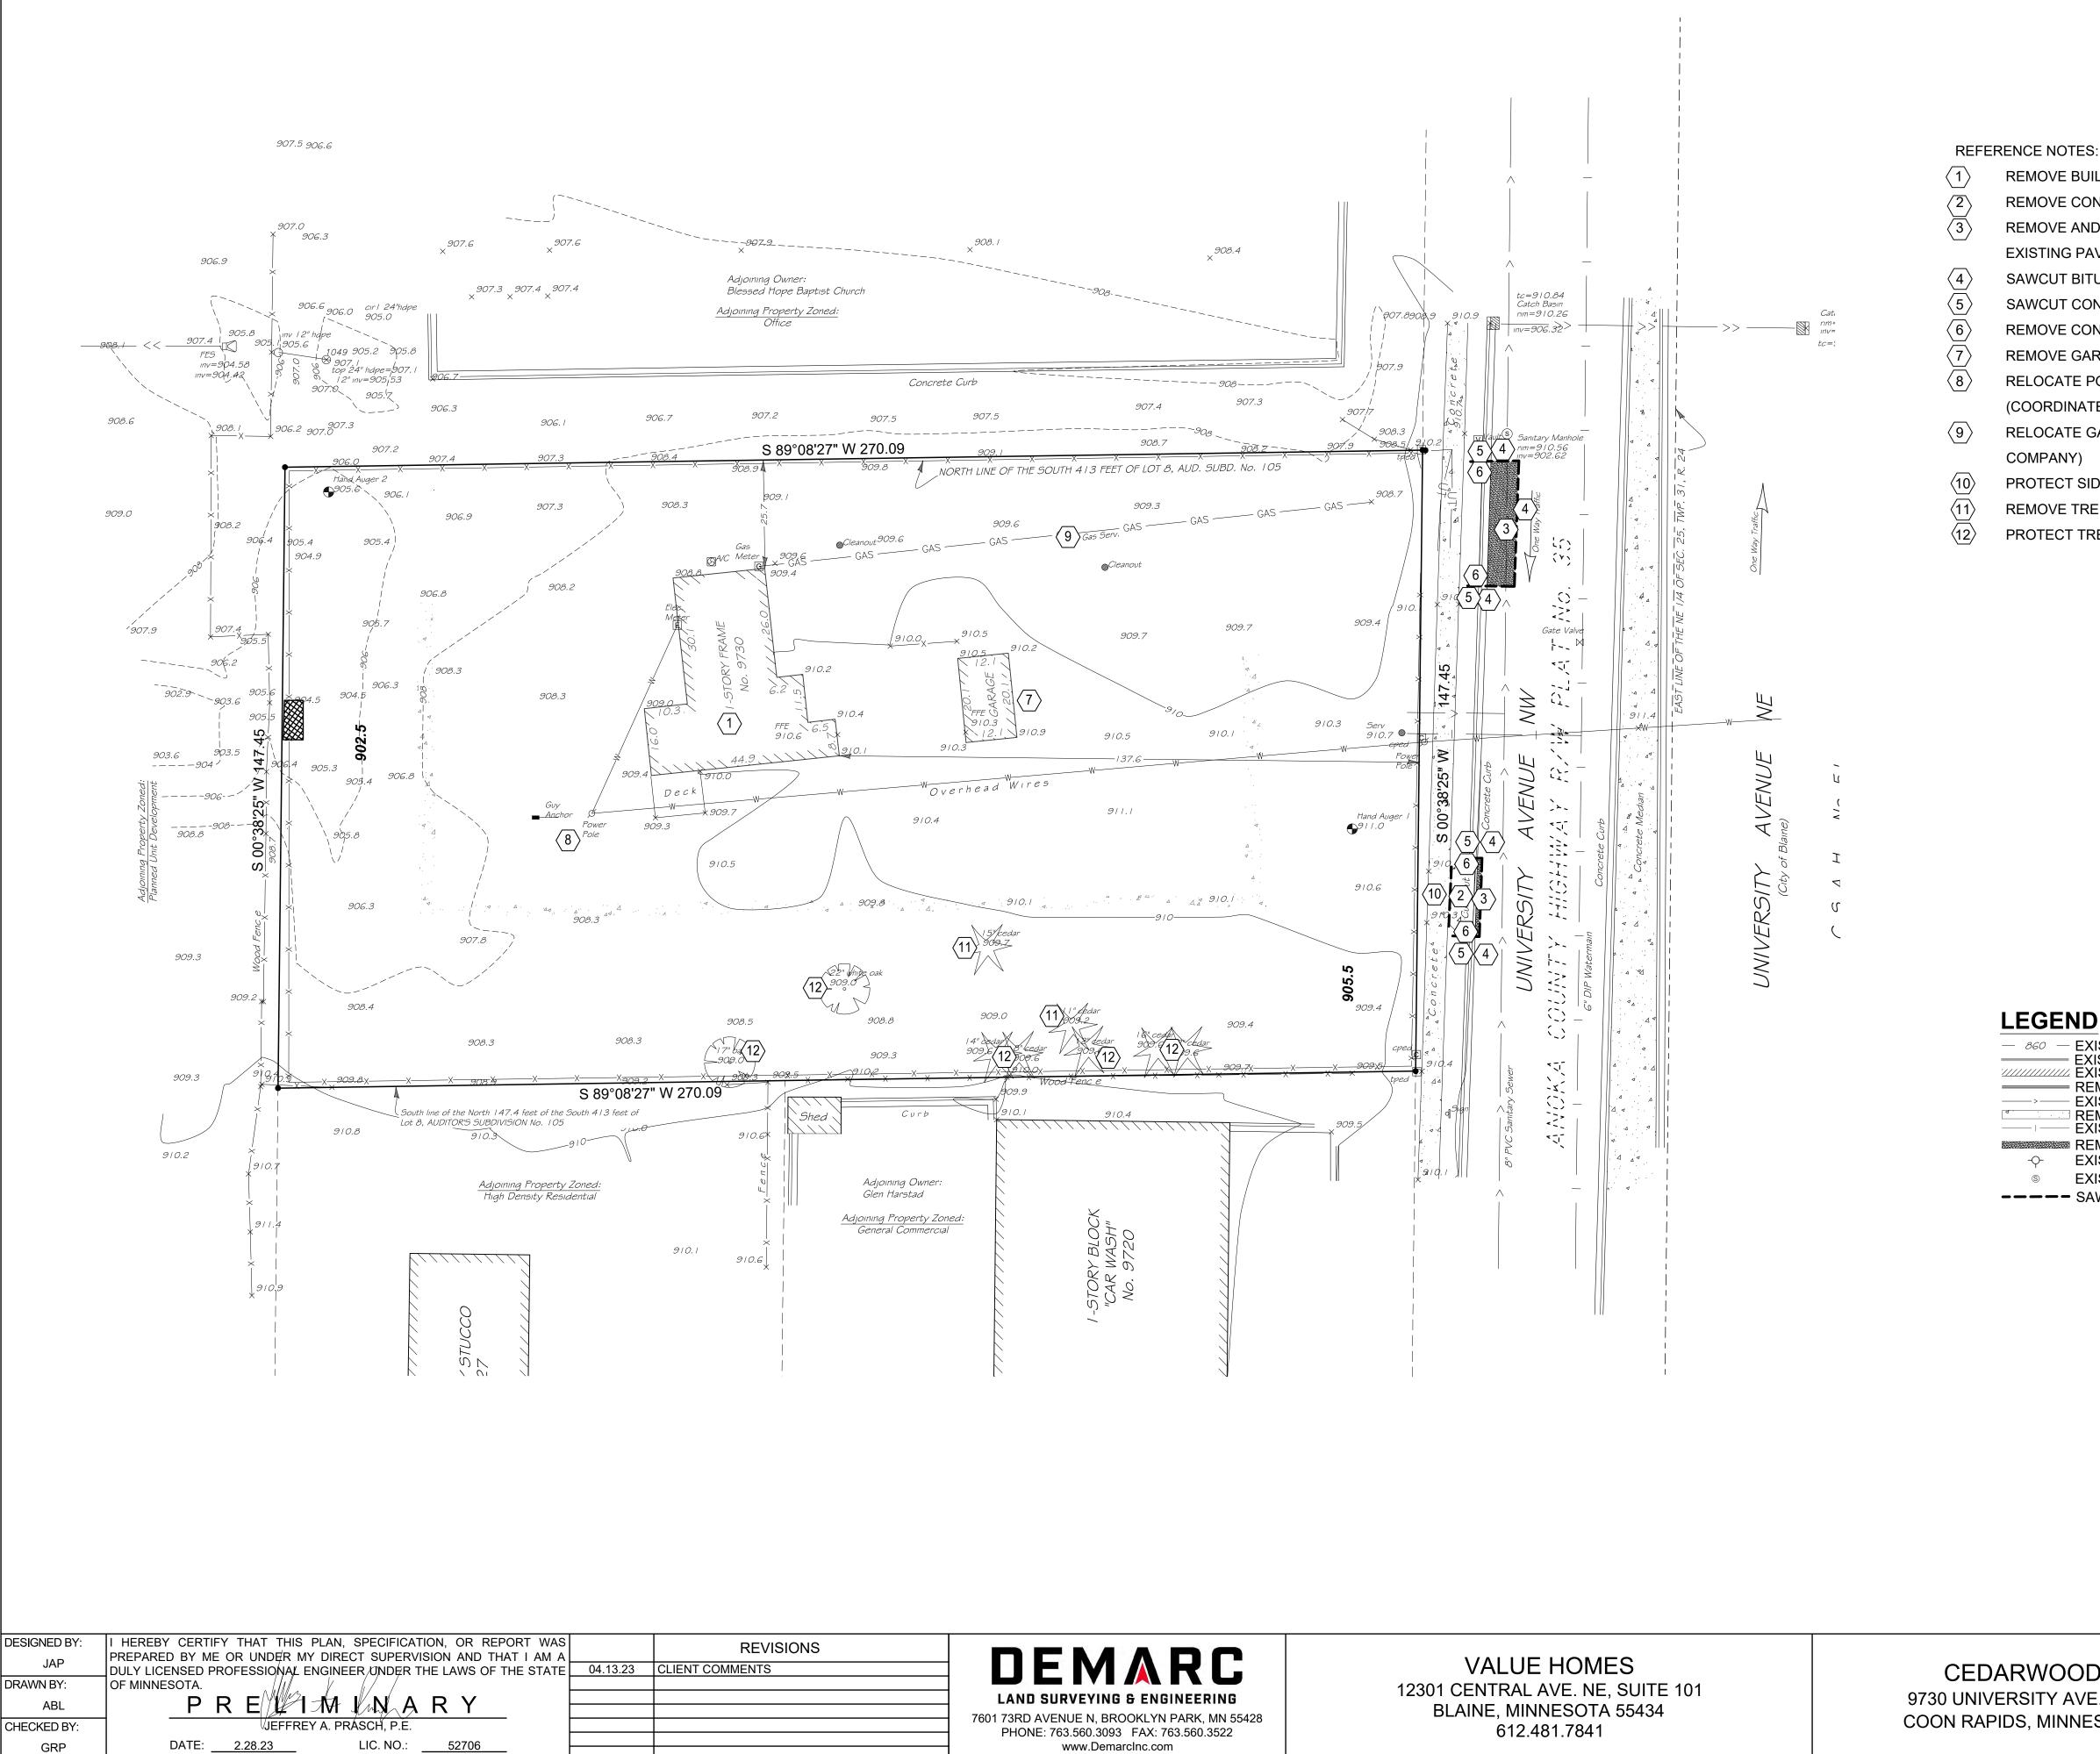


CEDARWOOD 9730 UNIVERSITY AVE. NW COON RAPIDS, MINNESOTA

- **REMOVE BUILDING**
- REMOVE CONCRETE PAVEMENT (FULL DEPTH)
- REMOVE AND PATCH BITUMINOUS PAVEMENT (MATCH EXISTING PAVEMENT SECTION)
- SAWCUT BITUMINOUS PAVEMENT (FULL DEPTH)
- SAWCUT CONCRETE CURB & GUTTER (FULL DEPTH)
- REMOVE CONCRETE CURB & GUTTER
- REMOVE GARAGE
- RELOCATE POWER POLE AND OVERHEAD WIRES
- (COORDINATE WITH UTILITY COMPANY)
- RELOCATE GAS LINE (COORDINATE WITH UTILITY
- COMPANY)
- PROTECT SIDEWALK
- **REMOVE TREES**
- PROTECT TREES


LEGEND

	-
	STING CONTOUR
EXI	STING CURB & GUTTER
·/////////////////////////////////////	STING BUILDING
——— RE	MOVE CURB & GUTTER
> — EX	STING STORM SEWER
	MOVE CONCRETE
———— EX	STING WATERMAIN
RE	MOVE BITUMINOUS PAVEMENT
- Ģ- EX	STING HYDRANT
s EX	STING SANITARY MANHOLE
SA	WCUT PAVEMENT

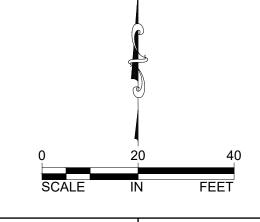

EXISTING CONDITIONS & REMOVALS PLAN

PROJECT: 90259A SHEET NO. C5 OF C8

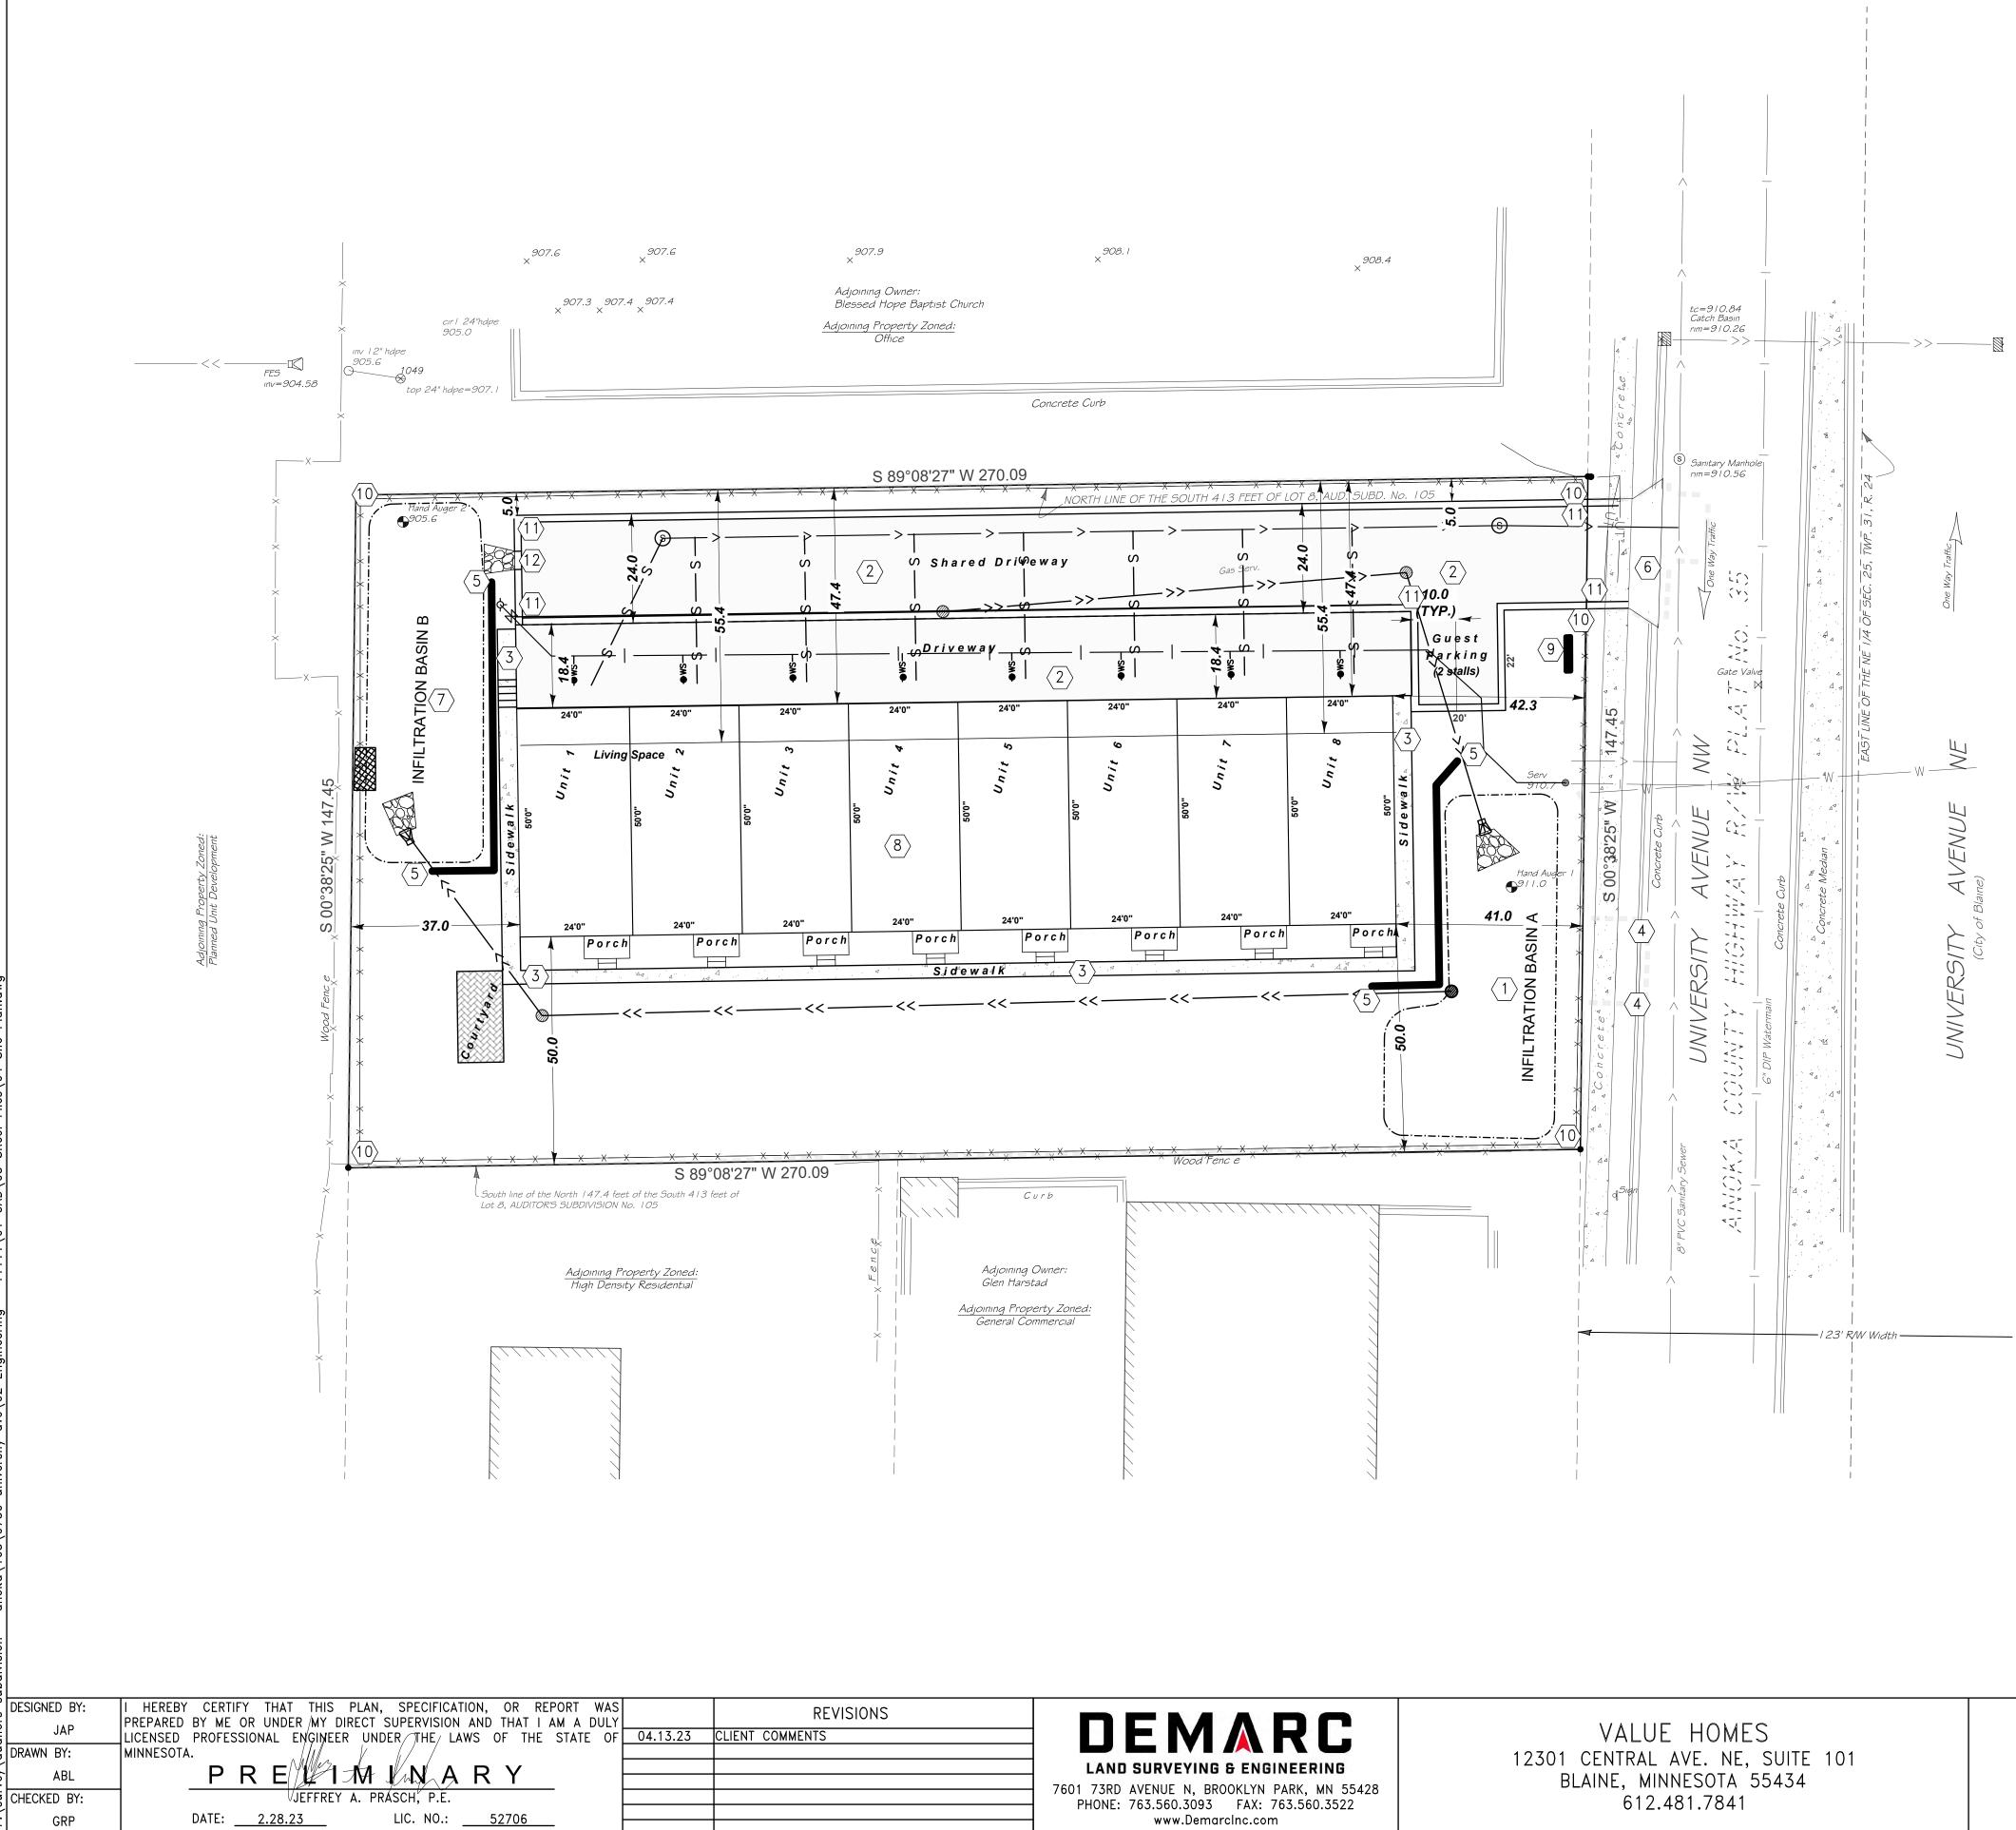



CEDARWOOD COON RAPIDS, MINNESOTA



REFERENCE NOTES: $\langle 1 \rangle$ INFILTRATION BASIN "A" PER 1/C2 AND 2/C2 $\langle 2 \rangle$ BITUMINOUS PAVEMENT CONCRETE SIDEWALK $\langle \mathbf{3} \rangle$ B612 CURB & GUTTER PER STR-2 ON C3 (MATCH EXISTING) **4** MAXIMUM 4 FT HIGH WALL PER 4/C4 (BLOCK OR APPROVED EQUAL) $\langle 5 \rangle$ $\langle 6 \rangle$ DRIVEWAY ENTRY PER STR-10 ON C2 INFILTRATION BASIN "B" PER 3/C2 AND 4/C2 < 7 > BUILDING (SEE ARCHITECTURAL PLANS) $\langle 8 \rangle$ $\langle 9 \rangle$ MONUMENT SIGN $\langle 10 \rangle$ 6'FENCE $\langle 1 1 \rangle$ SURMOUNTABLE CURB PER STR-3 ON C4 $\langle 12 \rangle$ 4' WIDE CURB CUT WITH RANDOM RIPRAP CLIII

SITE DATA: LOT AREA = 0.91 ACRES DISTURBED AREA = 0.93 ACRES EXISTING IMPERVIOUS AREA = 0.04 ACRES EXISTING PERVIOUS AREA = 0.87 ACRES PROPOSED IMPERVIOUS AREA = 0.48 ACRES PROPOSED PERVIOUS AREA = 0.43 ACRES BUILDING COVERAGE = 0.22 ACRES = 24.11%

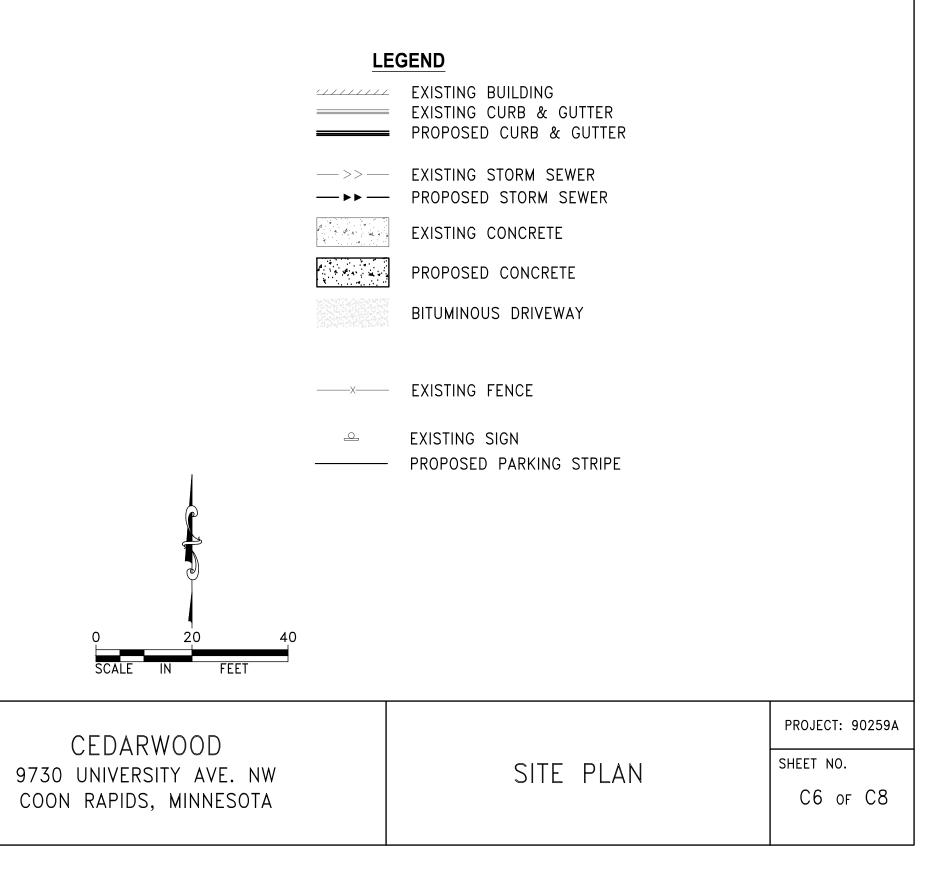

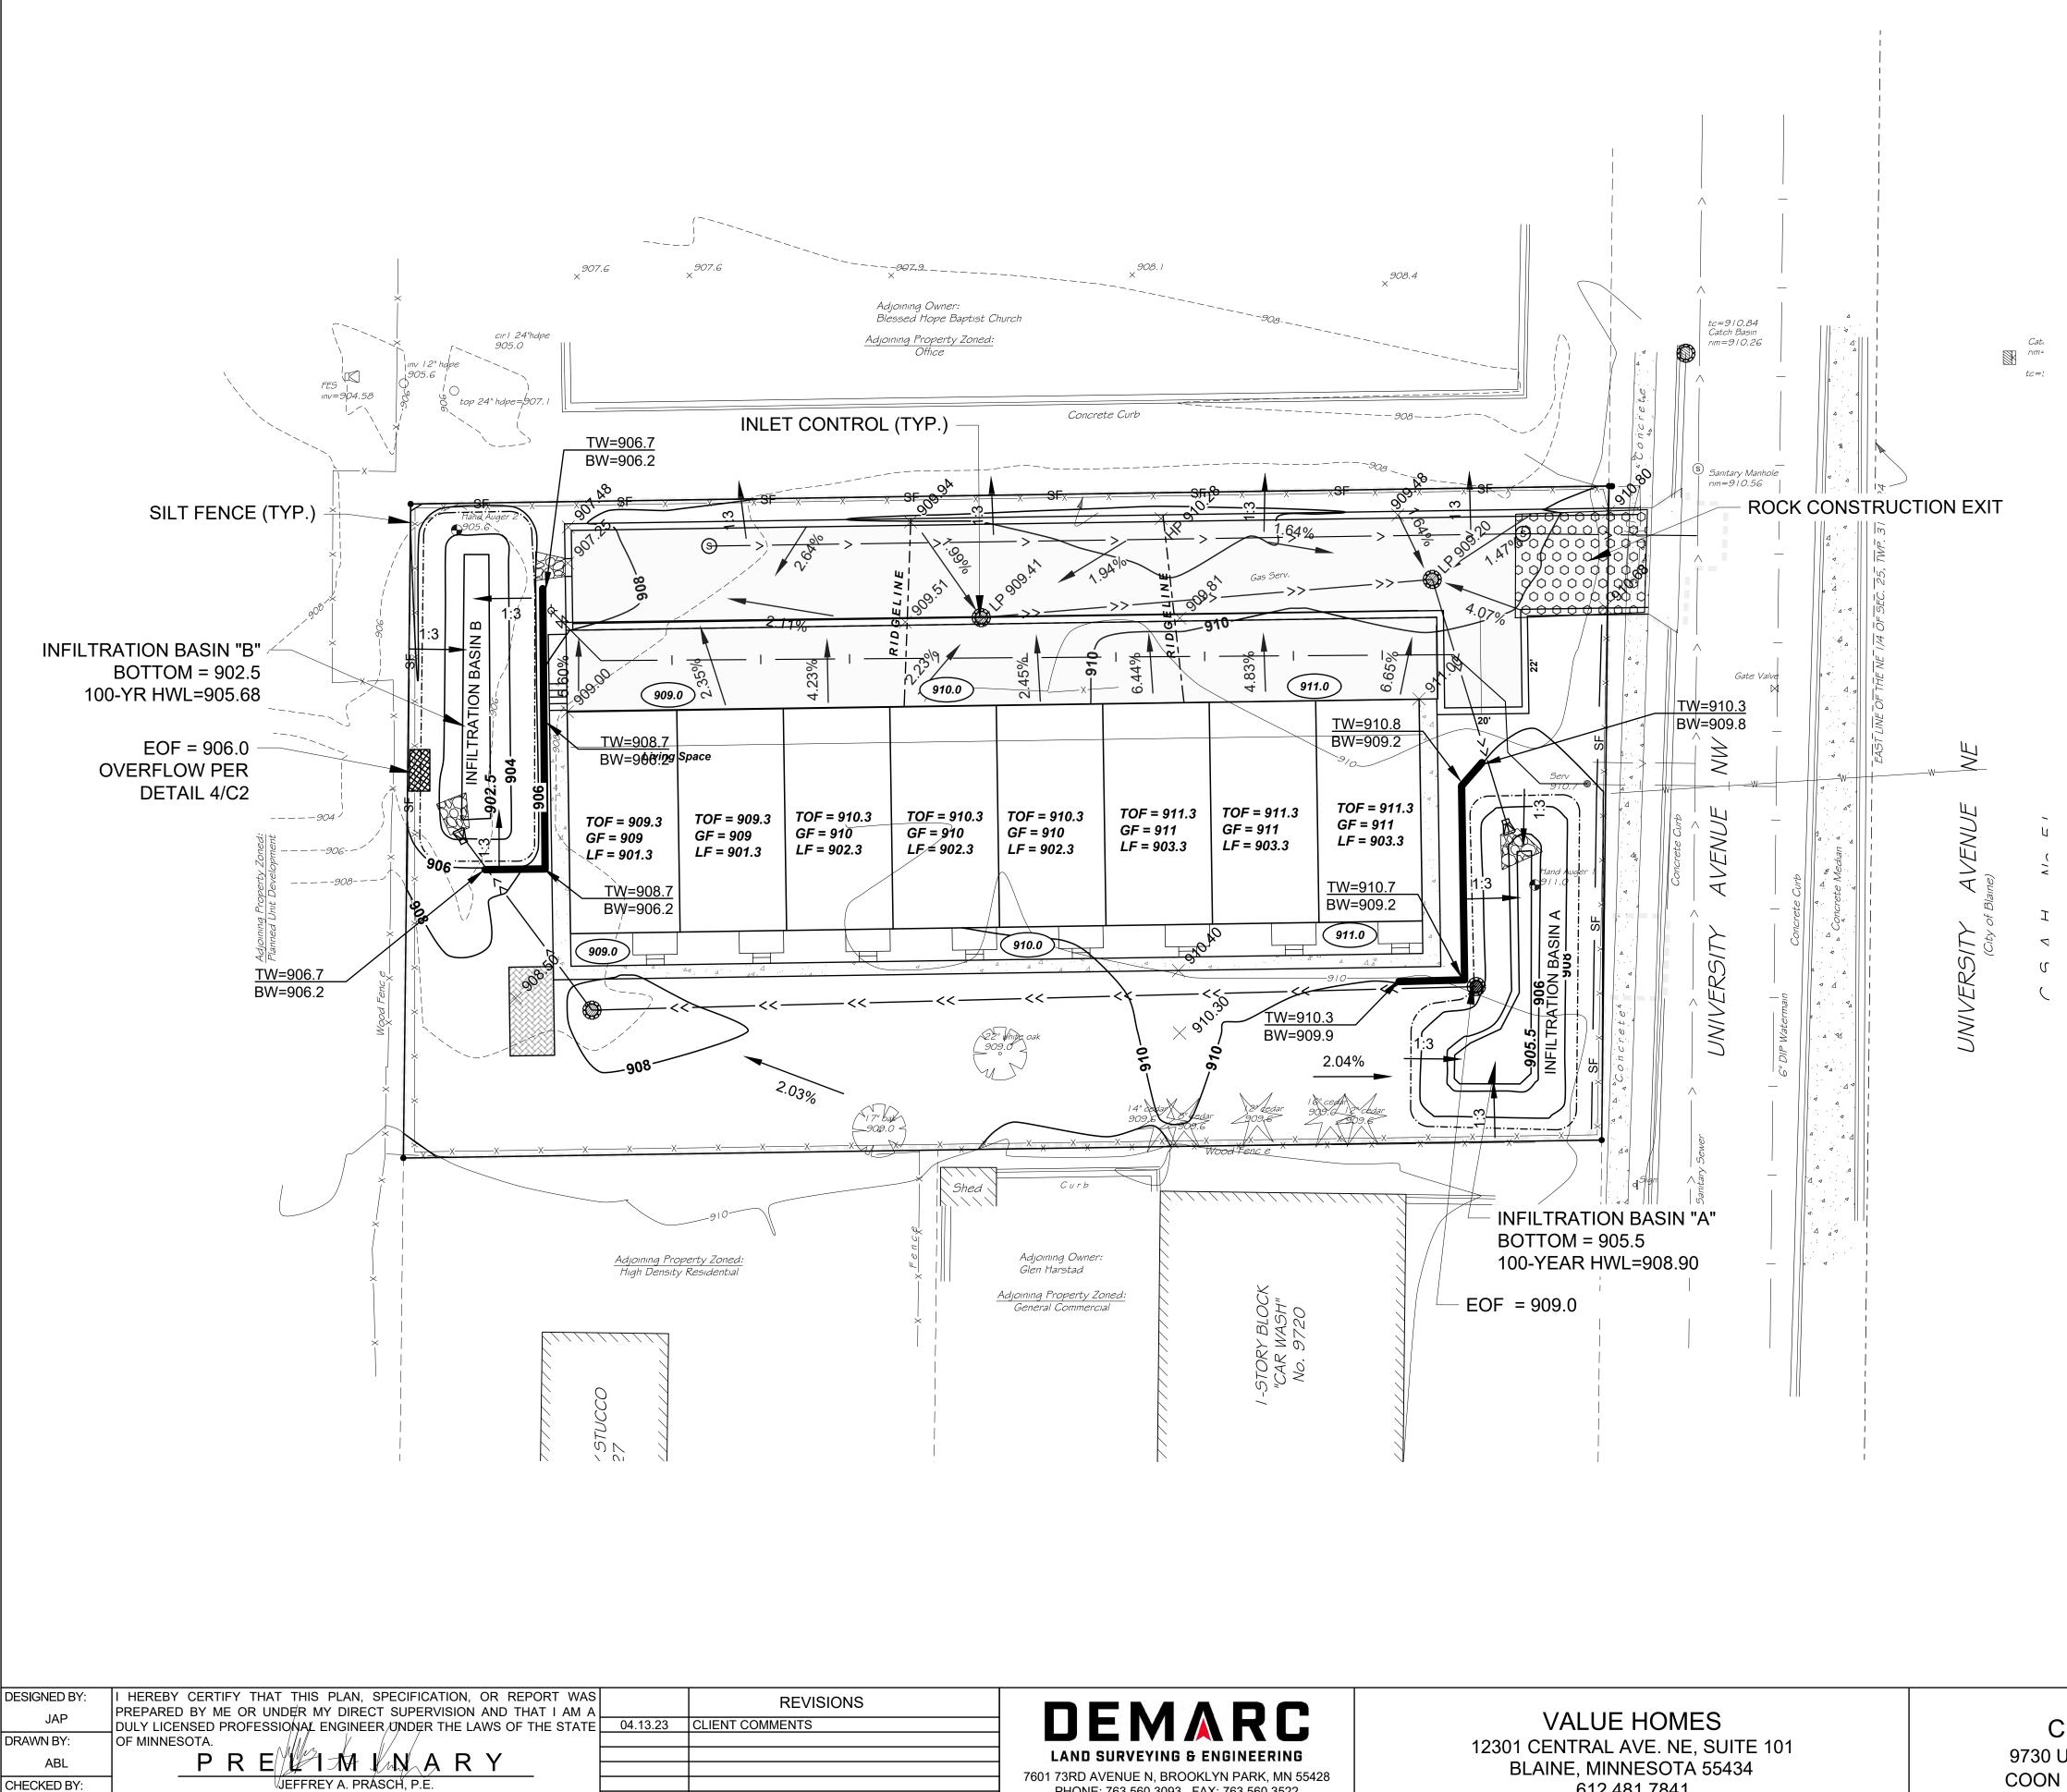

GRP

LIC. NO.: 52706

DATE: <u>2.28.23</u>


PHONE: 763.560.3093 FAX: 763.560.3522 www.DemarcInc.com

612.481.7841


CEDARWOOD 9730 UNIVERSITY AVE. NW COON RAPIDS, MINNESOTA

GENERAL CONSTRUCTION AND SOILS NOTES:

- 1. CONSTRUCTION SHALL COMPLY WITH ALL APPLICABLE GOVERNING CODES, LAWS AND ORDINANCES.
- 2. THE CITY OF COON RAPID'S STANDARD SPECIFICATIONS FOR STREET AND UTILITY CONSTRUCTION SHALL GOVERN FOR ALL IMPROVEMENTS WITHIN THE PUBLIC RIGHT-OF-WAY.
- 3. THE 2020 EDITION OF THE MINNESOTA DEPARTMENT OF TRANSPORTATION "STANDARD SPECIFICATIONS FOR CONSTRUCTION" SHALL APPLY.
- 4. THE CONTRACTOR SHALL BE SOLELY AND COMPLETELY RESPONSIBLE FOR FOLLOWING ALL APPLICABLE OSHA STANDARDS.
- 5. IF UTILITY RELOCATION IS NECESSARY, THE CONTRACTOR SHALL COORDINATE CONSTRUCTION ACTIVITIES WITH THE APPROPRIATE UTILITY COMPANIES.
- 6. MATERIAL UNSUITABLE FOR CONSTRUCTION (E.G. TOPSOIL, SILTS, ORGANIC MATERIALS, PEATS, DEBRIS, ETC.) ENCOUNTERED DURING EXCAVATION WITHIN THE PARKING LOT AND BUILDING PAD AREAS SHALL BE REMOVED AND PROPERLY DISCARDED.
- GRADING SHALL BE CONSTRUCTED WITH SUITABLE MATERIAL 7. AND IN LOOSE LIFTS NO THICKER THAN TWELVE (12) INCHES. COMPACTION WITHIN THE DRIVEWAY AND BUILDING PAD SHALL BE COMPACTED TO 100% OF THE MAXIMUM STANDARD PROCTOR DENSITY.
- TOPSOIL SHALL BE SALVAGED AND STOCKPILED FOR USE AS 8. TOPSOIL IN GREEN SPACES DISTURBED DUE TO CONSTRUCTION.
- 9. THE CONTRACTOR IS RESPONSIBLE FOR DISPOSING OF BITUMINOUS AND CONCRETE MATERIALS DISTURBED BY CONSTRUCTION IN ACCORDANCE WITH MNDOT SPEC 2104.3.
- 10. ANY EXCESS MATERIAL SHALL BE DISPOSED OF OFF-SITE IN A MANNER ACCEPTABLE TO THE OWNER AND ALL GOVERNING **REGULATIONS.**
- 11. CONTRACTOR SHALL VERIFY ALL EXISTING UTILITIES AND CALL GOPHER STATE ONE CALL 48 HOURS PRIOR TO CONSTRUCTION WORK. EXISTING UTILITIES SHOWN ON THESE PLANS ARE ONLY APPROXIMATE AND MAY NOT BE RELIED UPON AS EXACT OR COMPLETE.

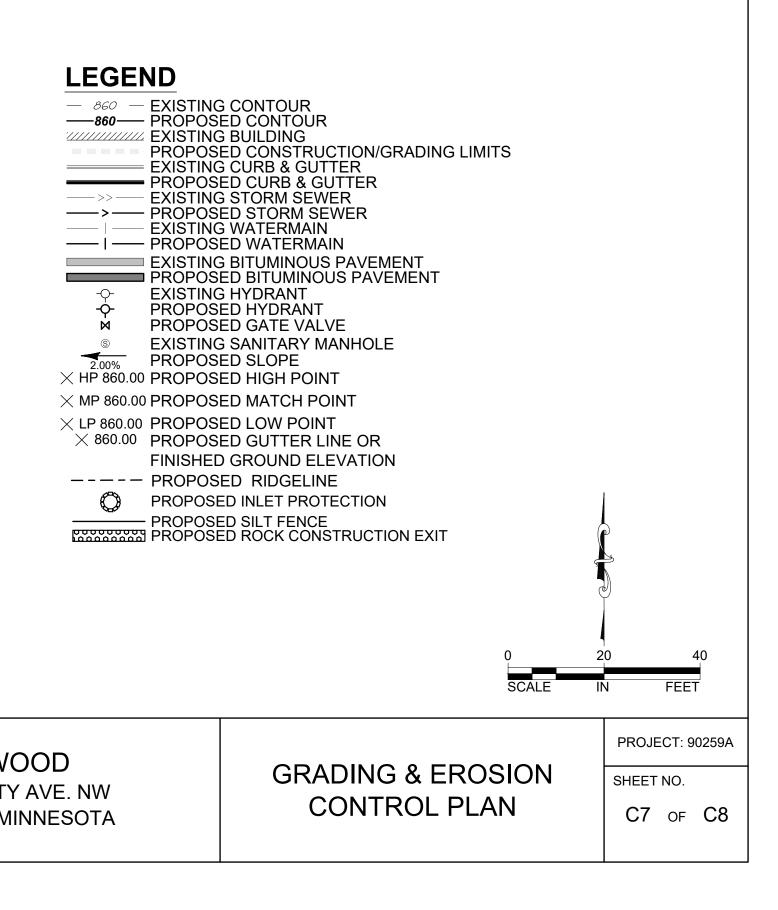

FES 111v=904.58	× × cir 1 24"hdpe 905.0 inv 12" hdpe 905.6 0 1049 × top 24" hdpe=907.1	SMH 2 48" DIA. (R-1733) RIM=908.83 INV(E)=901.80 CB 48" DIA. (R-2501-0	
50 LF 12" HDPE @ 0.94% —	6" 45° BEND	INV = 902.50	41 0.40 ^w
DESIGNED BY: I HEREBY CERTIFY THAT T		Adjoining Property Zoned: High Density Residential	Adjoining Own Glen Harstad Adjoining Property General Commu-

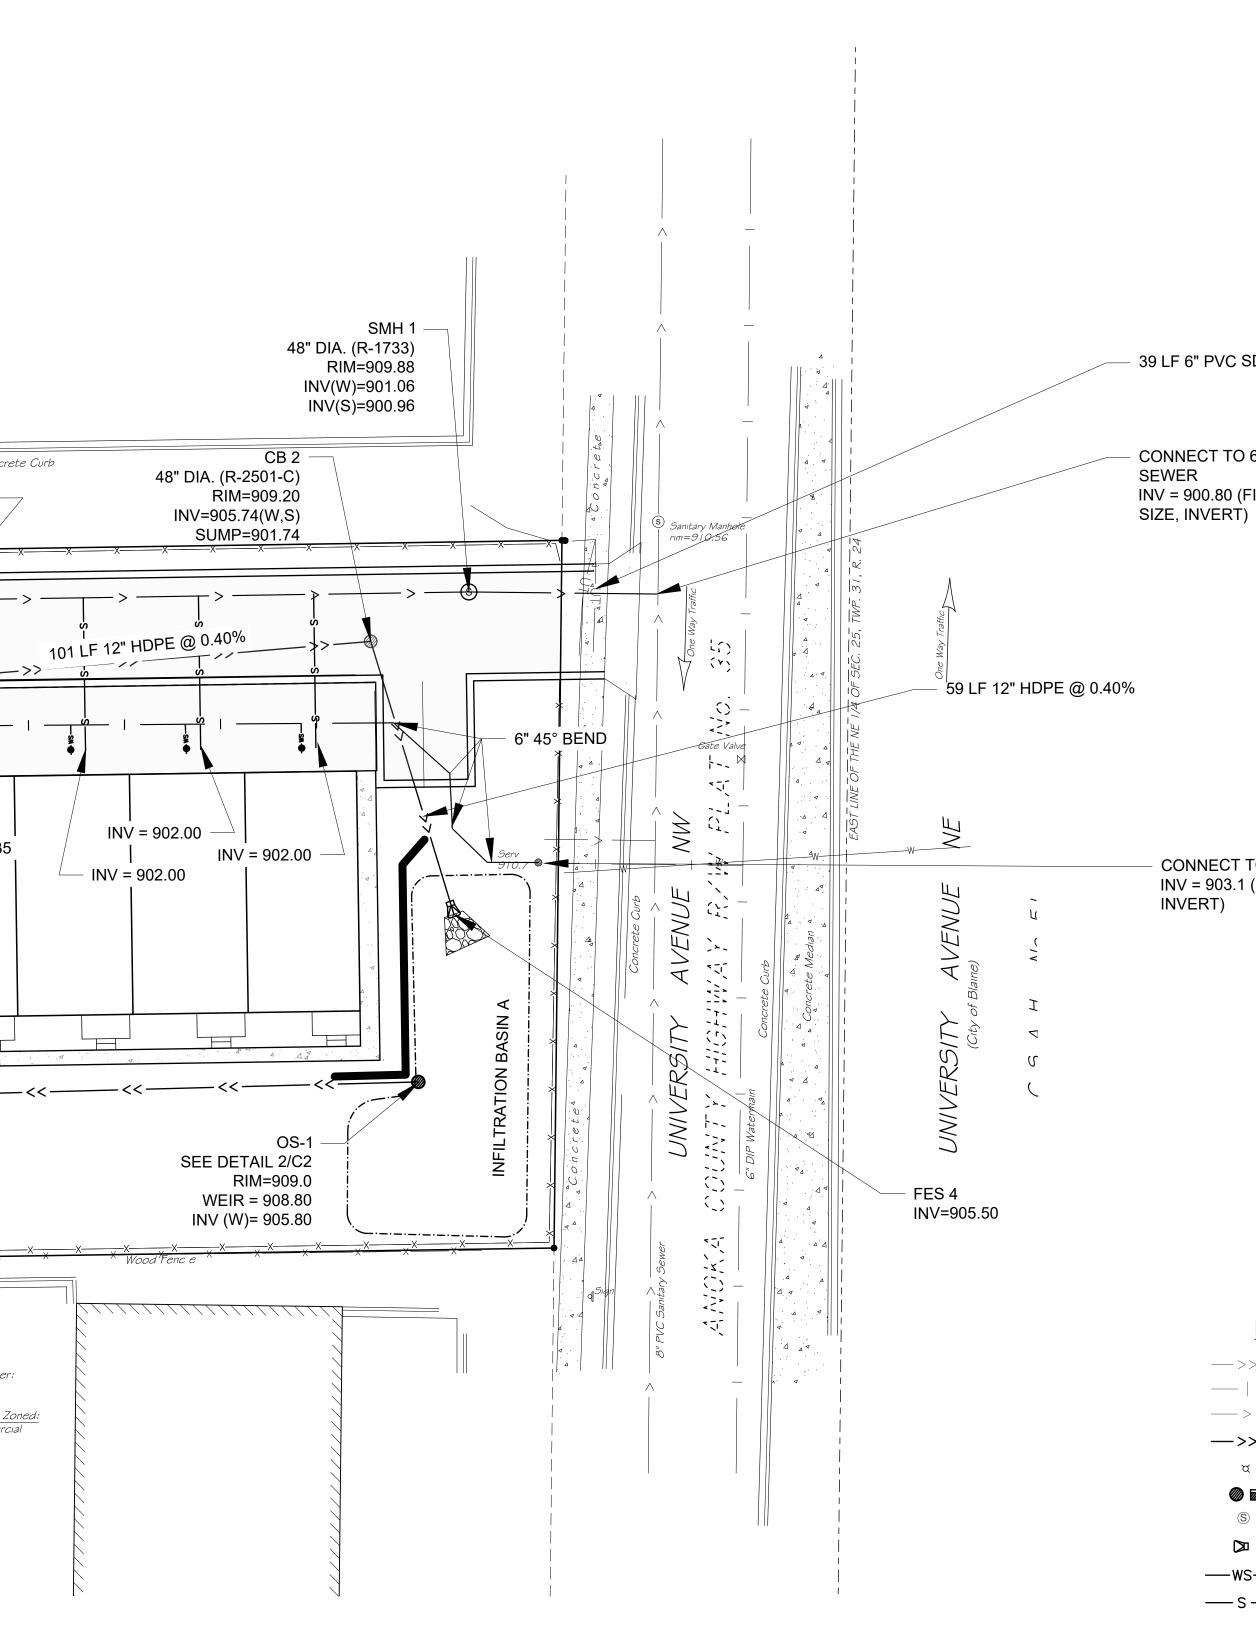



VALUE HOMES 12301 CENTRAL AVE. NE, SUITE 101 BLAINE, MINNESOTA 55434 612.481.7841

CEDARWOOD 9730 UNIVERSITY AVE. NW COON RAPIDS, MINNESOTA

39 LF 6" PVC SDR 35 @ 0.40%

CONNECT TO 6" SANITARY

INV = 900.80 (FIELD VERIFY


CONNECT TO 6" WATER SERVICE INV = 903.1 (FIELD VERIFY SIZE,

UTILITY NOTES:

- MAINTAIN 7.5 FT COVER OVER ALL WATERMAIN. 1 2. ALL WATER SERVICES AND WATERMAIN CROSSING
- SANITARY SEWER SHALL BE INSULATED.
- FIELD VERIFY SANITARY SEWER AND WATERMAIN 3. LOCATION AND ELEVATION.
- 4. ALL HDPE PIPE SHALL BE DUAL-WALL PIPE
- ALL SAN SERV. SHALL BE 4" SCHEDULE 40 PVC 5.

LEGEND

- —>>— EXISTING STORM SEWER
- EXISTING WATERMAIN ____ | ____
- EXISTING SANITARY SEWER ____>____
- —>>— PROPOSED STORM SEWER
- EXISTING HYDRANT ά
- PROPOSED CATCH BASIN EXISTING SANITARY MANHOLE S
- PROPOSED FES
- S PROPOSED SANITARY SERVICE

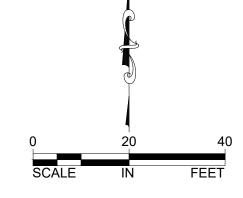


UTILITY PLAN

PROJECT: 90259A SHEET NO.

C8 OF C8



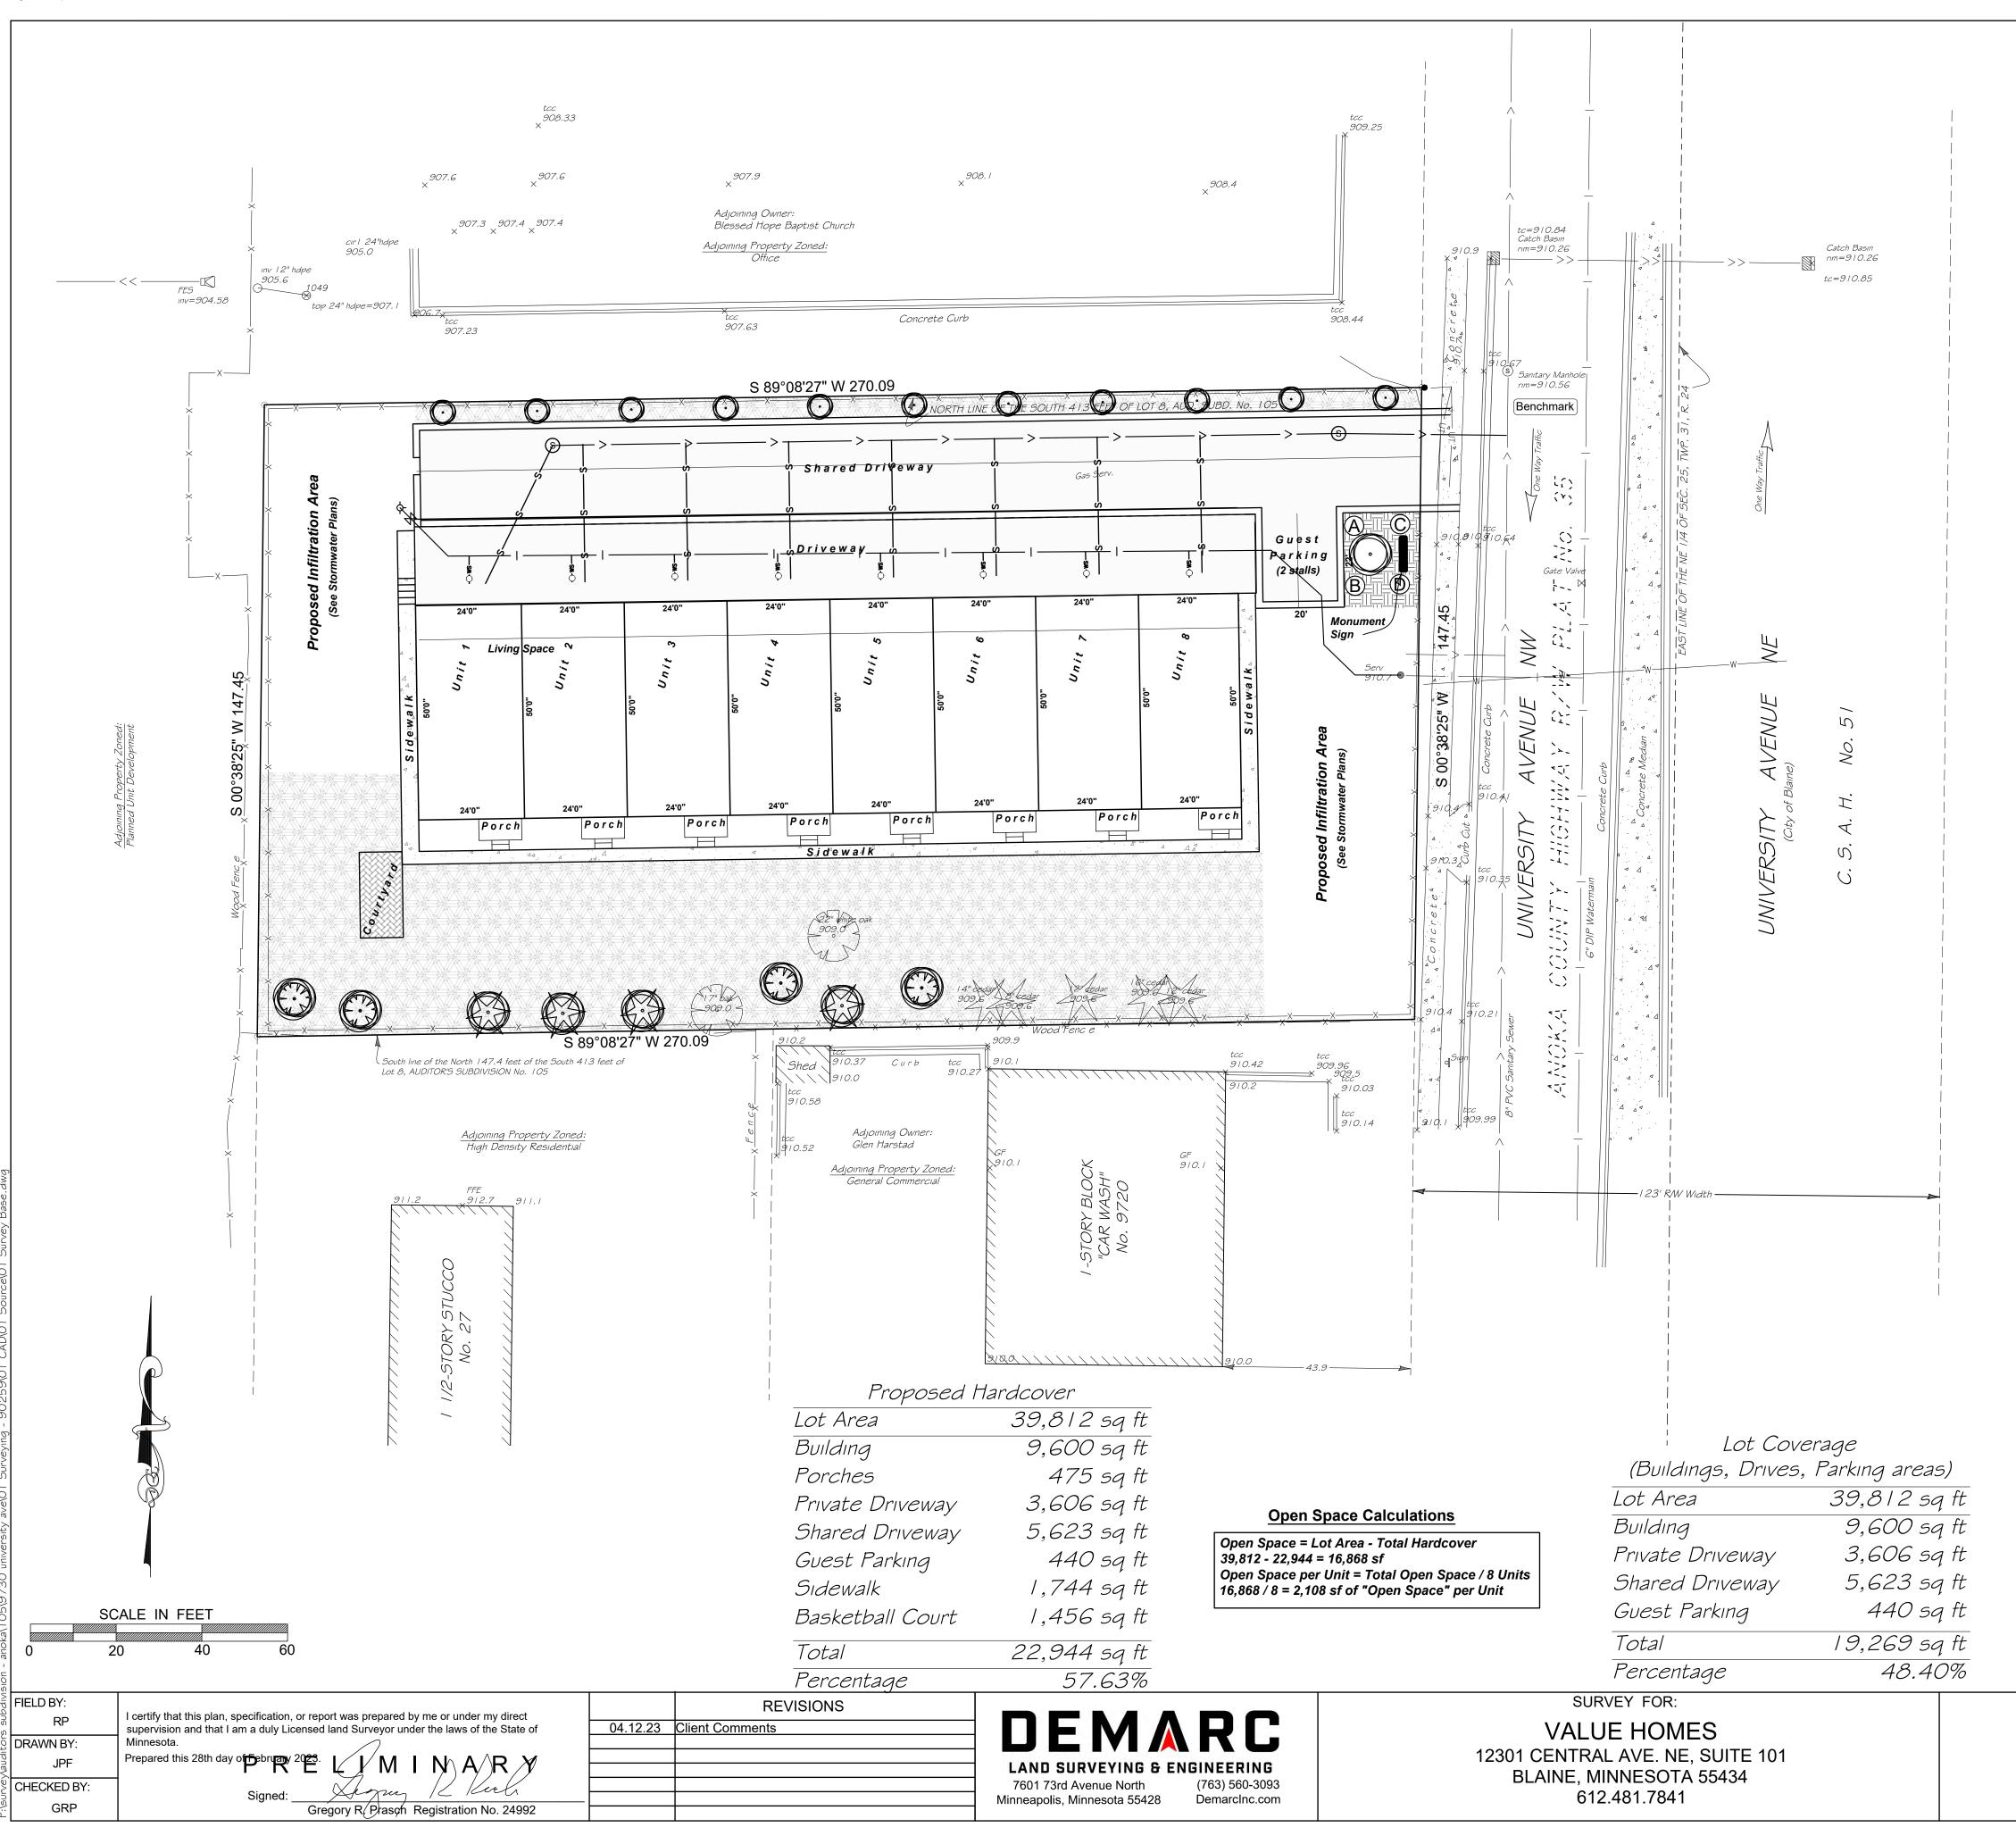

CED 9730 UNIN COON RA

Legend *cped* C Communication Pedestal Riser Denotes Found Iron Monument O Denotes Iron Monument Set tped T Telephone Pedestal Riser Ø Power Pole Gas Meter G Catch Basin FES Training Flared End Section x000.0 Denotes Existing Elevation Water Valve oposed Blackhill Spruce (5) **((·))** Proposed Japanese Lylac (11) Existing Coniferous Tree to Remain Proposed Sod with Sprinkler Systen Existing Deciduous Tree to Remain GAS Gas Main Underground Communications Underground Electric Proposed Maple (4) ------ Storm Sewer Watermain

Zoning Information

Property Currently Zoned: (LDR 1) Low Density Residential District (single family housing)

Zoning Ordinance Requirements:

Building Setbacks - principal structure Front - 40 feet Side Yard - 15 feet (10 feet for garage)

Rear Yard - 50 feet See City code for specifics regarding balconies, decks & porches.

Maximum Building Height - 35 feet Minimum Finished Floor Area - 1,200 sq.ft Maximum lot area to be covered by impervious surface - 20% Minimum number of parking stalls per unit - 3

Refer to City code for additional requirements, exceptions and modifications.

Miscellaneous Notes

Property Address: 9730 University Ave. NW, Coon Rapids, MN 5448
 PID No.: 25-31-24-14-0005

(2) Area of Parcel = 39,812 sq. ft.

- By graphic interpretation only, this property is in Flood Zone "X" (area of minimal flooding) per FEMA panel map number 27003C0319E, effective on 12/16/2015
- Title insurance commitment showing property description and any legal encumbrances of record not provided, survey subject to change. The only easements shown are from plats of record or information provided by client.
- 5 Property located in Section 25, Township 32, Range 24, Anoka County, Minnesota.
- 6 Benchmark: Invert of manhole on University Ave. at the NE corner of property as shown. Information per maps from City of Coon Rapids Elevation = 902.62 feet

Landscape Detail (no scale)

Heavy snow cover on site at time of survey, some improvements may not have been visible.

Typical
UnitABCCCABPorch

A Dogwood x 9 (1 Per Unit + Sign Area)
 B Hydrangea x 9 (1 Per Unit + Sign Area)
 Derbermers 0 (1 Per Unit + Sign Area)


- © Barberry x 9 (1 Per Unit + Sign Area)
- D Spirea x 9 (1 Per Unit + Sign Area)

Decorative Mulch With Irrigation for Plants

Legal Description

The North 147.40 feet of the South 413 feet of Lot 8, Auditor's Subdivision No. 105, Anoka County, Minnesota. Subject to road.

		PROJECT: 90259A
DARWOOD VERSITY AVE, NW	LANDSCAPE PLAN	FB No: 1128-54
PIDS, MINNESOTA		SHEET NO.
		L1 of L1

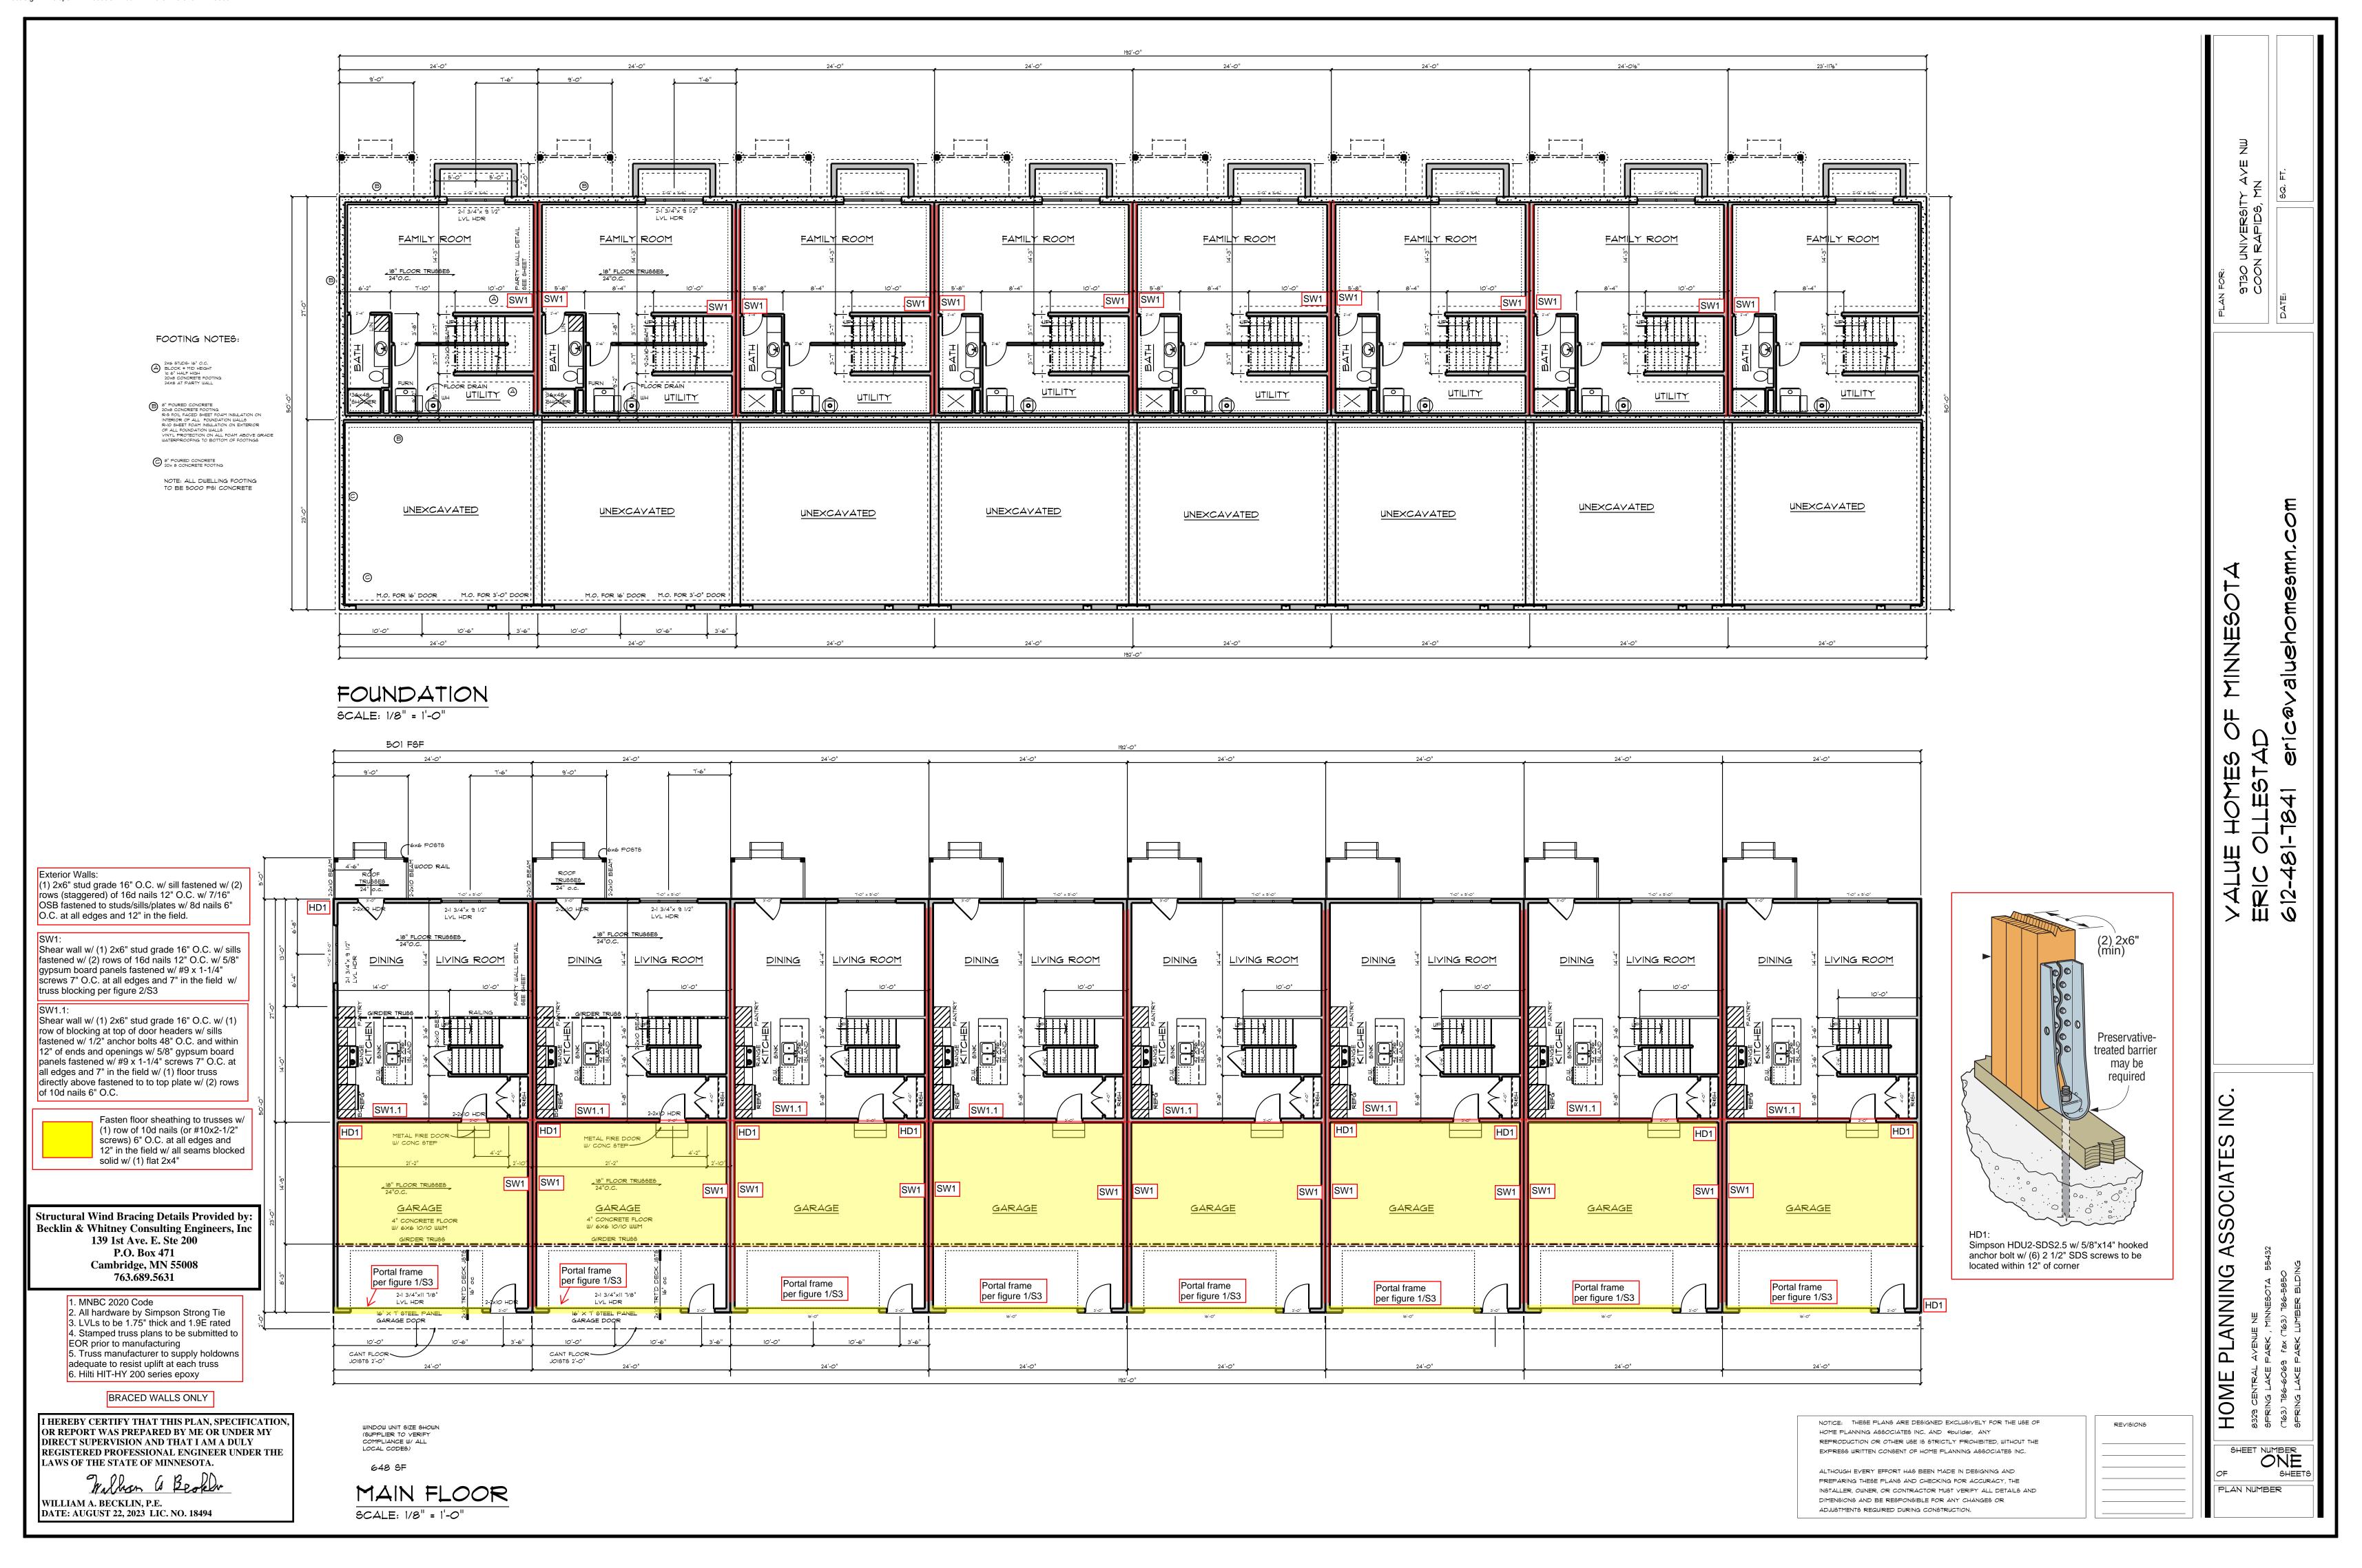

Exterior Walls UNO:

(1) 2x6" stud grade 16" O.C. w/ sill fastened w/ (2) rows (staggered) of 16d nails 12" O.C. w/ 7/16" OSB fastened to studs/sills/plates w/ 8d nails 6" O.C. at all edges and 12" in the field.

SW1:


Shear wall w/ (1) 2x6" stud grade 16" O.C. w/ sills fastened w/ (2) rows of 16d nails 12" O.C. w/ 5/8" gypsum board panels fastened w/ #9 x 1-1/4" screws 7" O.C. at all edges and 7" in the field w/ truss blocking per figure 2/S3

Exterior Walls 1 (EXT1):

WILLIAM A. BECKLIN, P.E.


DATE: AUGUST 22, 2023 LIC. NO. 18494


(1) 2x6" stud grade 16" O.C. w/ sill fastened w/ (2) rows (staggered) of 16d nails 12" O.C. w/ 7/16" OSB fastened to studs/sills/plates w/ 8d nails 4" O.C. at all edges and 8" in the field w/ solid blocking at all seams and blocking at top of headers w/ (1) CS16 fastened to blocking at top of headers w/ 0.148x2-1/2" nails extending 24" (min) beyond each side of opening.

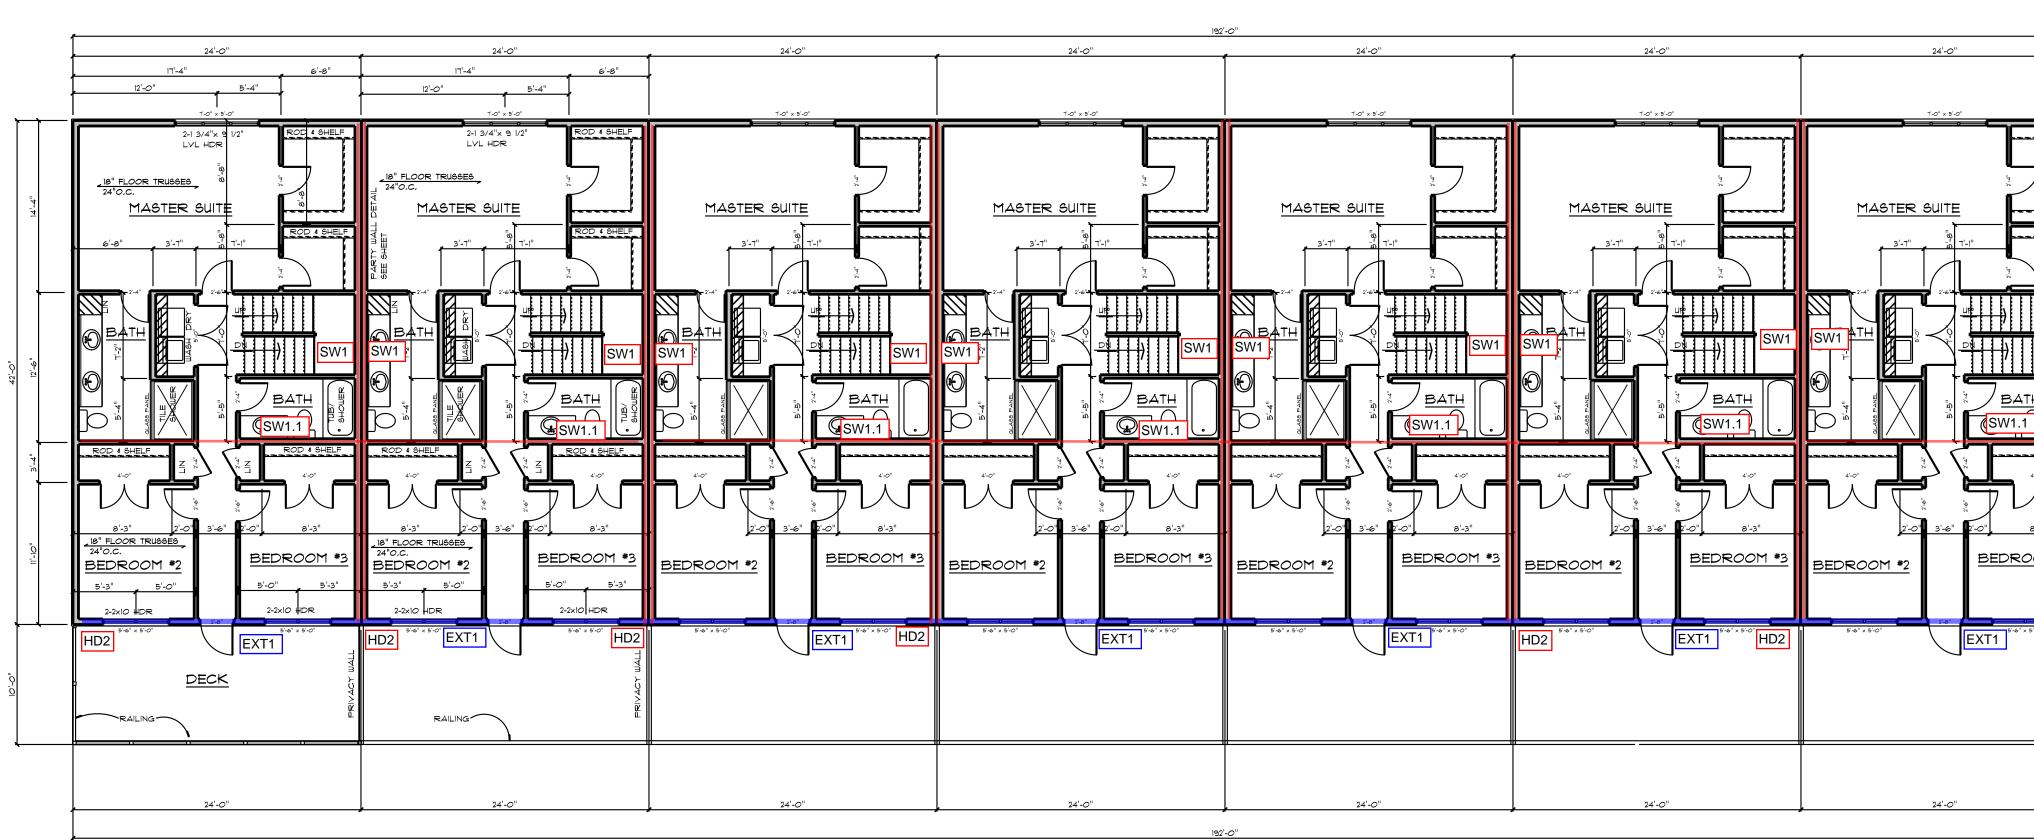

SECOND FLOOR

SCALE: 1/8" = 1'-0"

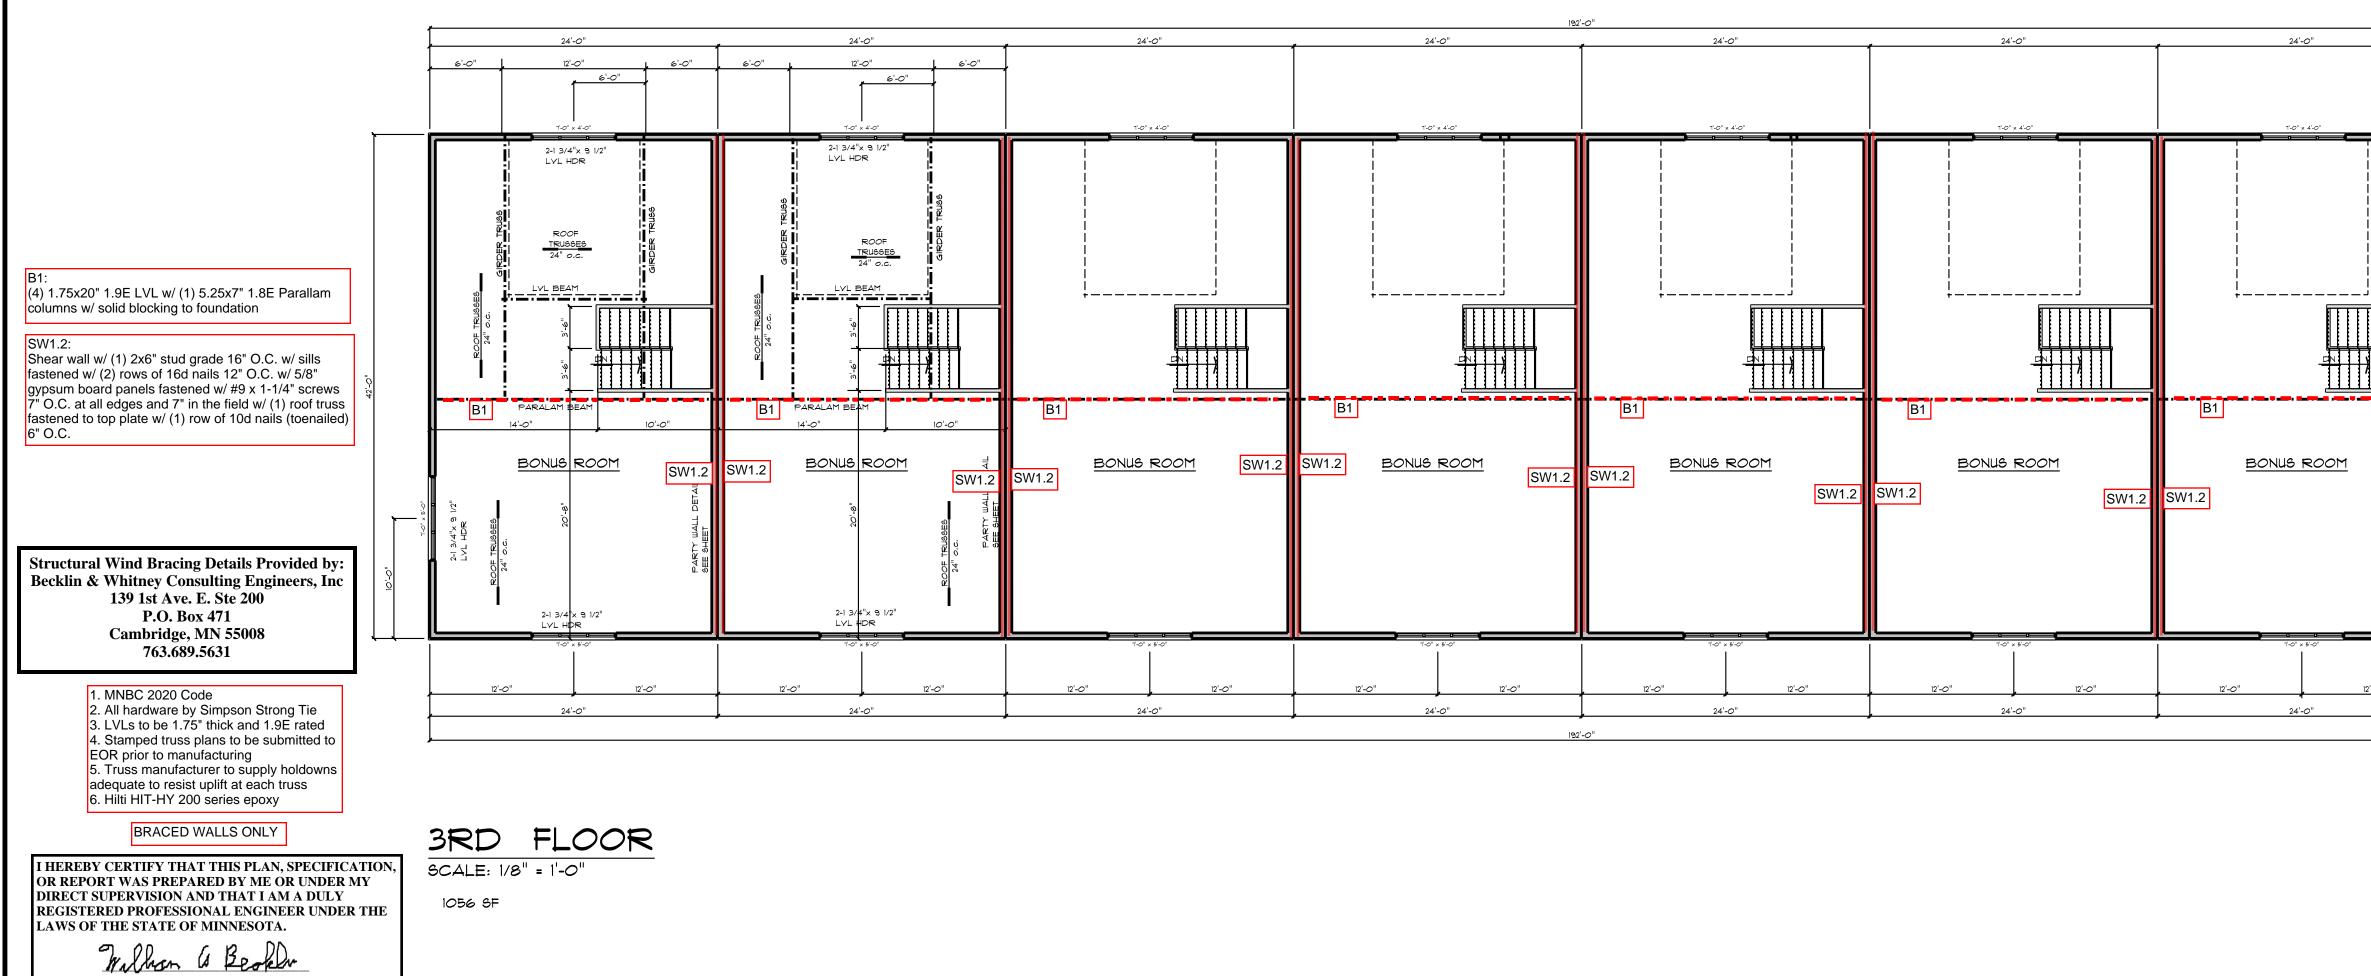

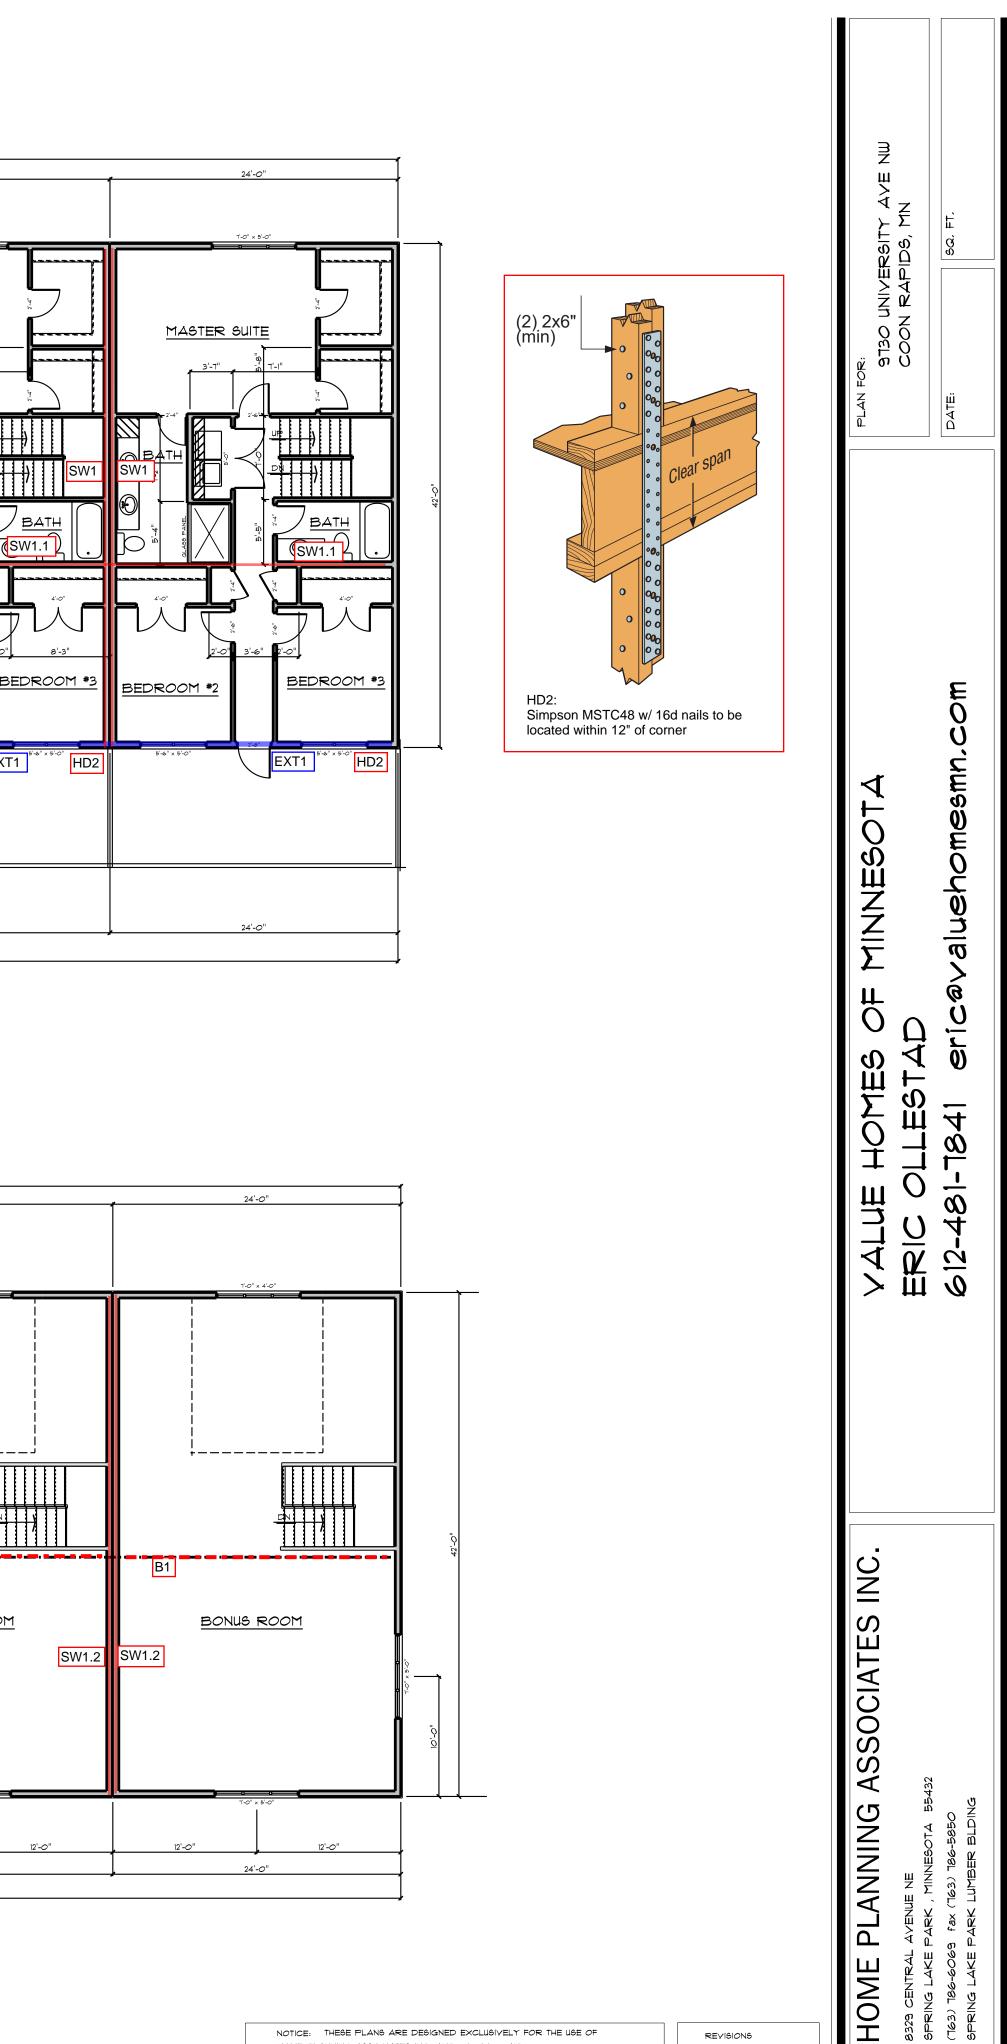

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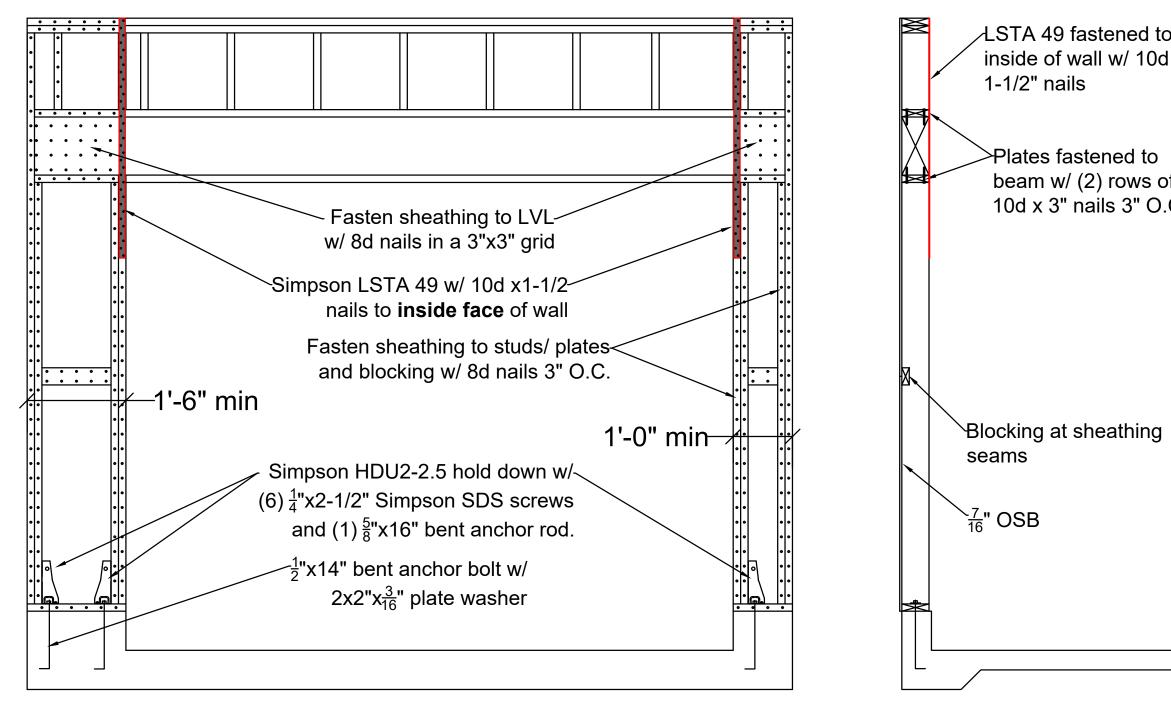


Figure 1: Portal Frame

Section

Structural Wind Bracing Details Provided I Becklin & Whitney Consulting Engineers, I 139 1st Ave. E. Ste 200 P.O. Box 471 Cambridge, MN 55008 763.689.5631	•
1. MNBC 2020 Code 2. All hardware by Simpson Strong Tie	

3. LVLs to be 1.75" thick and 1.9E rated 4. Stamped truss plans to be submitted to EOR prior to manufacturing 5. Truss manufacturer to supply holdowns

adequate to resist uplift at each truss 6. Hilti HIT-HY 200 series epoxy

BRACED WALLS ONLY

I HEREBY CERTIFY THAT THIS PLAN, SPECIFICATION, OR REPORT WAS PREPARED BY ME OR UNDER MY DIRECT SUPERVISION AND THAT I AM A DULY **REGISTERED PROFESSIONAL ENGINEER UNDER THE** LAWS OF THE STATE OF MINNESOTA. Walkon & Beoken

WILLIAM A. BECKLIN, P.E. DATE: AUGUST 22, 2023 LIC. NO. 18494

/LSTA 49 fastened to inside of wall w/ 10d x

>Plates fastened to beam w/ (2) rows of 10d x 3" nails 3" O.C.

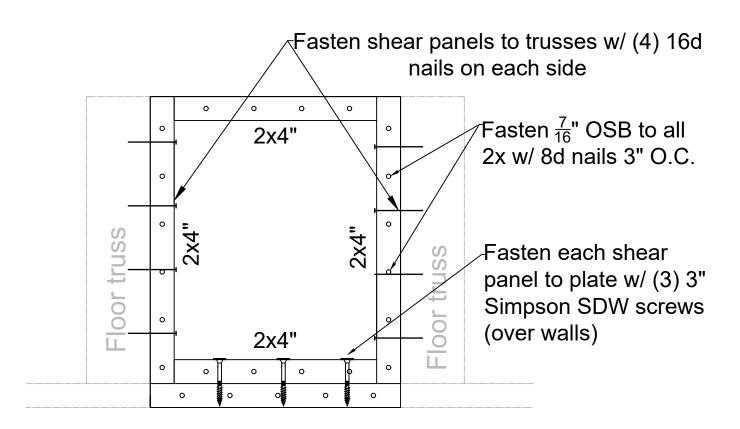


Figure 2: Floor Truss Blocking

	PLAN FOR: 9730 UNIVERSITY AVE NW COON RAPIDS, MN DATE: BATE: BATE: BATE:
	VALUE HOMES OF MINNESOTA ERIC OLLESTAD 612-481-7841 eric@valuehomesmn.com
IE USE OF HOUT THE INC. D HE HE AND	Image: Second

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Susan Burgmeier Susan.Burgmeier@co.anoka.mn.us

Associate Traffic Technician

Anoka County

Signing Group: Highway Permits

Security Level: Email, Account Authentication (Optional)

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Holder: Highway Permits HighwayPermits@co.anoka.mn.us Pool: StateLocal Pool: Anoka County

Signature

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