### NOT VALID UNLESS SIGNED BY ANOKA COUNTY PERMIT NUMBER

# Anoka County MINNESOTA

### ANOKA COUNTY TRANSPORTATION DIVISION 1440 BUNKER LAKE BLVD NW ANDOVER, MN 55304

763-324-3176 highwaypermits@anokacountymn.gov

RIGHT OF WAY X
COMMERCIAL ACCESS

APPLICATION FOR PERMIT FOR INSTALLATION OF UTILITIES OR PLACING OBSTRUCTIONS ON THE COUNTY HIGHWAY SYSTEM
ALL APPLICANTS MUST BE REGISTERED PRIOR TO PERMIT APPROVAL

APPLICANT NAME CenterPoint Energy CONTACT PERSON Jake Jacobson

ADDRESS 505 Nicollet Mall - Floor 4 PO Box 59038 CITY Minneapolis, MN 55459

PHONE NUMBER 612-321-4475 EMAIL JAKE.JACOBSON@CENTERPOINTENERGY.COM

COMPANY OR INDIVIDUAL PERFORMING WORK Michels Utility Services

CONTACT PERSON Jake Jacobson EMAIL JAKE.JACOBSON@CENTERPOINTENERGY.COM

PHONE NUMBER 612-321-4475

PERMIT WORK TO START 08/15/2025

117358910 / 25-80857

PERMIT WORK TO BE COMPLETED 11/01/2025

**DURATION OF JOB** 2 days

ARE YOU BEING ASKED TO RELOCATE DUE TO A COUNTY PROJECT? Yes

ANOKA COUNTY PROJECT NUMBER SP 0208-169

WORK SITE ADDRESS 1374 109TH AVE NE

CITY Blaine

METHOD OF INSTALLATION/CONSTRUCTION Hole

NATURE OF WORK ABANDONING & RETIRING GAS MAIN FOR SP 0208-169. TWO HOLES ALONG CR 12 ARE REQUIRED FOR ACCESSING GAS MAIN FOR ABANDONMENT PROCEDURES.

SURFACE TO BE DISTURBED SITE

SITE PLAN

IF THE ROADWAY IS ENCROACHED, YOU MUST ATTACH A TRAFFIC CONTROL PLAN AND/OR REFERENCE THE MOST CURRENT VERSION OF THE MN TEMPORARY TRAFFIC CONTROL FIELD MANUAL (3+ DAYS REQUIRES PLANS TO BE SIGNED BY A LICENSED PE).

X DITCH/BLVD

GRAVEL

**BITUMINOUS** 

CONCRETE

IC CICNUMO AND CTRIC

NONE IS SIGNING AND STRIPING REQUIRED? NO

DEPTH FROM SURFACE 4-5

(60" minimum under county roads)

SIZE AND KIND OF PIPE/CABLE 4" PLASTIC GAS MAIN

NUMBER OF EXCAVATIONS 2

SIZE OF EXCAVATIONS 5' X 5' X 4'

(Length, width, and depth)

LOCATION OF EXCAVATIONS ALL EXCAVATIONS ARE TO BE PROTECTED AT ALL TIMES AND THEN BACKFILLED WHEN UNATTENDED AND/OR OVERNIGHT

Specific written descriptions of excavations - if shown on attached drawing, drawing shall be specific with depth and distance from centerline, curb, or other distinguishable location. Traffic control plans cannot be approved without specific excavation descriptions.

ALONG THE SOUTH SIDE OF CR 12 AT THE INTERSECTION OF ULYSSES ST & BALTIMORE ST.

THIS PERMIT COVERS THE RIGHT OF WAY IN ANOKA COUNTY ONLY

Docusign Envelope ID: 284AA14C-59DA-418B-9284-AF63E2CE1F49



### ANOKA COUNTY TRANSPORTATION DIVISION 1440 BUNKER LAKE BLVD NW ANDOVER, MN 55304

PERMIT PHONE: 763-324-3176 highwaypermits@anokacountymn.gov

### **GENERAL INFORMATION**

One permit must be approved for each county road on which work will be performed prior to any work within the right of way by any utility/contractor. Emergency conditions which threaten the safety of the public and require immediate repair are exceptions to this rule. Under those circumstances, the utility/contractor is permitted to begin and/or complete the necessary repairs. The Anoka County Transportation Division (ACTD) shall be notified of emergency repairs as soon as feasible and a written permit is to be completed within two business days of occurrence.

A license-permit bond is generally required of the contractor as part of the registration process, the amount of which will be determined by the nature of the utility work.

A sketch or drawing shall accompany each permit application which will show the location of the proposed work/utility with reference to the county highway center line and right of way line. A complete set of plans is required for all sewer/water projects.

It shall be the responsibility of the applicant to determine which of the special conditions apply to each permit.

DEB32C66BD924B0

ACTD reserves the right to revoke any utility permit and halt work, if, upon inspection of any job site, the special conditions are not met, and/or a hazard exists for the applicant or public safety is threatened. The failure to comply with the terms and conditions of any applicable Federal, State, Regional, and local laws, rules and regulations, including any provision of Anoka County's Right-of-Way Ordinance shall be cause for immediate revocation of a permit.

The applicant shall notify ACTD immediately upon completion of project so that the ACTD can inspect the site to determine if restoration has been satisfactorily completed.

The undersigned hereby accepts the terms and conditions of this permit and the regulations of Anoka County, and agrees to fully comply therewith to the satisfaction of the ACTD. The county of Anoka, its officials, employees, and agents, shall be held harmless, by the applicant/permittee, from any demands, claims, lawsuits, or damages relating to the work described in this permit.

•				•	-	 · ·	 		•	
APPLI	CANT'S	SIGNAT	TURE	DocuSigned	by:			DATE	8/11/2025	
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### **AUTHORIZATION OF PERMIT**

In consideration of the applicant's agreement to comply in all respects with the regulations of the ACTD covering such operations, permission is hereby granted for the work to be done as described in the above application. Said work to be done in accordance with the general conditions listed above and the special conditions required as hereby stated. It is expressly understood that this permit is conditioned upon replacement or restoration of the county highway and its right of way to their original or to a satisfactory condition. It is further understood that this permit is issued subject to the approval of local city or township authorities having joint supervision over said street or highway.

APPROVED BY:	DATE
TITLE: Traffic Technician	

NOT VALID UNLESS SIGNED BY ANOKA COUNTY



### ANOKA COUNTY TRANSPORTATION DIVISION

### 1440 BUNKER LAKE BLVD NW

ANDOVER, MN 55304 PERMIT PHONE: 763-324-3176

highwaypermits@anokacountymn.gov

### SPECIAL CONDITIONS

### TRAFFIC CONTROL

- 1) Detours
  - a) Detailed detour layouts shall be submitted to the traffic engineer for approval.
  - b) No detours shall be permitted without prior approval of the Anoka county traffic engineer.
  - c) A ten day notice must be given prior to the installation of any detour.
  - d) It shall be the responsibility of the applicant to notify Anoka county central communications, local government bodies, and any affected bus companies ten days prior to any road closures/detours.
  - e) Immediately upon completion of work and/or detours, all posts, barricades, and signs shall be removed from the right of way.
- 2) Traffic control devices
  - a) All traffic control devices, barricades, flashers, etc., shall be furnished by the applicant and shall be in accordance with the most recent edition of the Minnesota manual on uniform traffic control devices and temporary traffic control zone layouts – field manual of the same manual.

### **CONSTRUCTION REQUIREMENTS**

- 1) Open cutting of bituminous or concrete surfaced roads will be allowed only at the discretion of the county engineer.
- 2) Neither supplies nor excavation materials shall be placed on the bituminous or concrete surface at any time.
- 3) No trenches will be allowed to remain open overnight.
- 4) Materials removed from the trench shall be used as backfill insofar as they are suitable. All backfill material shall conform to MNDOT specifications for compaction. The use of heavy equipment on top of trench, slapping with backhoe bucket and/or back casting to achieve compaction is prohibited. Any additional material required to back fill to the original grade shall be furnished by the applicant at no expense to the ACTD. All the base and surface courses damaged during construction operations shall be restored to a condition equal to or better than before operations began. The applicant shall be responsible for and restore any settlement
- 5) All culverts, ditches, shoulders, and backslopes shall be restored to their original condition unless otherwise directed by the ACTD. Shoulders which have been previously constructed or reconstructed with special materials shall be replaced in kind. Restoration of signs, guardrails, guard posts, etc., are the sole responsibility of the applicant and shall be restored to their original condition.
- 6) All roadway maintenance required within the limits of the utility project that is related to the applicant's activities shall be the sole responsibility of the applicant for one year after completion of the project. Upon completion of the restoration work, the applicant shall request a final inspection by the ACTD. The ACTD's approved completion date shall be the starting date of the applicant's one-year responsibility.

### HORIZONTAL BORING AND JACKING

- 1) All hard surface roadways shall be jacked or bored.
- 2) All crossings of Anoka County maintained roadbeds, shall be made by boring inside a casing or carrier pipe, or by jacking unless otherwise directed by the Anoka County Engineer. The auger shall lead the casing or carrier pipe by at least six inches whenever possible and never lead the carrier pipe by more than one inch.
- 3) The use of pneumatic devices to facilitate the roadbed crossings will be allowed in most cases with prior approval. In the event approval is not granted and applicant uses a pneumatic device to cross a roadbed and encounters an obstruction and/or unstable subbase material which makes forward or reverse motion of pneumatic device impossible, said pneumatic device then becomes part of the roadway subbase and permission to excavate to retrieve device will not be granted.
- 4) If a pneumatic device is used for the work permitted herein, the installation must be kept to a minimum of four feet below the surface of the roadway if the pneumatic device is less than two inches in diameter, and a minimum of five feet below the surface of the roadway if the pneumatic device is two inches in diameter or larger.

### **BITUMINOUS RESTORATION**

- 1) The locations and dimensions of all openings to be made in the bituminous surface shall be approved by the ACTD prior to any cutting or any surface opening operations.
- 2) All openings in bituminous surfaces shall be cut in a straight line with the sides smooth and vertical. No ragged edges will be permitted. Cutting shall be done with a concrete saw.
- 3) All necessary dust control operations shall be carried out by the applicant at no expense to Anoka County.
- 4) The minimum requirement for subgrade replacement shall be the upper twelve inches of material and shall meet MNDOT specifications for class five placed in six inch layers compacted to one hundred percent of optimum density.
- 5) All manhole casings, gate valves, and other utility structures shall be set one quarter inch below the top of the finished surface.
- 6) Bituminous tack coat materials and application thereof shall conform to MNDOT specification 2357.
- 7) All bituminous surfacing shall be replaced as soon as practicable after the base construction. All bituminous surfacing shall be machine laid. Any exceptions must be approved by the ACTD. Bituminous surfacing shall be replaced to original pavement depth or to a minimum of six inches of bituminous mixture (2360), whichever is greater. Bituminous mixtures must be placed in lifts not exceeding three inches in thickness for base and binder courses and not exceeding two inches for the wear course.
- 8) All surface restoration regardless of size shall conform to existing grades.
- 9) Any unnecessary or negligent damage to bituminous surface in conjunction with the installation and/or repair of a utility shall be cut out and replaced in kind as directed by the ACTD.



### ANOKA COUNTY TRANSPORTATION DIVISION

### 1440 BUNKER LAKE BLVD NW ANDOVER, MN 55304

PERMIT PHONE: 763-324-3176

highwaypermits@anokacountymn.gov

### **CONCRETE RESTORATION**

1) Curb and gutter, sidewalks, and driveways shall be restored in accordance with MNDOT specifications 2531 and 2521.

### **UTILITY LINES**

- 1) There shall be only a single pole line on the county right of way on either side of the center line thereof.
- 2) Exact locations of longitudinal installations on county highways shall be located as directed by the ACTD.

### **SECTION CORNER MONUMENTS**


- 1) Utility locations shall not interfere with the location of any section, quarter, witness, or right of way monuments. For assistance in locations, contact the Anoka County Surveyor's Office.
- 2) The applicant shall be responsible for replacement of any existing property irons disturbed during construction.
- 3) The applicant shall notify the Anoka County Surveyor's Office three working days in advance of any anticipated disturbance of any section, quarter, witness, or right of way monuments.
- 4) Any monument disturbed during the course of construction, shall be reset by the Anoka County Surveyor's Office at the expense of the applicant.

### ATTACHING TO BRIDGES/STRUCTURES

 No utility is permitted to be hung from, or otherwise attached to, any bridge or structure without having detailed plans approved by the Anoka County Engineer. These plans are to show approaches to the structure, method of installation, type, and dimension of housing for the utility.

### **ADDITIONAL PROVISIONS**

- 1) All subcontractors, installers, and crew shall possess a physical or electronic copy of all documents in relation to the approved permit prior to the commencement of work and be kept on site. This includes, but it not limited to the following:
  - a) Approved permit
  - b) Any/all traffic control plans and/or layouts
- Shall notify Anoka County Permits at 763-324-3176 or highwaypermits@anokacountymn.gov
  - a) At least 36 hours prior to the commencement of work
  - b) With time frame of proposed of work
  - c) Anticipated traffic control
  - d) When work is complete including restorations to request a final inspection
- 3) No work during inclement weather or when plows are out in any capacity
- 4) All traffic control shall be in accordance with the most current version of the MnDOT Temporary Traffic Control Field Manual
- 5) For staking of right-of way or proposed infrastructure, contact Chris Osterhus at 763-324-3189 a minimum of 48 hours prior to the commencement of work.

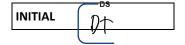

CONSTRUCTION NOTES

Obtain Construction Plans from Designer prior to starting job.

Long side mains and services to be installed below proposed

CenterPoint Energy Construction and Services Manual.

with service and abandonments completed.

sub-cuts (See Construction Plans).

Verify WO# 117320067, 117321379 & 117321387 are fully installed

Coordinate with Contractor / Engineering Firm for exact locations of proposed structures and facilities prior to installation of gas facilities.

Install new main as shown or as directed in field at time of installation. Contact Engineering for approval of field generated changes.

MGC#25-80857

## PROJECT OVERVIEW MAP

**SCALE: NOT TO SCALE** 

# **SHEET**

COPIES:
PIPELINE INTEGRITY PACKET: N
STATION MANAGER: N/A
DD NUMBER: 573-007
CORROSION: ROSS BARKER EMP: NEW: 16259419 16259420

CenterPoint.

PROJECT #: **117358910** 

CITY: BLAINE

Pipe Summary

64' 2" PE Class 6

273' 4" PE Class 6

9715' 6" PE Class 6

10052' TOTAL PIPE

1533' 2" PE Class 6

223' 2" STL Class 6

824' 4" PE Class 6

3' 4" STL Class 6

90' 6" STL Class 6

11193' TOTAL PIPE

1277' GENERIC PLASTIC OTHER MAIN - 2"

1581' GENERIC PLASTIC OTHER MAIN - 4"

5662' GENERIC PLASTIC OTHER MAIN - 6"

**Proposed Abandoned Pipe** 

COUNTY: ANOKA

PROPRIETARY AND CONFIDENTIAL

- IN SERVICE PROPOSED

PROPOSED ABANDONED

NOT A PART OF PROJECT

——— ABANDONED

OLD: 13130304 SITE CONTACT: STACY KNAPP UTILITY COORDINATOR T2 UTILITY ENGINEERS 612-500-2073

16276231 16276232

SURVEYOR REQUIRED? Y RETURN PACKET TO ENG? N JOB BRIEFING REQUIRED? Y

GFIP #: 331-2025 PERMITS: CITY OF BLAINE ANOKA COUNTY

### All test points should be installed in the boulevard or other acceptable locations and avoid placement in driving lanes. Verify Coating test results if required prior to abandoning main. CONSTRUCTION PROCEDURES Install; Clean and Test; and Put in Service; Proposed new main per

Procedure for tapping or making tie-ins to existing gas mains: Verify existing gas main size, type, and location prior to tapping or making tie-in. Monitor and verify, using a pressure gauge, existing gas main Pressure Class within the bell hole of tap location or tie-in location prior to tapping or making tie-in.

Purge new main until essentially 100% reading is obtained on Combustible Gas Indicator. See CenterPoint Energy Construction and Service Manual Section CS-B-1.230 for purging mains into service. Complete all Service / Meter Work as directed. (See Service Survey)

See Abandonment Procedures for abandonment and purging procedures.

Install a marker ball at a new end of main, at a valve, at each ell of a horizontal offset, at road crossings and at any fitting or pressure control identified as needing to be located in the future. Refer to CenterPoint Energy Construction and Service Manual section CS-B-1.310 for installation procedures.

NOTE: BORE ALL PAVED STREETS AND DRIVEWAYS Minimum depth requirements for crossings of state highways and county roads is 60". Minimum depth requirements for crossings of city streets and township roads is 48". Minimum depth for parallel installations on state highways and county roads is 36". Minimum depth for parallel installations on city streets and township roads is 30". All steel pipe welds to be coated with 2 part epoxy.

VALVE/TEST POINT ROADWAY ABANDONMENT PROCEDURES Within construction limits of road construction projects, remove valve box and cover. Restore as needed. For CNP only projects, remove valve box and cover when possible and restore with in-kind material. If roadway cannot be removed, fill with sand and foam the top 2". The cover will remain in place. Fill out EMP Form 130 for valve abandonments. Verify CP test point with corrosion tech prior to abandonment.

When butt fusing to existing in-service polyethylene, visually inspect for the presence of hydrocarbon permeation immediately after removing fusion iron. If any bubbling is identified on the heated surface, do not join to new PE pipe. Allow to cool and cut this end off (12" length) and send to the Golden Valley Lab with street location and W.O. #. Complete tie- in/extension using an electrofusion coupling(s).

Pipe > 4-inches Diameter (Unregulated PCB area): Pipe being removed must be tested for PCBs and asbestos to confirm disposal requirements - contact Environmental, 612-861-8471. For pipe to be abandoned, refer to CNP Construction and Service Manual CS-B-1.110, CS-B-1.330, and CS-B-1.100.

Pipe ≤ 4-inches Diameter (Unregulated PCB area): Project area cleared for internal impacts. Pipe being removed is unregulated for disposal if coating does not exist or is non-asbestos. Refer to CNP Construction and Service Manual CS-B-1.110, CS-B-1.330, and CS-B-1.100, for pipe to be abandoned.

**CORROSION TECH FOR AREA IS** ROSS BAKER CELL, 952-322-0383

Caution - High Pressure Natural Gas Line within project area. Protect at all times. If excavation is to occur within 25 feet of the High Pressure Natural Gas Line, coordinate work with Metro Foreign Construction or Outstate/Suburban C&M. Any crossings at High Pressure Natural Gas Line must maintain a minimum of 18-inches clearance. 12-inches of clearance is acceptable with Engineering approval.

### ABANDONMENT PROCEDURES See Construction Procedures for installation of mains and services prior to abandonments. The project includes work on one-way feed mains. Ensure all proposed main is in service, all taps are completed And all services have been transferred to new main prior to abandonments. Cut and abandon existing main as shown. Purge abandoned mains until essentially 0% gas reading is obtained on Combustible Gas Indicator. See CenterPoint Energy Construction and Services Manual Section CS-B-1.110 and Section CS-B-1.230 for

purging mains out of service using air movers. Cross Compression may be used to lower pressure in line prior to venting trapped gas and purging line out of service. Warning - cross compression into a one-way feed system requires Engineering approval.

Do not exceed 50 PSIG on the outlet side of the Cross Compression unit. Monitor using digital gauge on outlet side of unit. Warning - cross compression into a one-way feed system requires Engineering approval. Trapped gas to be transferred to CL-E (200) PSIG system. Do not exceed 200 PSIG on the outlet side of the Cross Compression unit. Monitor using


Trapped gas to be transferred to CL-6 (50) PSIG system.


Contact Area C&M Personnel prior to starting job to review Cross Compression process and to arrange field support.

For typical connection of Cross Compression: Plastic Mains: Use a 1-1/4" PE Service Tee with a temp. 1-1/4" anodeless riser with valve Steel Mains: Use a 2" TOR Drill Nipple.

Contact Engineering with questions

digital gauge on outlet side of unit.

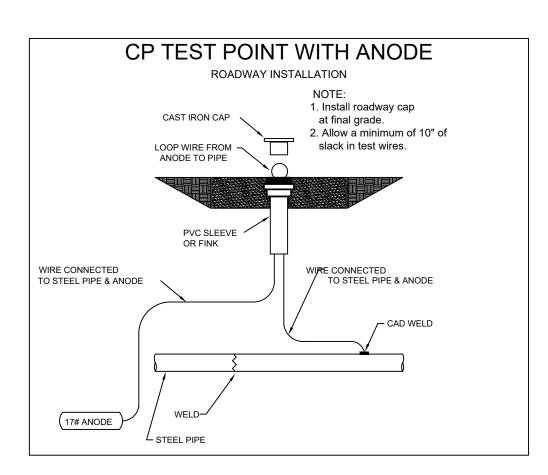

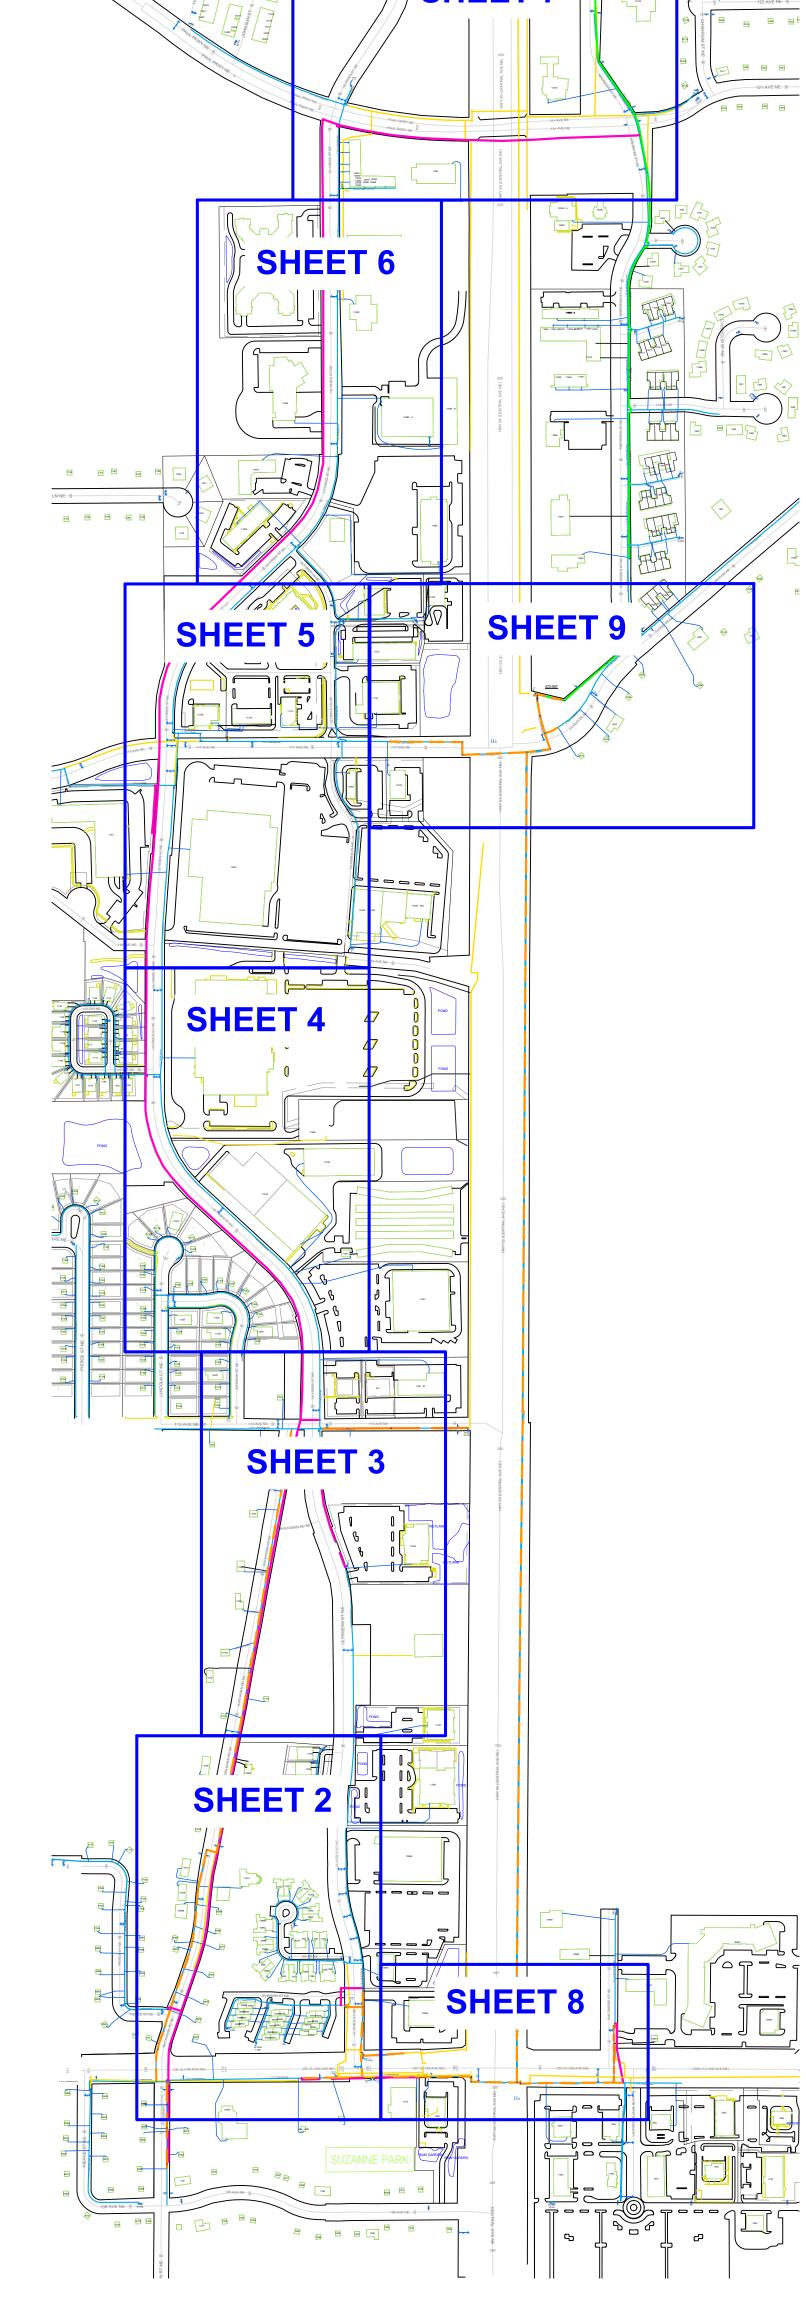


I hereby certify that this plan, specification, or report was prepared by me or under my direct supervision and that I am a duly Licensed Professional Engineer under the laws of the state of Minnesota.


Eric Yang \_License Number: \_\_56613 Date: 8/5/2025

ULYSSES ST & BUCHANAN ST DESIGNER: JAKE JACOBSON PHONE#: 612-321-4475 DRAWN BY: JAKE JACOBSON DESIGN DATE: 08/04/2025 **REVISION INFO:** 

PROJECT DESCRIPTION: SREL

NOT TO SCALE SHEET 1 OF 9

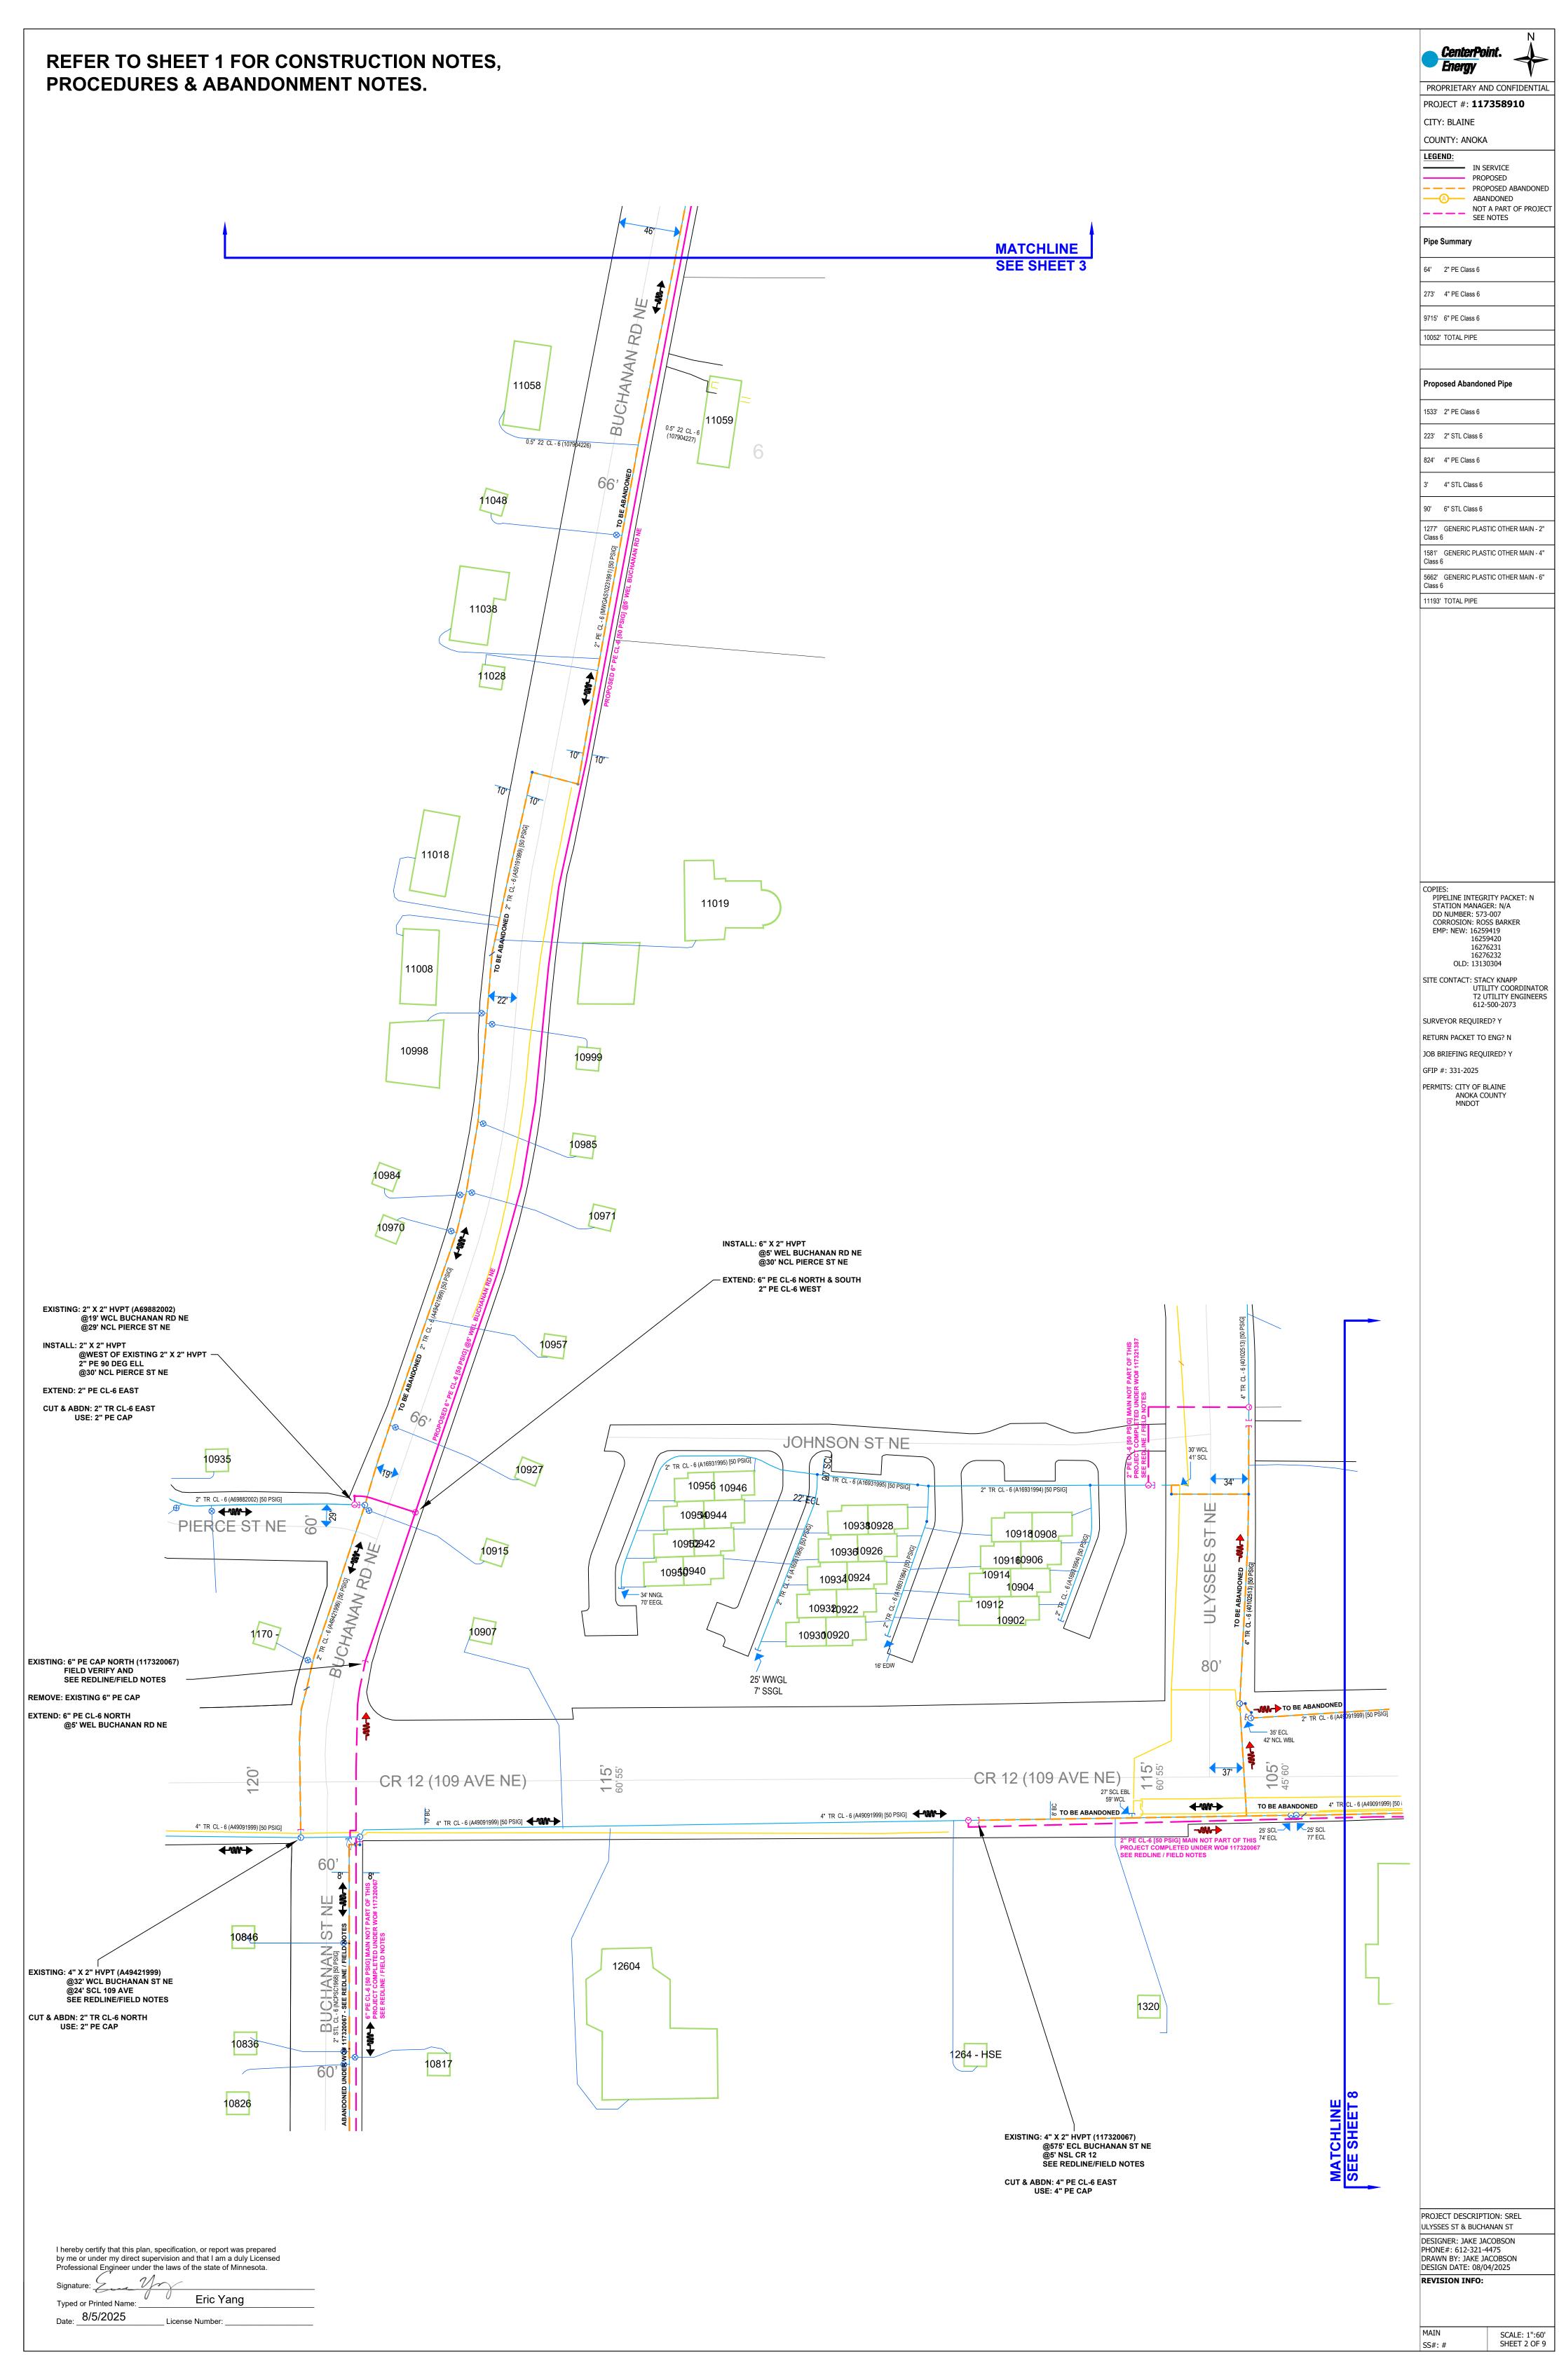

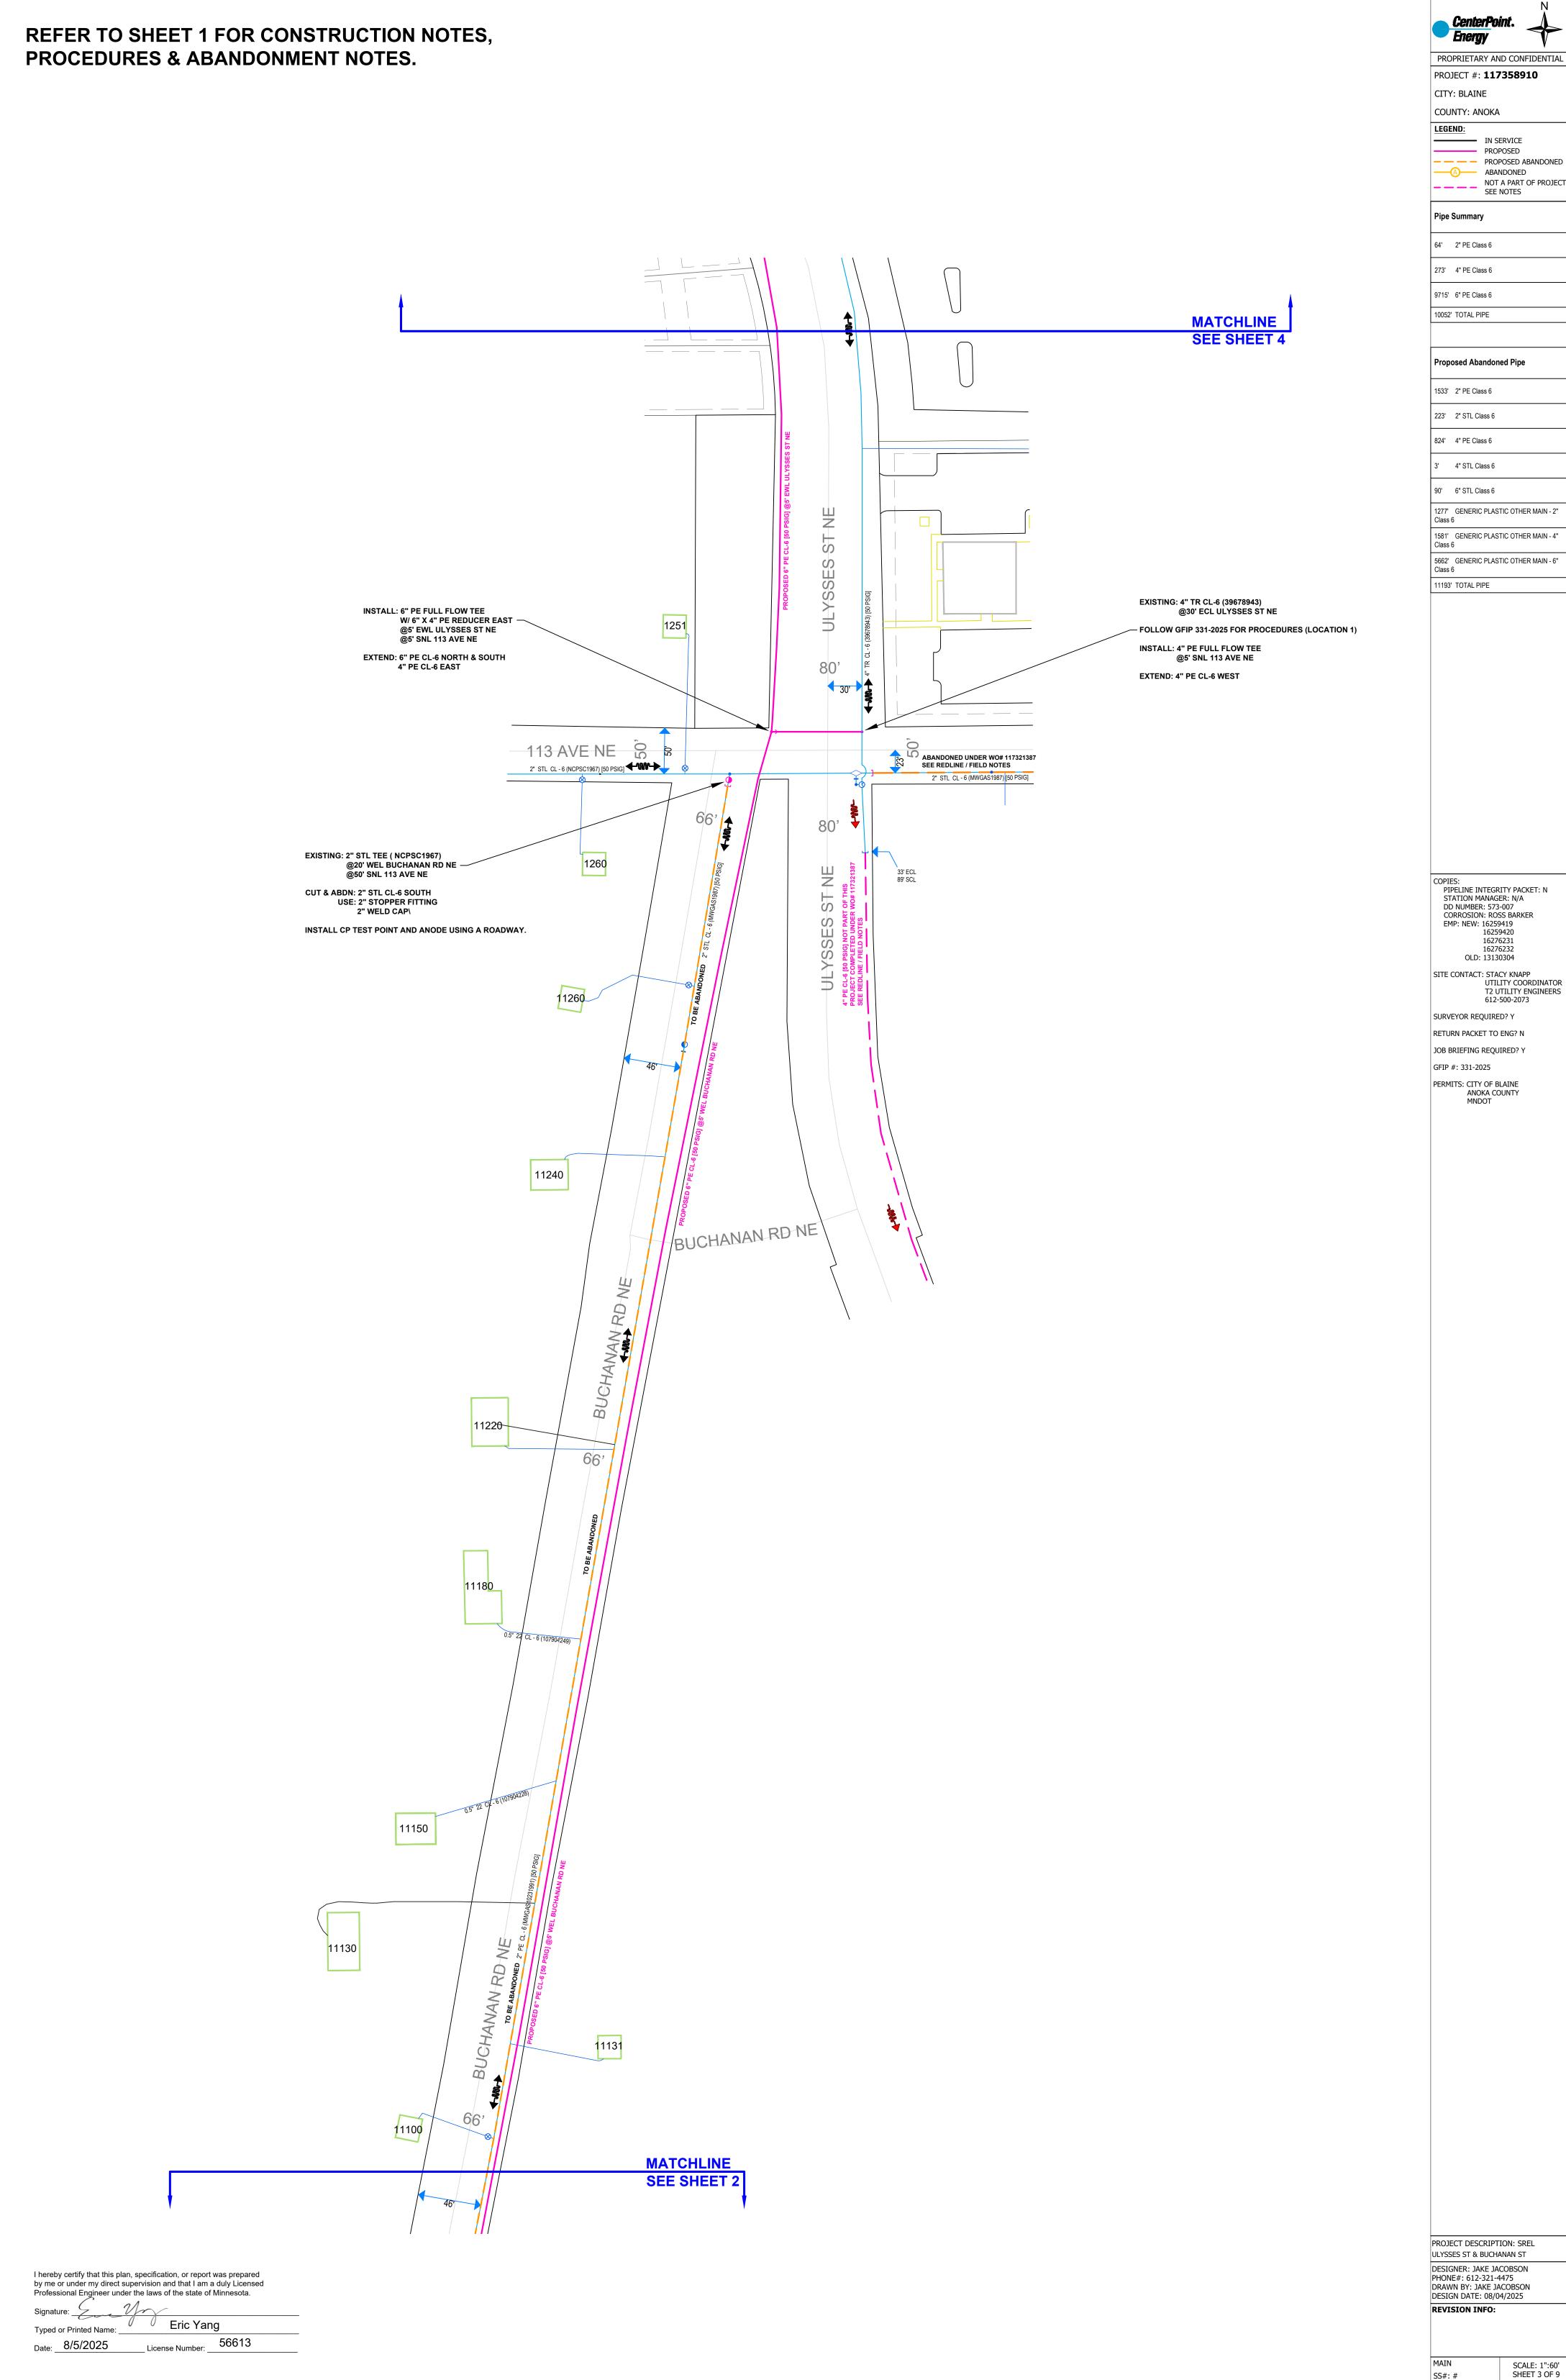

PROPRIETARY AND CONFIDENTIAL PROJECT #: **117358910** 

NOT A PART OF PROJECT SEE NOTES

5662' GENERIC PLASTIC OTHER MAIN - 6" Class 6

T2 UTILITY ENGINEERS

SCALE: 1":60' SHEET 3 OF 9

I hereby certify that this plan, specification, or report was prepared by me or under my direct supervision and that I am a duly Licensed Professional Engineer under the laws of the state of Minnesota.

\_ License Number: \_\_\_56613

Date: 8/5/2025

REFER TO SHEET 1 FOR CONSTRUCTION NOTES, PROCEDURES & ABANDONMENT NOTES.

MATCHLINE **SEE SHEET 5** 80' 岁 S ULYSSES EXISTING: 2" PE CL-6 (91463714) @19' SCL 115 CIR NE - INSTALL: 2" X 2" HVPT @6' EWL ULYSSES ST NE 2" PE 90 DEG ELL 6" X 2" HVPT @5' EWL ULYSSES ST NE @20' SCL 115 CIR NE EXTEND: 6" PE CL-6 NORTH & SOUTH MATCHLINE

PROPOSED ABANDONED
ABANDONED
NOT A PART OF PROJECT
SEE NOTES

Pipe Summary

9715' 6" PE Class 6

10052' TOTAL PIPE

64' 2" PE Class 6

273' 4" PE Class 6

Proposed Abandoned Pipe

1533' 2" PE Class 6

223' 2" STL Class 6

824' 4" PE Class 6

3' 4" STL Class 6

90' 6" STL Class 6

1277' GENERIC PLASTIC OTHER MAIN - 2" Class 6

5662' GENERIC PLASTIC OTHER MAIN - 6" Class 6

1581' GENERIC PLASTIC OTHER MAIN - 4"

Class 6
11193' TOTAL PIPE

COPIES:
PIPELINE INTEGRITY PACKET: N
STATION MANAGER: N/A
DD NUMBER: 573-007
CORROSION: ROSS BARKER
EMP: NEW: 16259419
16259420
16276231
16276232
OI D: 13130304

16276232
OLD: 13130304

SITE CONTACT: STACY KNAPP
UTILITY COORDINATOR
T2 UTILITY ENGINEERS
612-500-2073

SURVEYOR REQUIRED? Y
RETURN PACKET TO ENG? N

RETURN PACKET TO ENG? N

JOB BRIEFING REQUIRED? Y

GFIP #: 331-2025

PERMITS: CITY OF BLAINE ANOKA COUNTY MNDOT


PROJECT DESCRIPTION: SREL ULYSSES ST & BUCHANAN ST

DESIGNER: JAKE JACOBSON PHONE#: 612-321-4475
DRAWN BY: JAKE JACOBSON DESIGN DATE: 08/04/2025

REVISION INFO:

**SEE SHEET 3** 

SCALE: 1":60' S#: # SHEET 4 OF 9

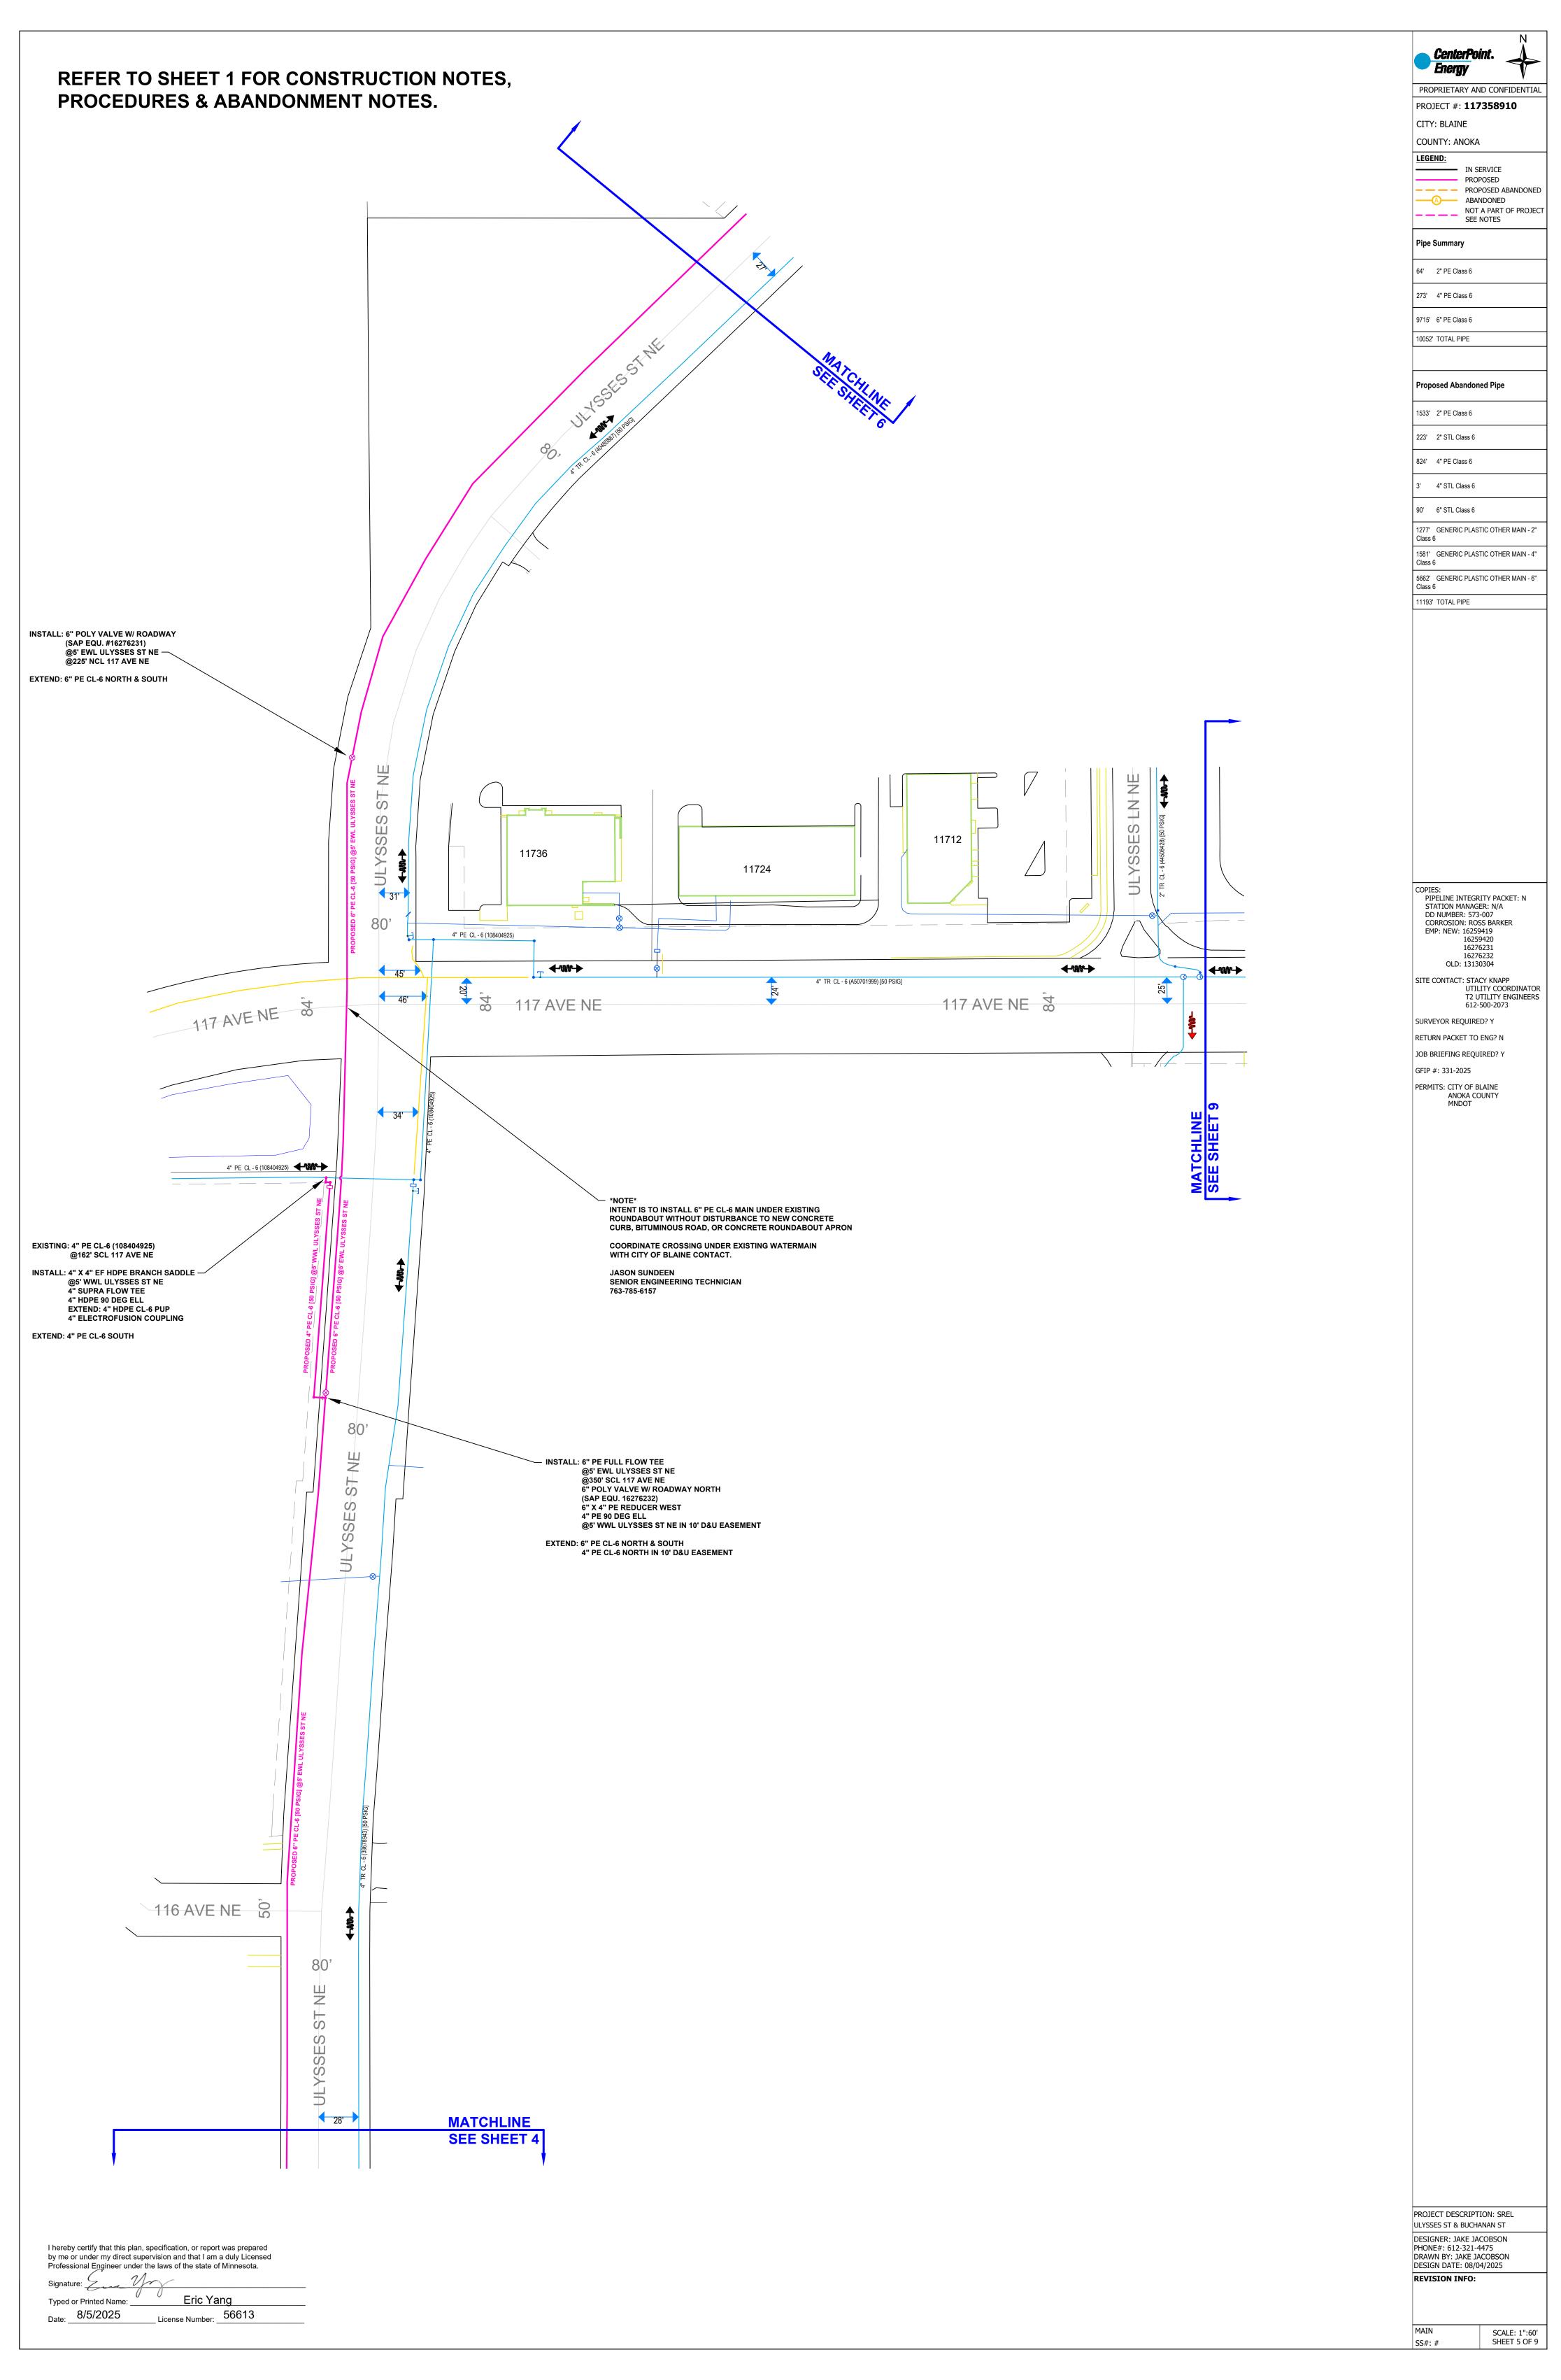


I hereby certify that this plan, specification, or report was prepared by me or under my direct supervision and that I am a duly Licensed Professional Engineer under the laws of the state of Minnesota.

Eric Yang

\_ License Number: \_\_\_\_56613

REFER TO SHEET 1 FOR CONSTRUCTION NOTES, PROCEDURES & ABANDONMENT NOTES.

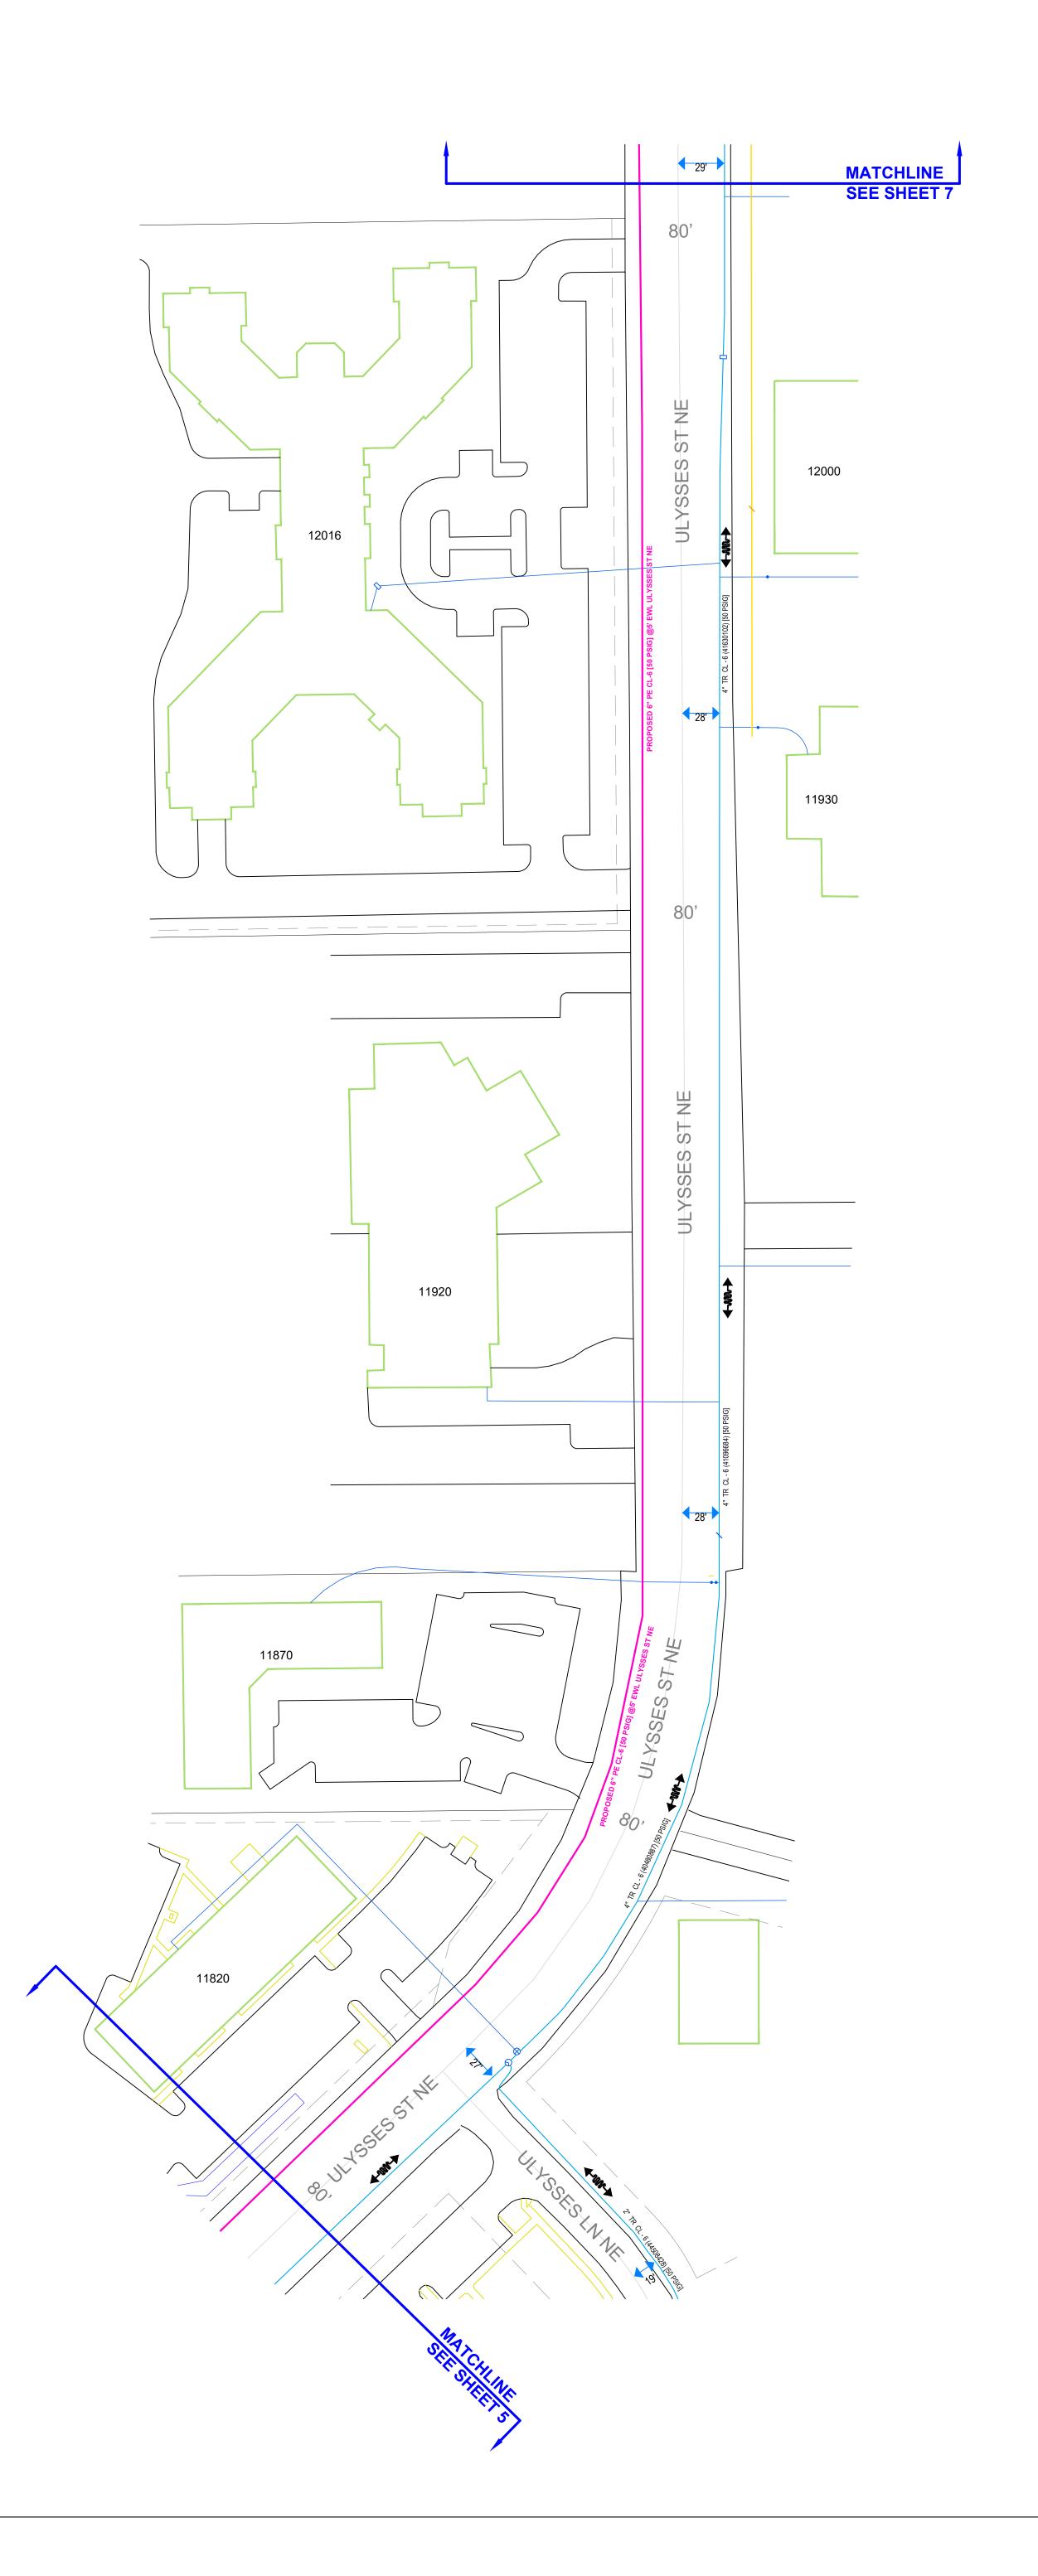

PROPRIETARY AND CONFIDENTIAL
PROJECT #: 117358910
CITY: BLAINE
COUNTY: ANOKA

LEGEND:
PROPOSED
PROPOSED
PROPOSED ABANDONED
ABANDONED
NOT A PART OF PROJECT
SEE NOTES

NOT A PART OF PROSEE NOTES

Pipe Summary

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Class 6 11193' TOTAL PIPE

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UTILITY COORDINATOR

T2 UTILITY ENGINEERS
612-500-2073

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RETURN PACKET TO ENG? N

JOB BRIEFING REQUIRED? Y

GFIP #: 331-2025

PERMITS: CITY OF BLAINE

PERMITS: CITY OF BLAINE ANOKA COUNTY MNDOT

PROJECT DESCRIPTION: SREL
ULYSSES ST & BUCHANAN ST

DESIGNER: JAKE JACOBSON PHONE#: 612-321-4475 DRAWN BY: JAKE JACOBSON DESIGN DATE: 08/04/2025 REVISION INFO:

> SCALE: 1":60' SHEET 6 OF 9

REFER TO SHEET 1 FOR CONSTRUCTION NOTES, PROCEDURES & ABANDONMENT NOTES. 1533' 2" PE Class 6 EXISTING: 4" TR CL-6 MAIN (41630102) @29' ECL ULYSSES ST NE FOLLOW GFIP 331-2025 FOR PROCEDURES (LOCATION 2) INSTALL: 4" PE FULL FLOW TEE @3' NSL PAUL PKWY NE 4" PE 90 DEG ELL 6" X 4" PE REDUCER 6" PE FULL FLOW TEE @5' NSL PAUL PKWY NE 6" POLY VALVE IN ROADWAY EAST (SAP EQU. # 16259419) 250' EXTEND: 6" PE CL-6 EAST & WEST 65 (CENTRAL 12120 80, 4" TR CL - 6 (42557320) [50 PSIG] 121 AVE NE 43 121 AVE NE 80' EXISTING: 4" TR CL-6 MAIN (42557320) @43' ECL ABERDEEN ST NE INSTALL: 6" PE 90 DEG ELL PROPOSED 6" PE CL-6 [50 PSIG] @5' NSL PAUL PKWY NE PROPOSED 6" PE CL-6 [50 PSIG] @95' SNL PAUL PKWY NE @5' NSL PAUL PKWY NE \*NOTE\* EXISTING 4" PE CL-6 IS DIRECTLY ABOVE @5' EWL ULYSSES ST NE — EXISTING 6" STL CL-E WITH 1' VERTICAL SEPARATION \*CAUTION\* 6" STL CL-E PROTECT AT ALL TIMES EXTEND: 6" PE CL-6 SOUTH & EAST SEE WATCHDOG NOTE ULYSSES ST NE - FOLLOW GFIP 331-2025 FOR PROCEDURES (LOCATION 3) INSTALL: 4" PE FULL FLOW TEE @95' SNL PAUL PKWY NE 6" X 4" PE REDUCER **6" POLY VALVE IN ROADWAY** (SAP EQU. # 16259420) EXTEND: 6" PE CL-6 WEST 1390 12054 65 (CENTI 12058 12074 12062 12070 12066 12078 12082 12068 12052 1.25" TR CL - 6 (NCPSC1976) [50 PSIG] 29' 250' MATCHLINE **SEE SHEET 6** I hereby certify that this plan, specification, or report was prepared by me or under my direct supervision and that I am a duly Licensed Professional Engineer under the laws of the state of Minnesota. U Eric Yang Date: 8/5/2025 \_\_ License Number: \_\_\_56613

CenterPoint.

PROPRIETARY AND CONFIDENTIAL

PROJECT #: **117358910** 

CITY: BLAINE COUNTY: ANOKA

IN SERVICE

PROPOSED PROPOSED ABANDONED ABANDONED NOT A PART OF PROJECT SEE NOTES

Pipe Summary

64' 2" PE Class 6

273' 4" PE Class 6

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10052' TOTAL PIPE

**Proposed Abandoned Pipe** 

223' 2" STL Class 6

824' 4" PE Class 6

4" STL Class 6

90' 6" STL Class 6

1277' GENERIC PLASTIC OTHER MAIN - 2

1581' GENERIC PLASTIC OTHER MAIN - 4'

5662' GENERIC PLASTIC OTHER MAIN - 6"

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OLD: 13130304 SITE CONTACT: STACY KNAPP

UTILITY COORDINATOR

T2 UTILITY ENGINEERS

612-500-2073

SURVEYOR REQUIRED? Y

RETURN PACKET TO ENG? N JOB BRIEFING REQUIRED? Y

GFIP #: 331-2025 PERMITS: CITY OF BLAINE ANOKA COUNTY MNDOT

PROJECT DESCRIPTION: SREL ULYSSES ST & BUCHANAN ST DESIGNER: JAKE JACOBSON PHONE#: 612-321-4475 DRAWN BY: JAKE JACOBSON DESIGN DATE: 08/04/2025 **REVISION INFO:** 

SCALE: 1":60' SS#: # SHEET 7 OF 9

# REFER TO SHEET 1 FOR CONSTRUCTION NOTES, PROCEDURES & ABANDONMENT NOTES.



CenterPoint. The Energy

PROPRIETARY AND CONFIDENTIAL

PROJECT #: **117358910**CITY: BLAINE

COUNTY: ANOKA

IN SERVICE
PROPOSED
PROPOSED ABANDONED
ABANDONED
NOT A PART OF PROJECT
SEE NOTES

Pipe Summary

64' 2" PE Class 6

273' 4" PE Class 6

10052' TOTAL PIPE

9715' 6" PE Class 6

Proposed Abandoned Pipe

Proposed Abandoned Pipe

1533' 2" PE Class 6

223' 2" STL Class 6

824' 4" PE Class 6

3' 4" STL Class 6

90' 6" STL Class 6

1277' GENERIC PLASTIC OTHER MAIN - 2' Class 6

1581' GENERIC PLASTIC OTHER MAIN - 4"

5662' GENERIC PLASTIC OTHER MAIN - 6" Class 6

Class 6

11193° TOTAL PIPE

COPIES:
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16259420
16276231

OLD: 13130304

SITE CONTACT: STACY KNAPP

UTILITY COORDINATOR

T2 UTILITY ENGINEERS

612-500-2073

SURVEYOR REQUIRED? Y
RETURN PACKET TO ENG? N
JOB BRIEFING REQUIRED? Y

GFIP #: 331-2025

PERMITS: CITY OF BLAINE
ANOKA COUNTY
MNDOT

PROJECT DESCRIPTION: SREL ULYSSES ST & BUCHANAN ST

DESIGNER: JAKE JACOBSON PHONE#: 612-321-4475
DRAWN BY: JAKE JACOBSON DESIGN DATE: 08/04/2025

REVISION INFO:


MAIN SCALE: 1":60' SS#: # SHEET 8 OF 9

I hereby certify that this plan, specification, or report was prepared by me or under my direct supervision and that I am a duly Licensed Professional Engineer under the laws of the state of Minnesota.

Signature:

Typed or Printed Name: Eric Yang

Date: 8/5/2025 License Number: \_\_\_56613

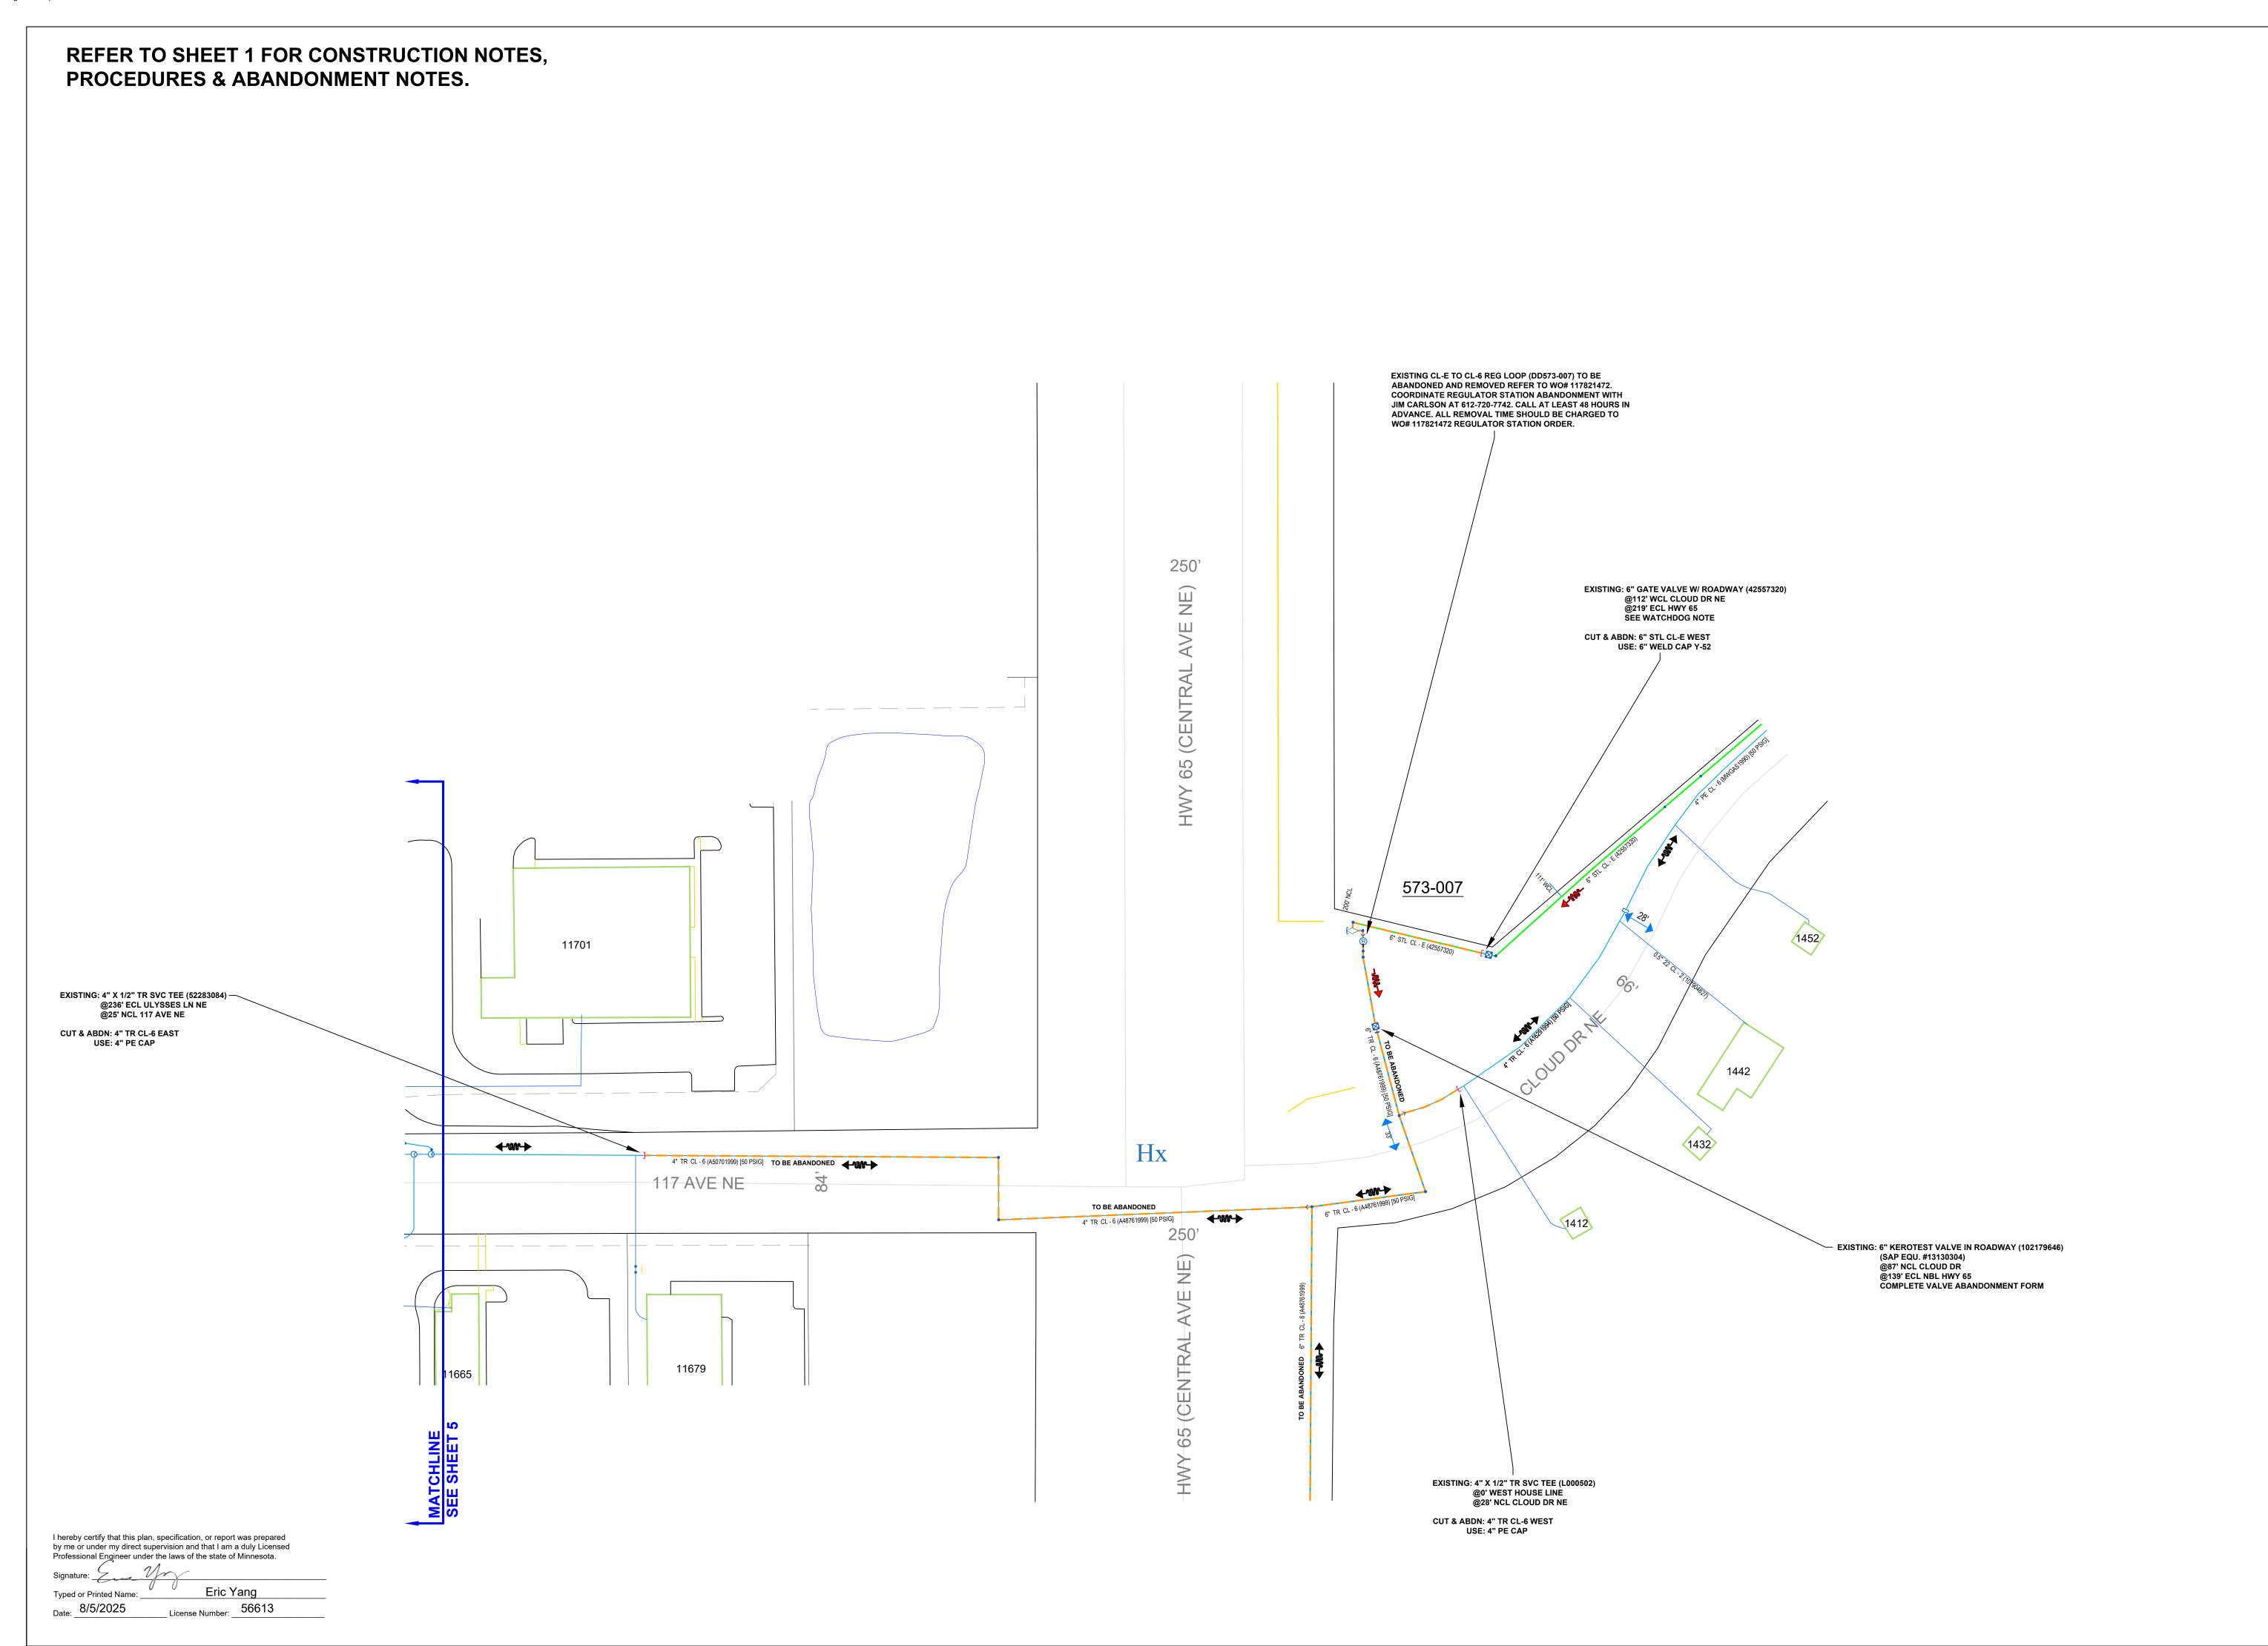



PROPRIETARY AND CONFIDENTIAL

PROJECT #: **117358910** 

CITY: BLAINE
COUNTY: ANOKA

LEGEND:

IN SERVICE
PROPOSED
PROPOSED ABANDONED
ABANDONED

NOT A PART OF PROJECT SEE NOTES

Pipe Summary

64' 2" PE Class 6

273' 4" PE Class 6

9715' 6" PE Class 6

10052' TOTAL PIPE

Proposed Abandoned Pipe

1533' 2" PE Class 6

223' 2" STL Class 6

824' 4" PE Class 6

4" STL Class 6

90' 6" STL Class 6

1277' GENERIC PLASTIC OTHER MAIN - 2"

1581' GENERIC PLASTIC OTHER MAIN - 4"

lass 6

5662' GENERIC PLASTIC OTHER MAIN - 6" Class 6

1193' TOTAL PIPE

COPIES:
PIPELINE INTEGRITY PACKET: N
STATION MANAGER: N/A
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CORROSION: ROSS BARKER
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16259420
16276231

OLD: 13130304

SITE CONTACT: STACY KNAPP

UTILITY COORDINATOR

T2 UTILITY ENGINEERS

612-500-2073

SURVEYOR REQUIRED? Y
RETURN PACKET TO ENG? N
JOB BRIEFING REQUIRED? Y

GFIP #: 331-2025

PERMITS: CITY OF BLAINE
ANOKA COUNTY
MNDOT


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DESIGNER: JAKE JACOBSON PHONE#: 612-321-4475
DRAWN BY: JAKE JACOBSON DESIGN DATE: 08/04/2025

REVISION INFO:

MAIN SCALE: 1":60' SS#: # SHEET 9 OF 9 Docusign Envelope ID: 284AA14C-59DA-418B-9284-AF63E2CE1F49

MGC#25-80857

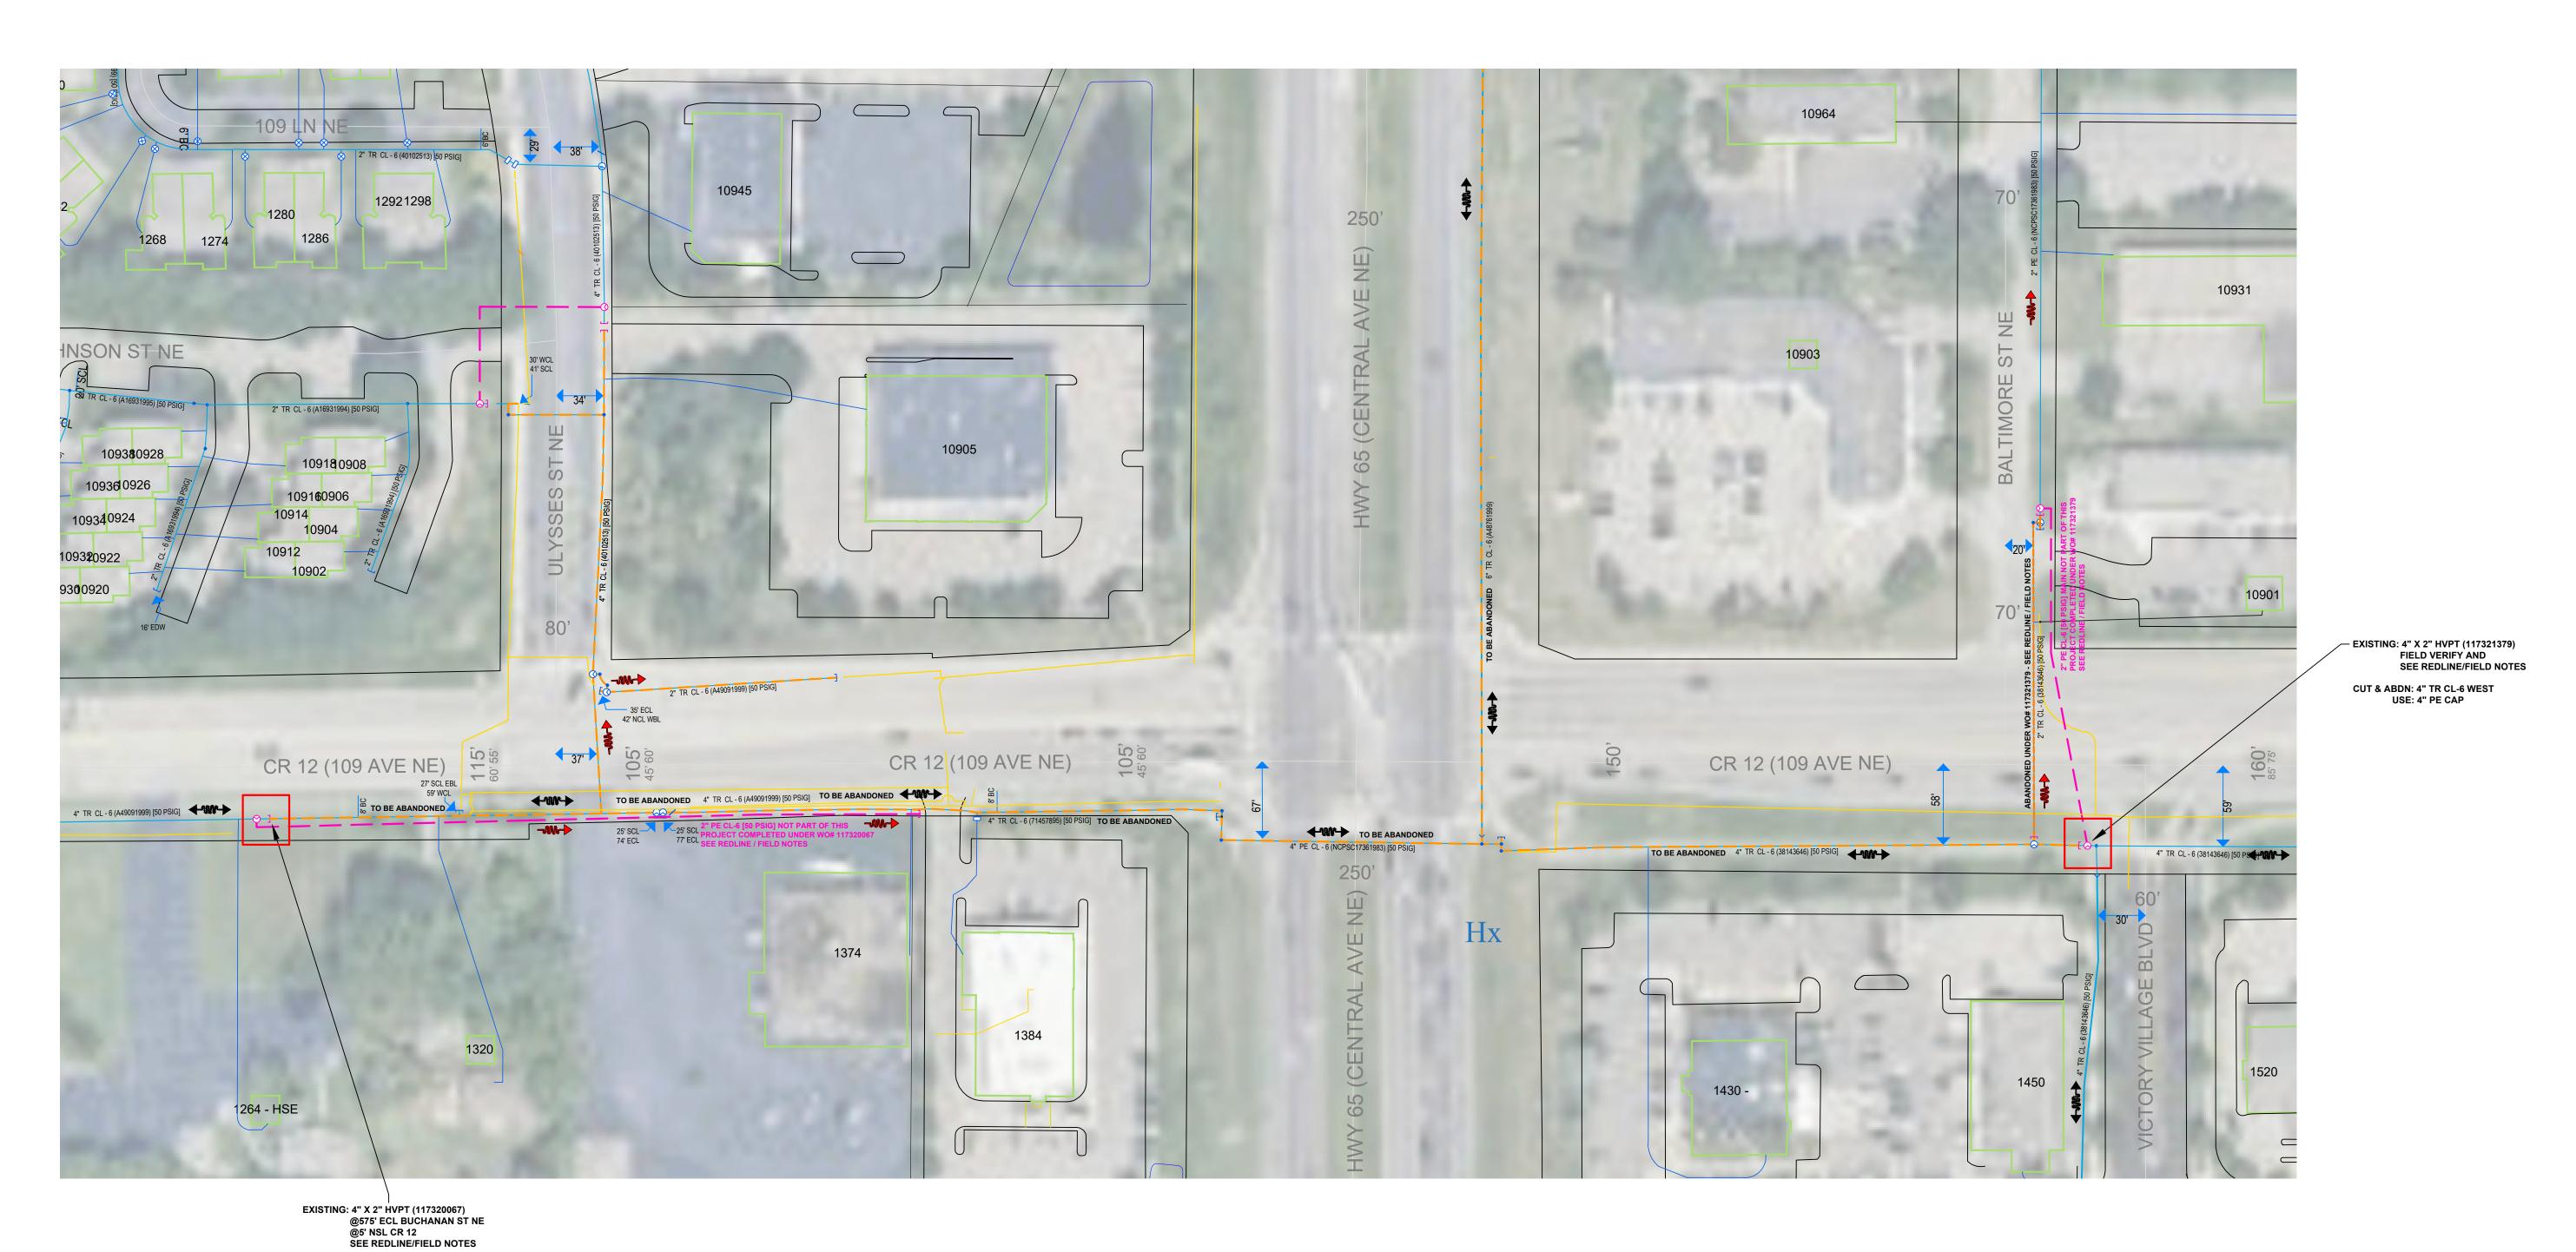

CUT & ABDN: 4" PE CL-6 EAST USE: 4" PE CAP CenterPoint. Energy

PROPRIETARY AND CONFIDENTIAL

PROJECT #: **117358910**CITY: BLAINE

COUNTY: ANOKA

LEGEND:

IN SERVICE
PROPOSED
PROPOSED ABANDONED
ABANDONED
NOT A PART OF PROJECT
SEE NOTES

Pipe Summary

64' 2" PE Class 6

273' 4" PE Class 6

10052' TOTAL PIPE

9715' 6" PE Class 6

Proposed Abandoned Pipe

opocou / wandonou / ipo

1533' 2" PE Class 6

223' 2" STL Class 6

824' 4" PE Class 6

90' 6" STL Class 6

4" STL Class 6

1277' GENERIC PLASTIC OTHER MAIN - 2" Class 6

1581' GENERIC PLASTIC OTHER MAIN - 4"

5662' GENERIC PLASTIC OTHER MAIN - 6" Class 6

Class 6

11193' TOTAL PIPE

COPIES:
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STATION MANAGER: N/A
DD NUMBER: 573-007
CORROSION: ROSS BARKER
EMP: NEW: 16259419
16259420
16276231
16276232

SITE CONTACT: STACY KNAPP

UTILITY COORDINATOR

T2 UTILITY ENGINEERS

612-500-2073

OLD: 13130304

SURVEYOR REQUIRED? Y
RETURN PACKET TO ENG? N
JOB BRIEFING REQUIRED? Y

GFIP #: 331-2025

PERMITS: CITY OF BLAINE
ANOKA COUNTY
MNDOT

ANOKA COUNTY PERMIT:


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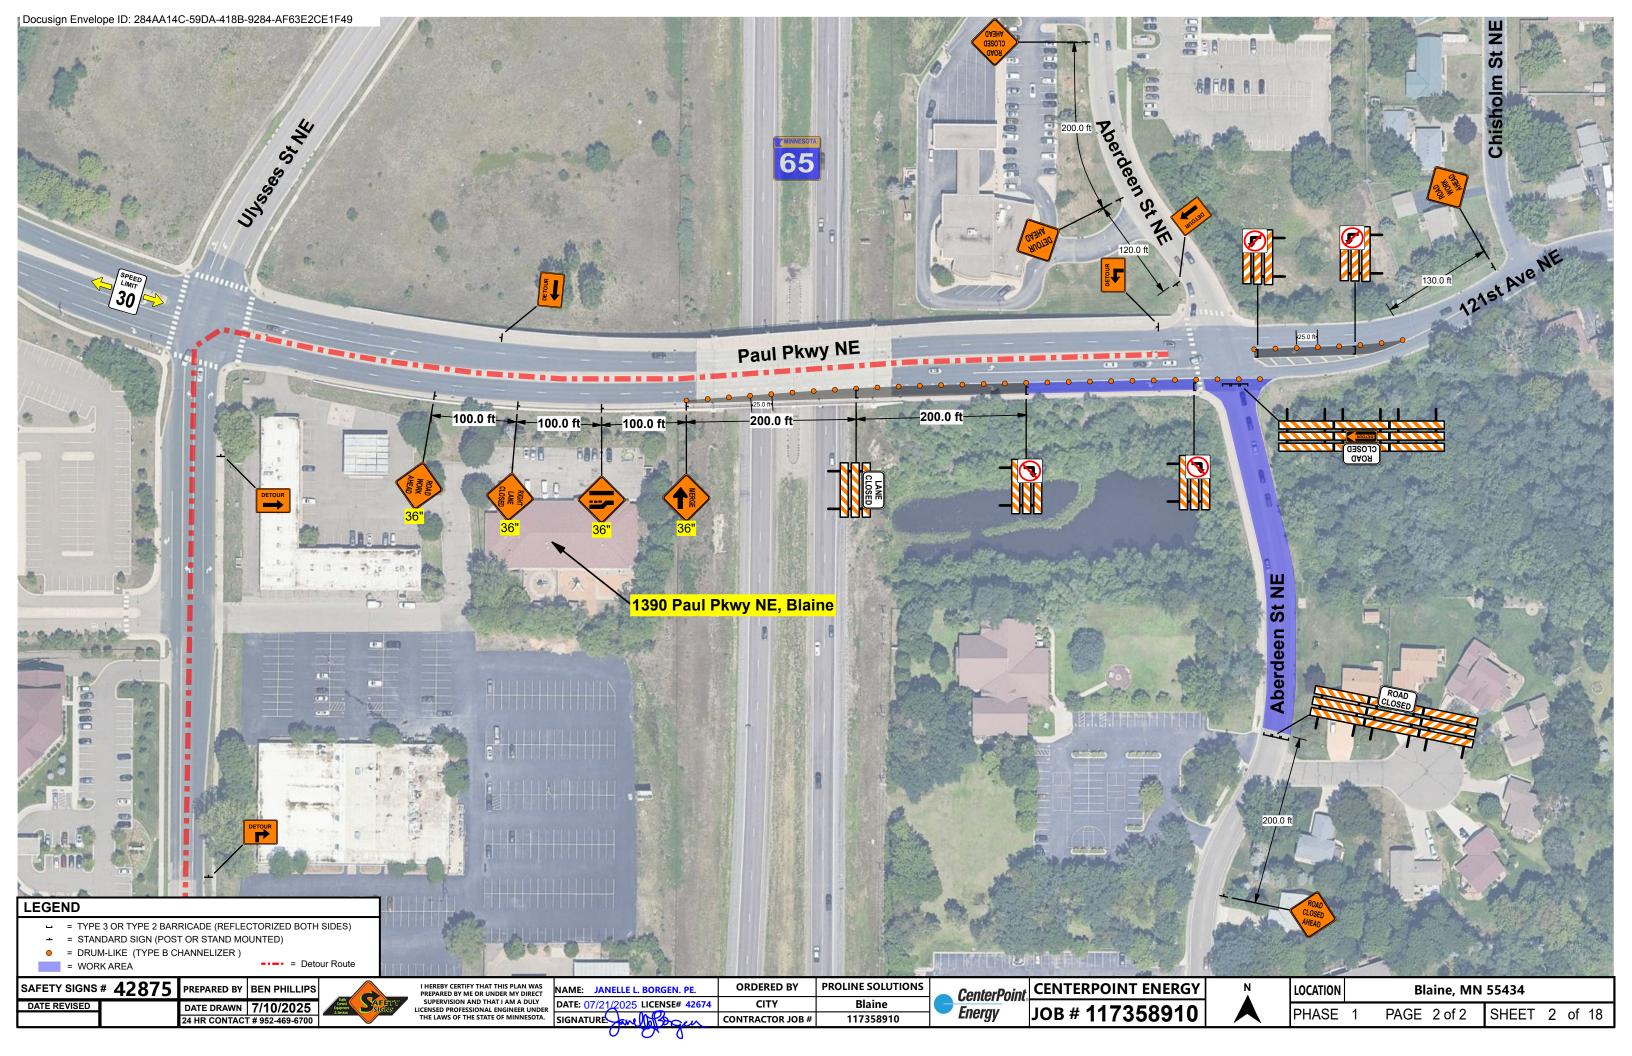
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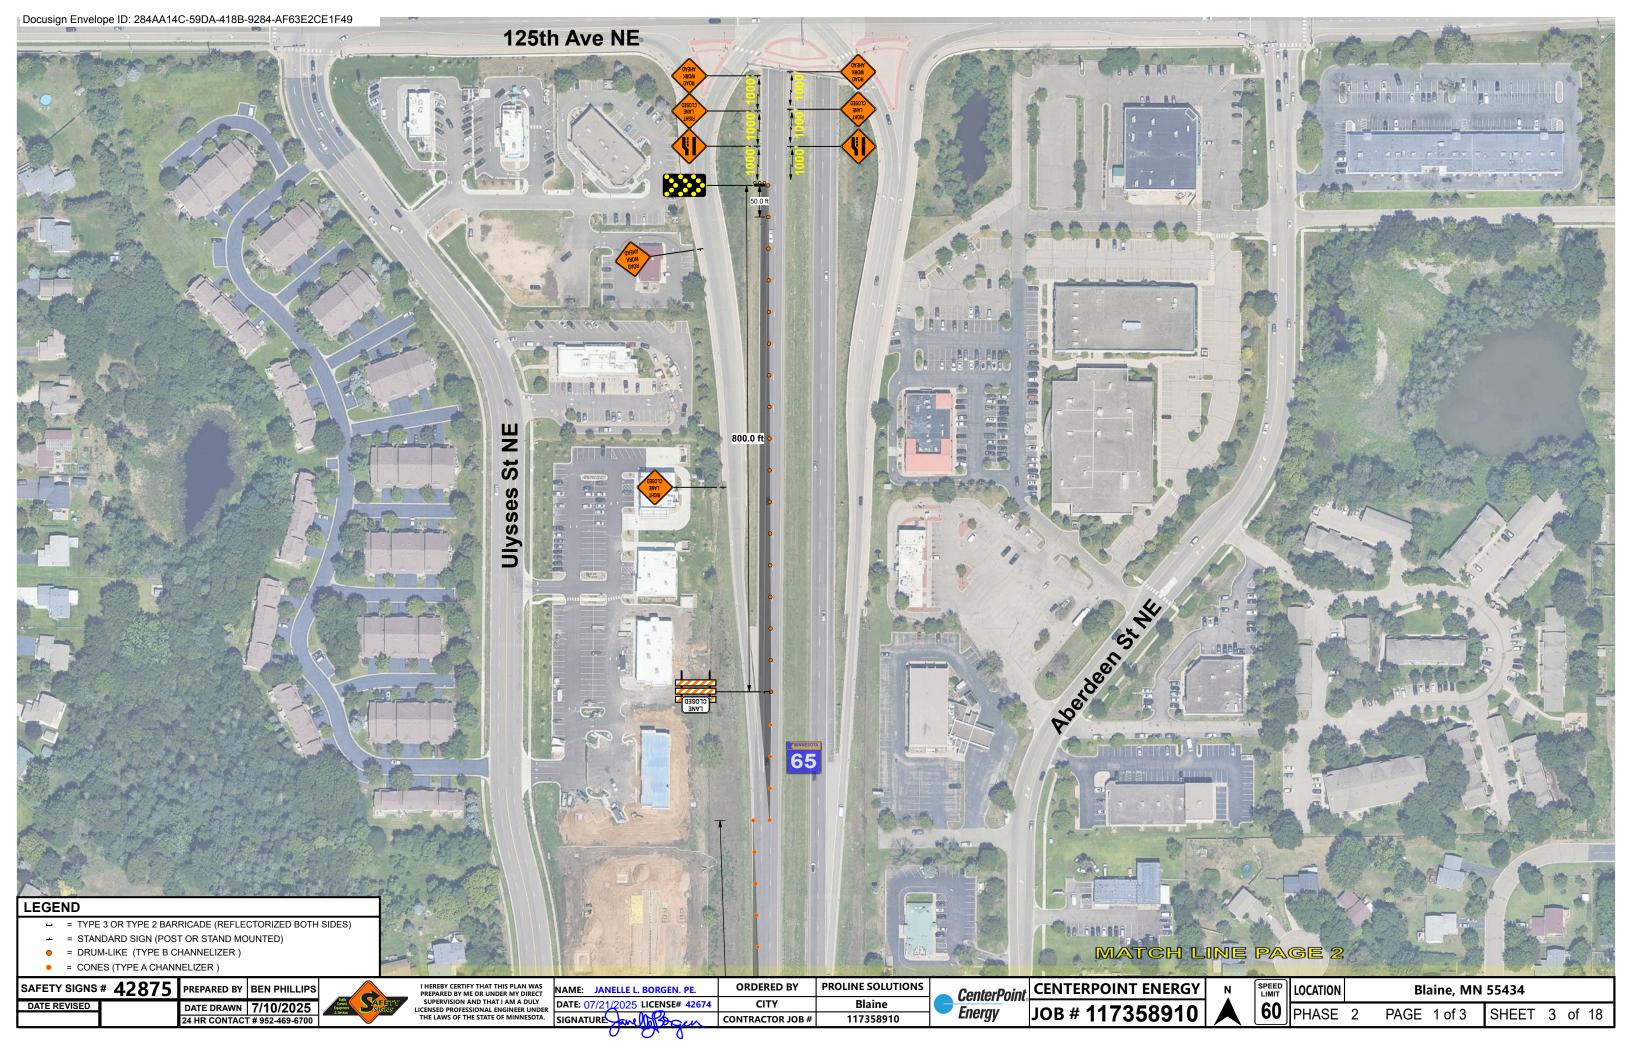
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PHONE#: 612-321-4475
DRAWN BY: JAKE JACOBSON
DESIGN DATE: 08/04/2025


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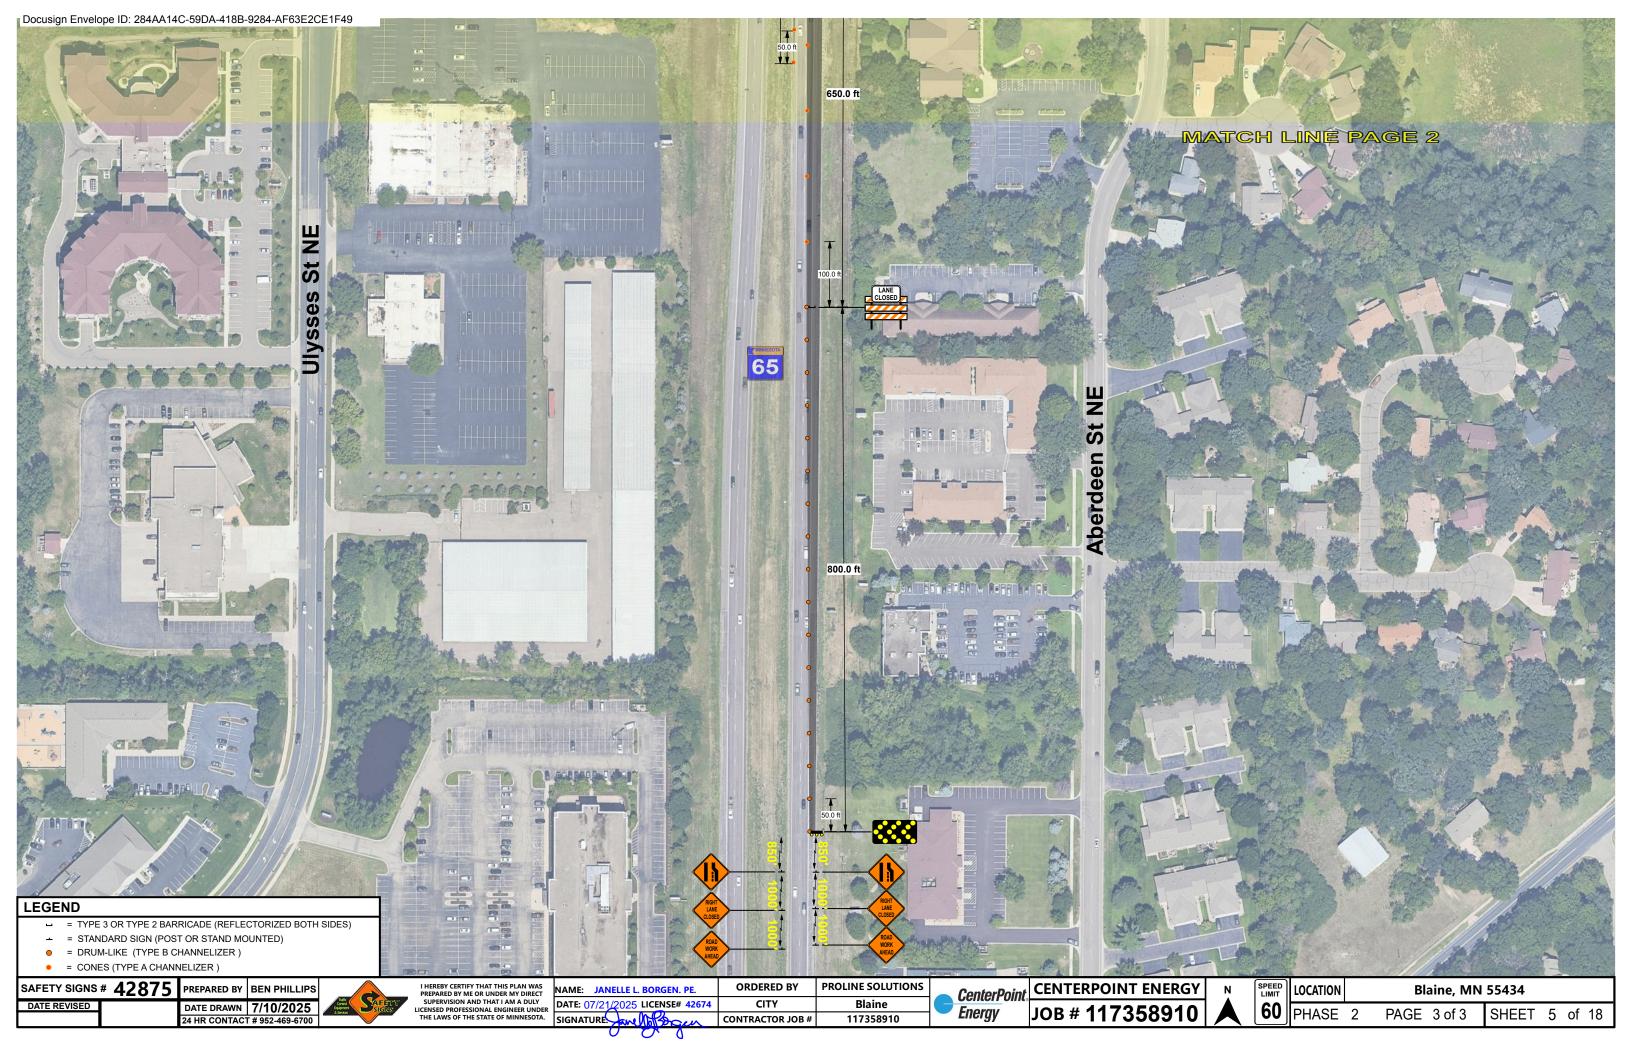
MAIN SCALE: 1":60' SS#: # SHEET 1










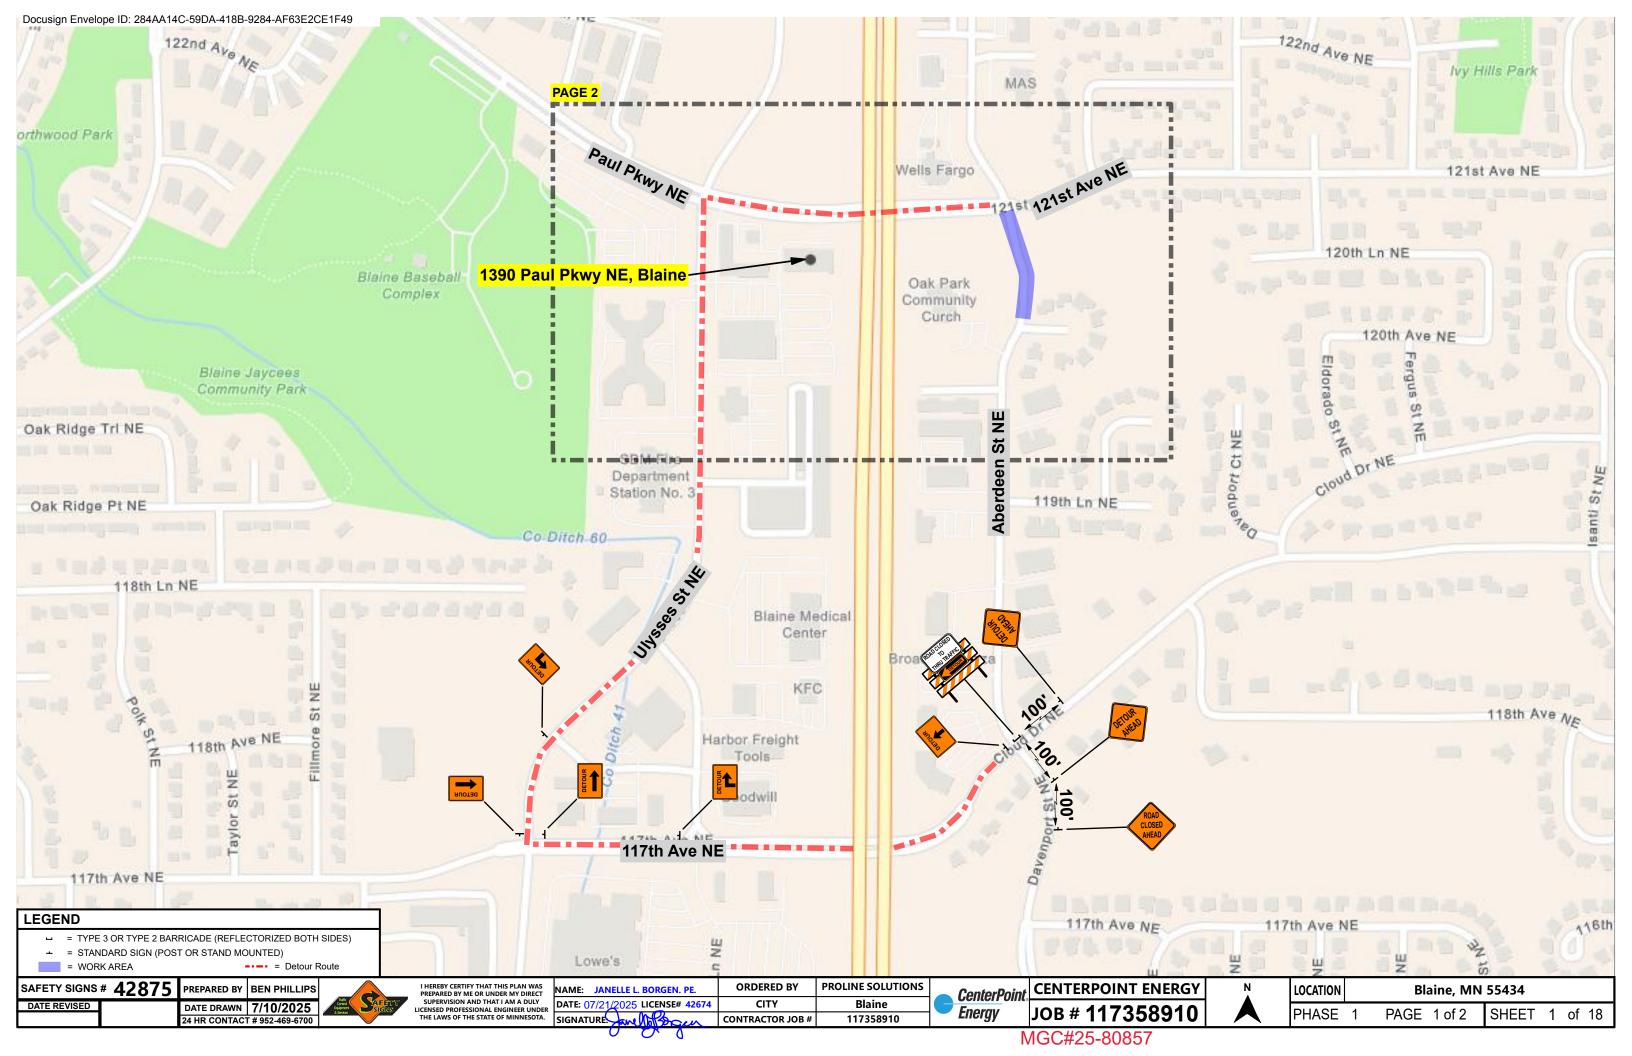


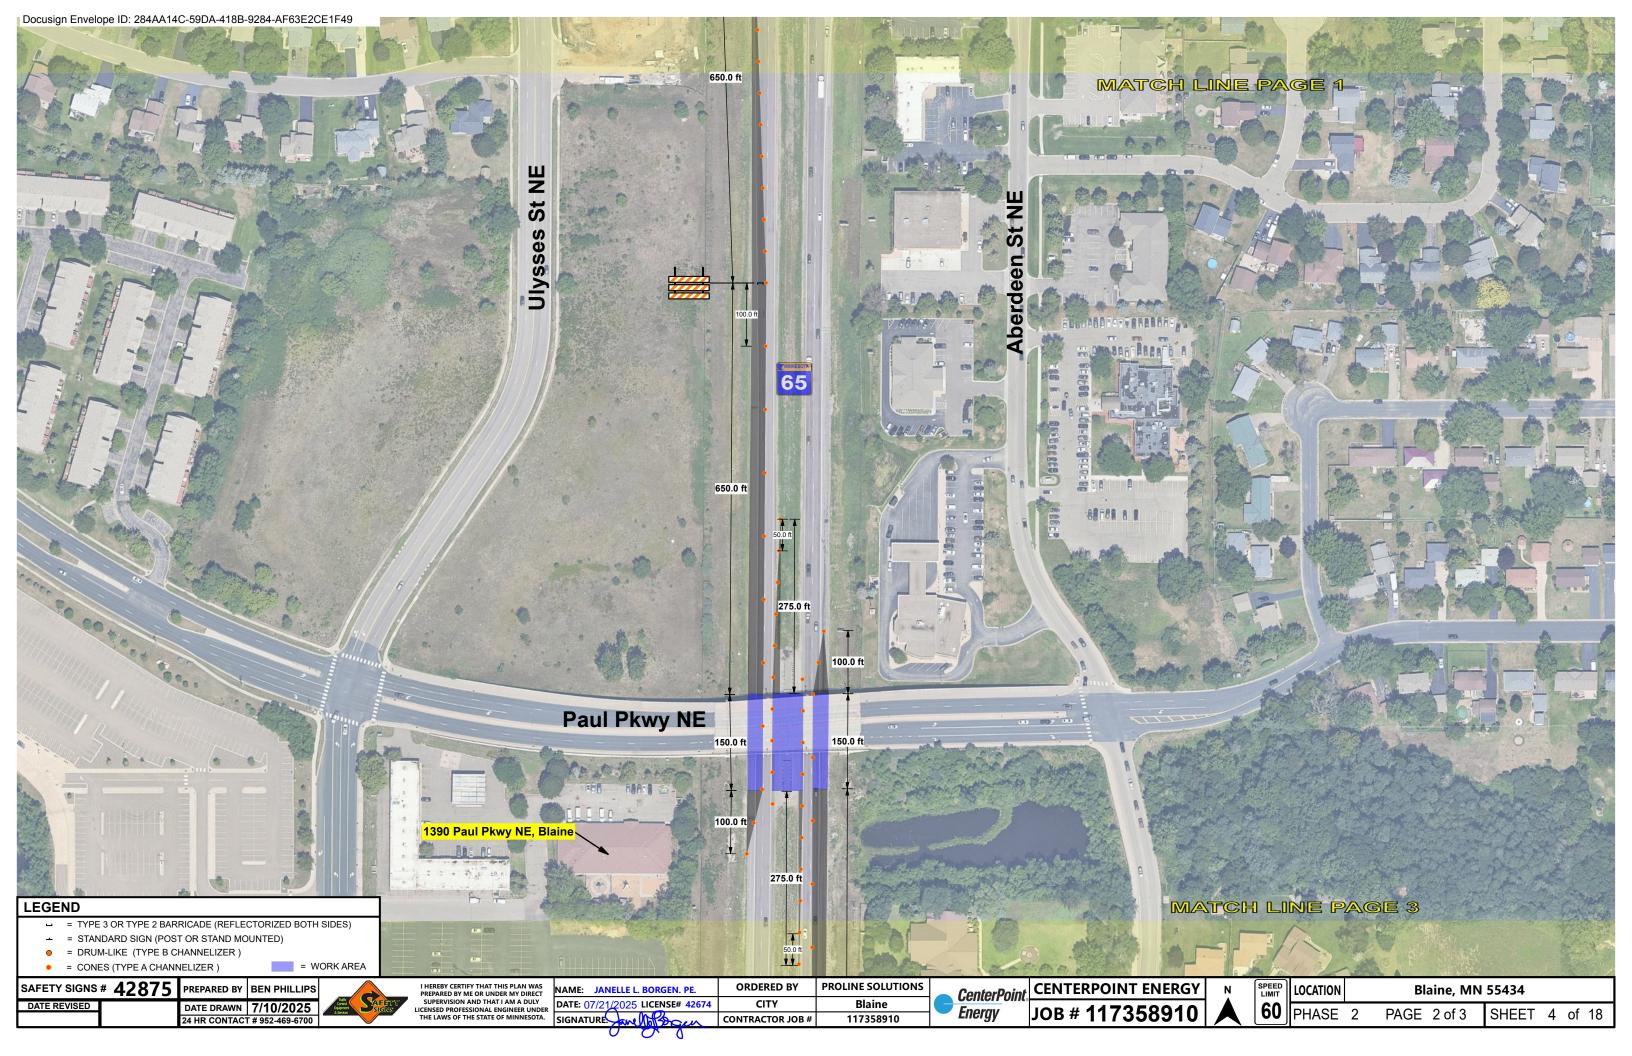


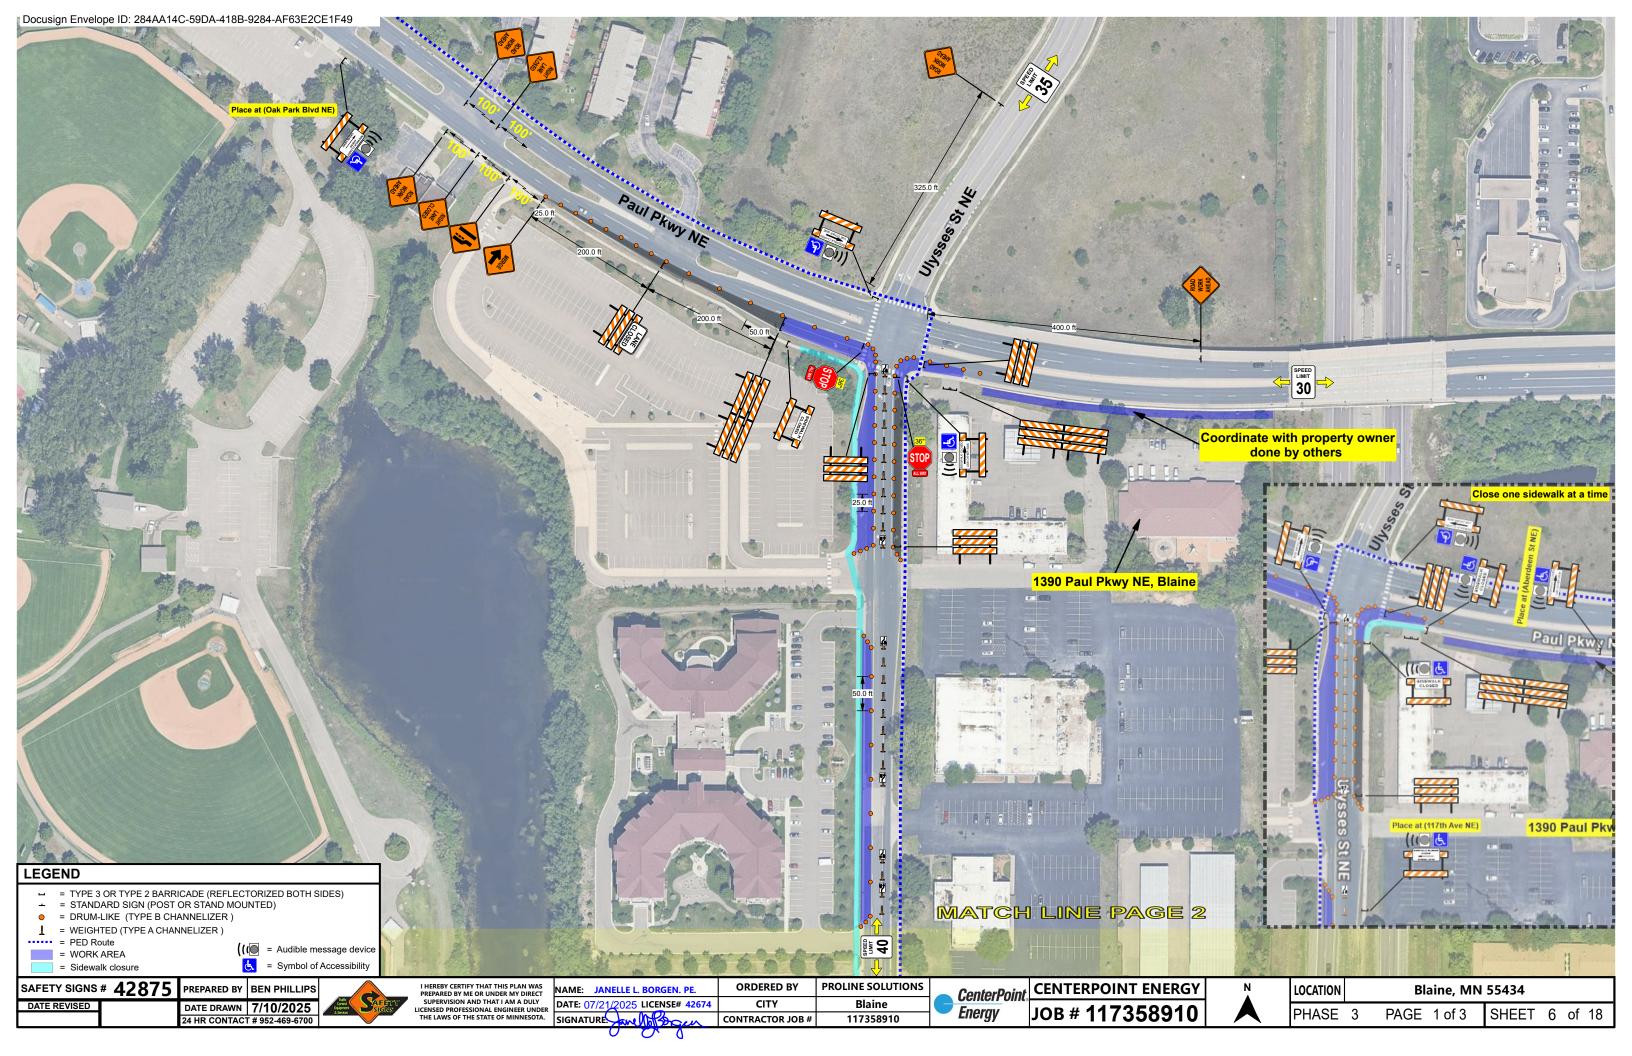


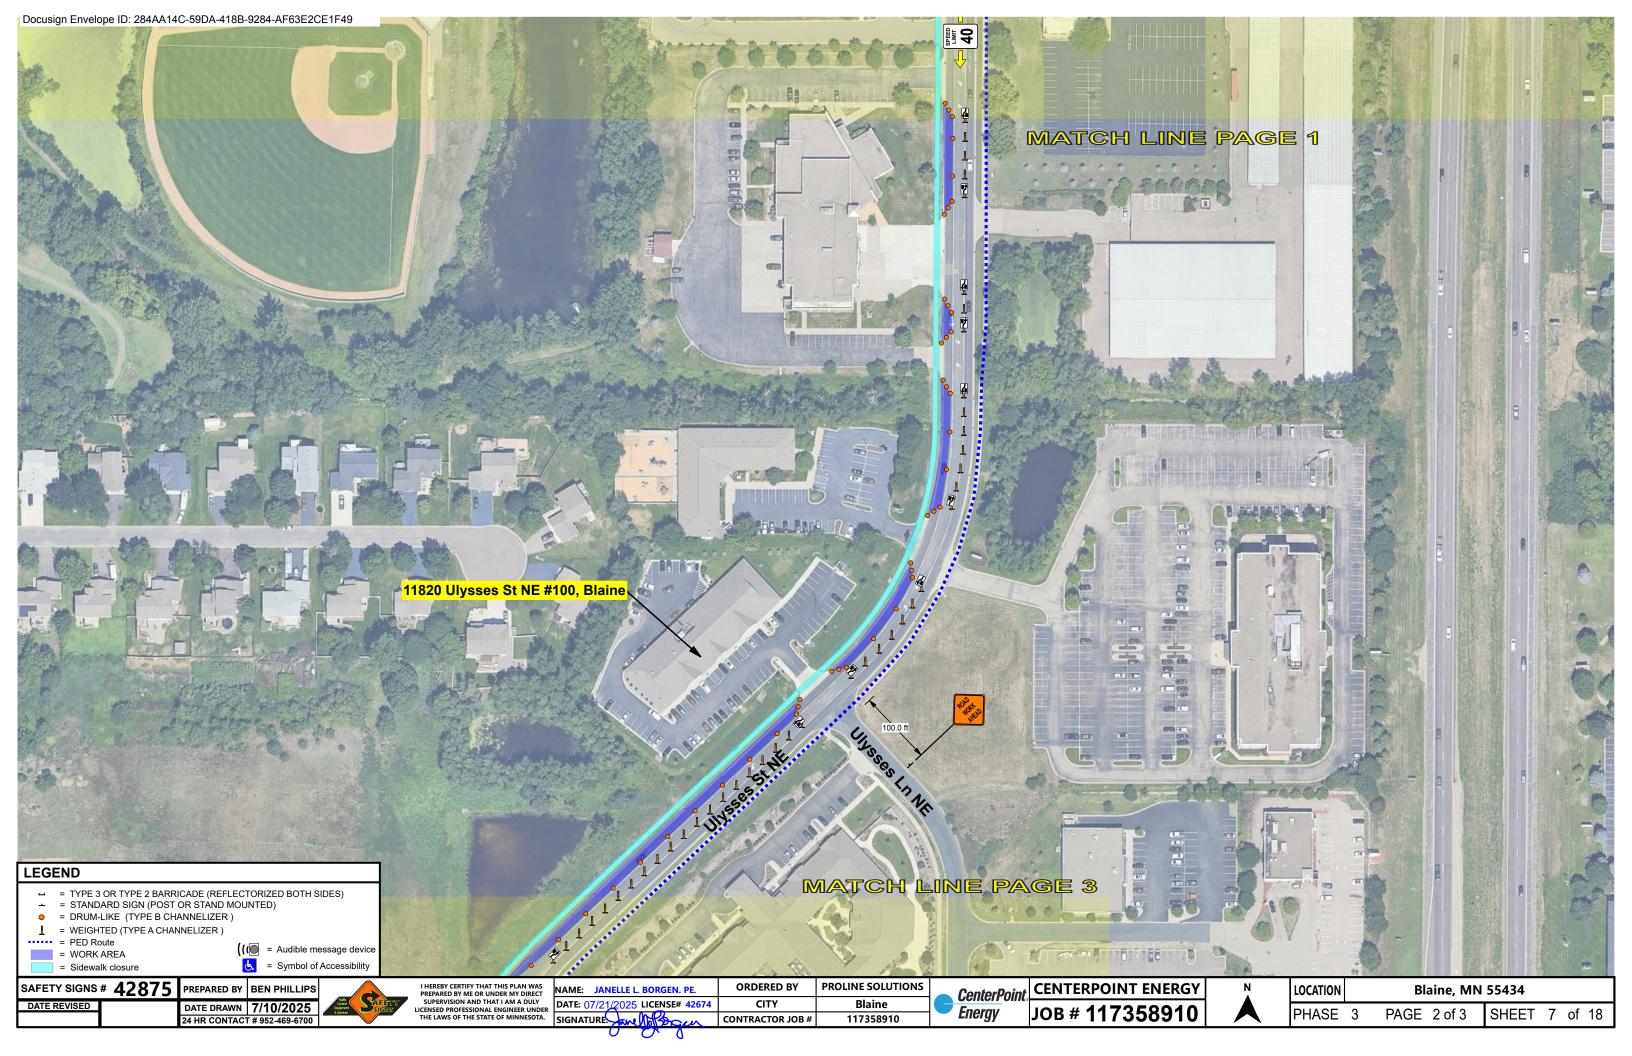


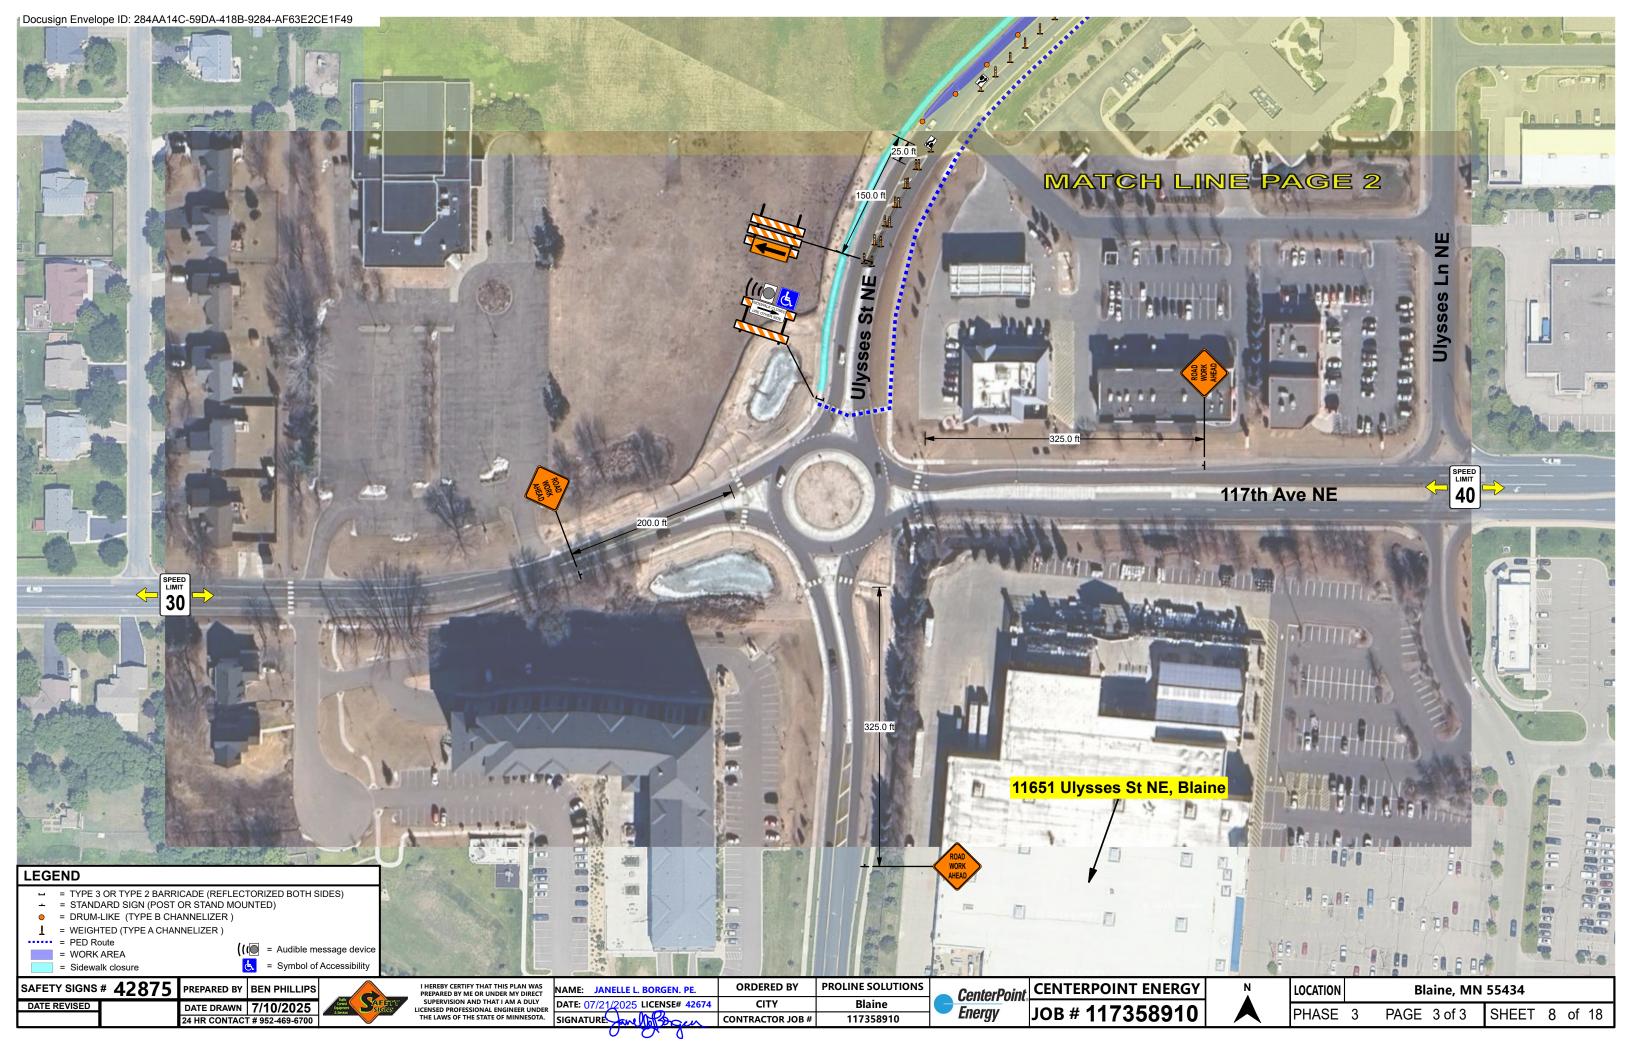


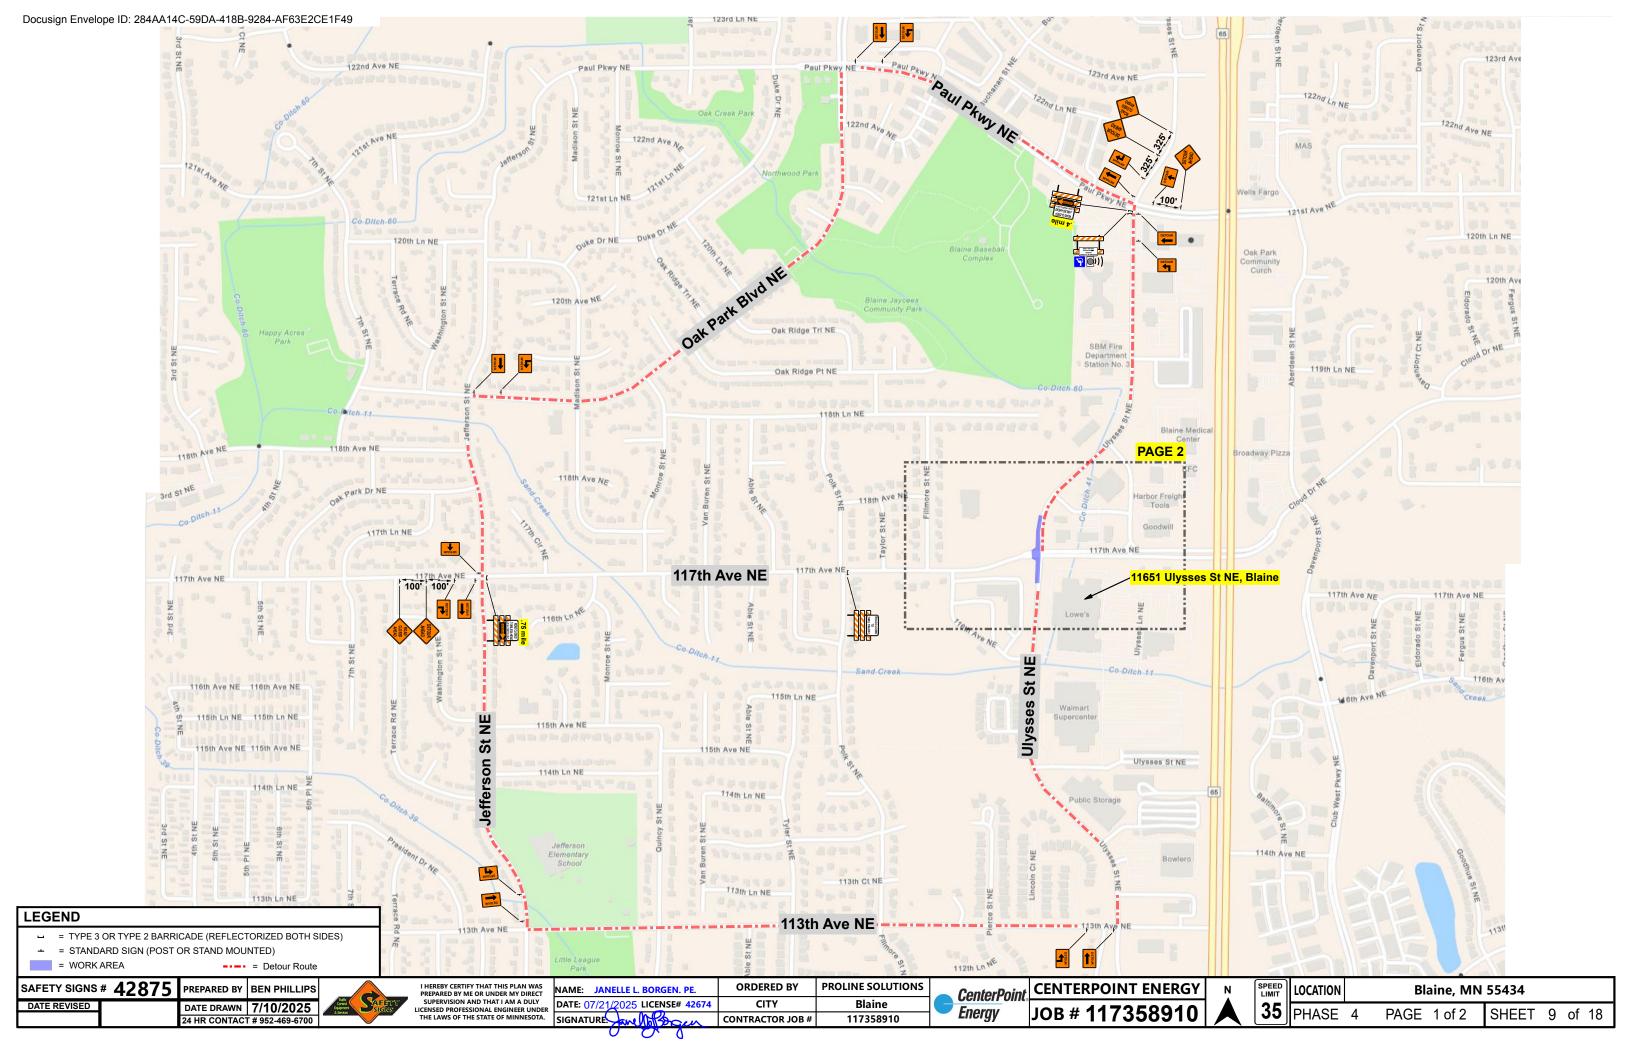


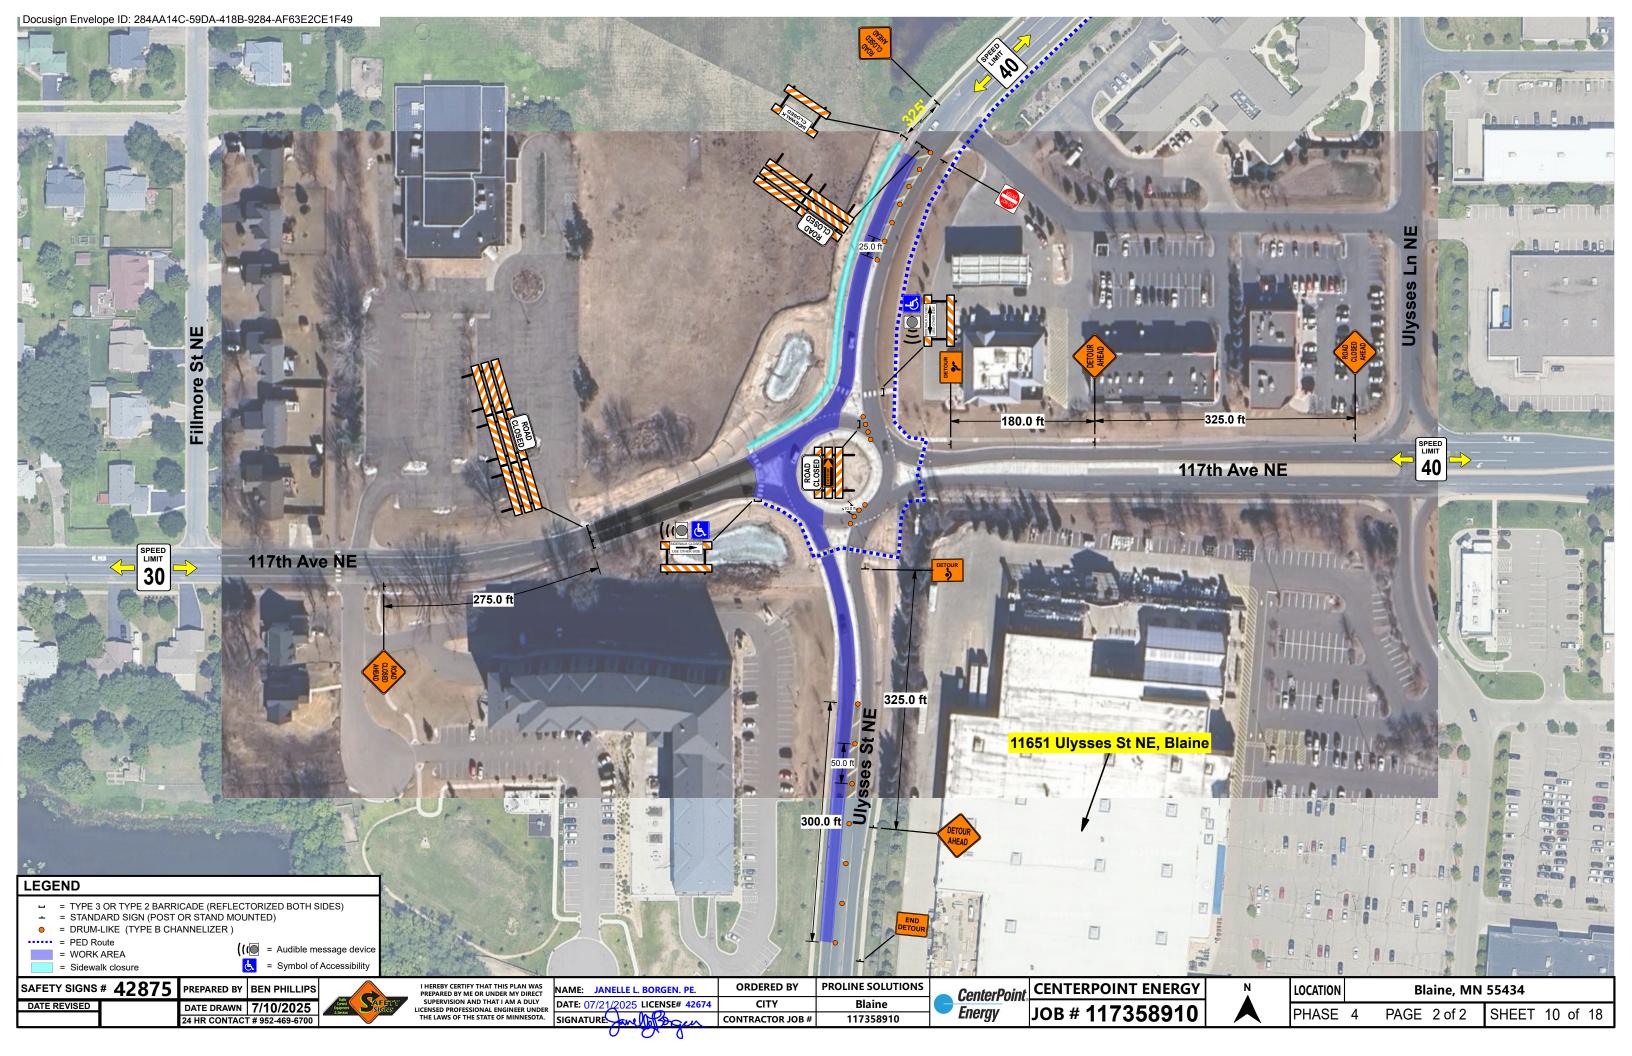


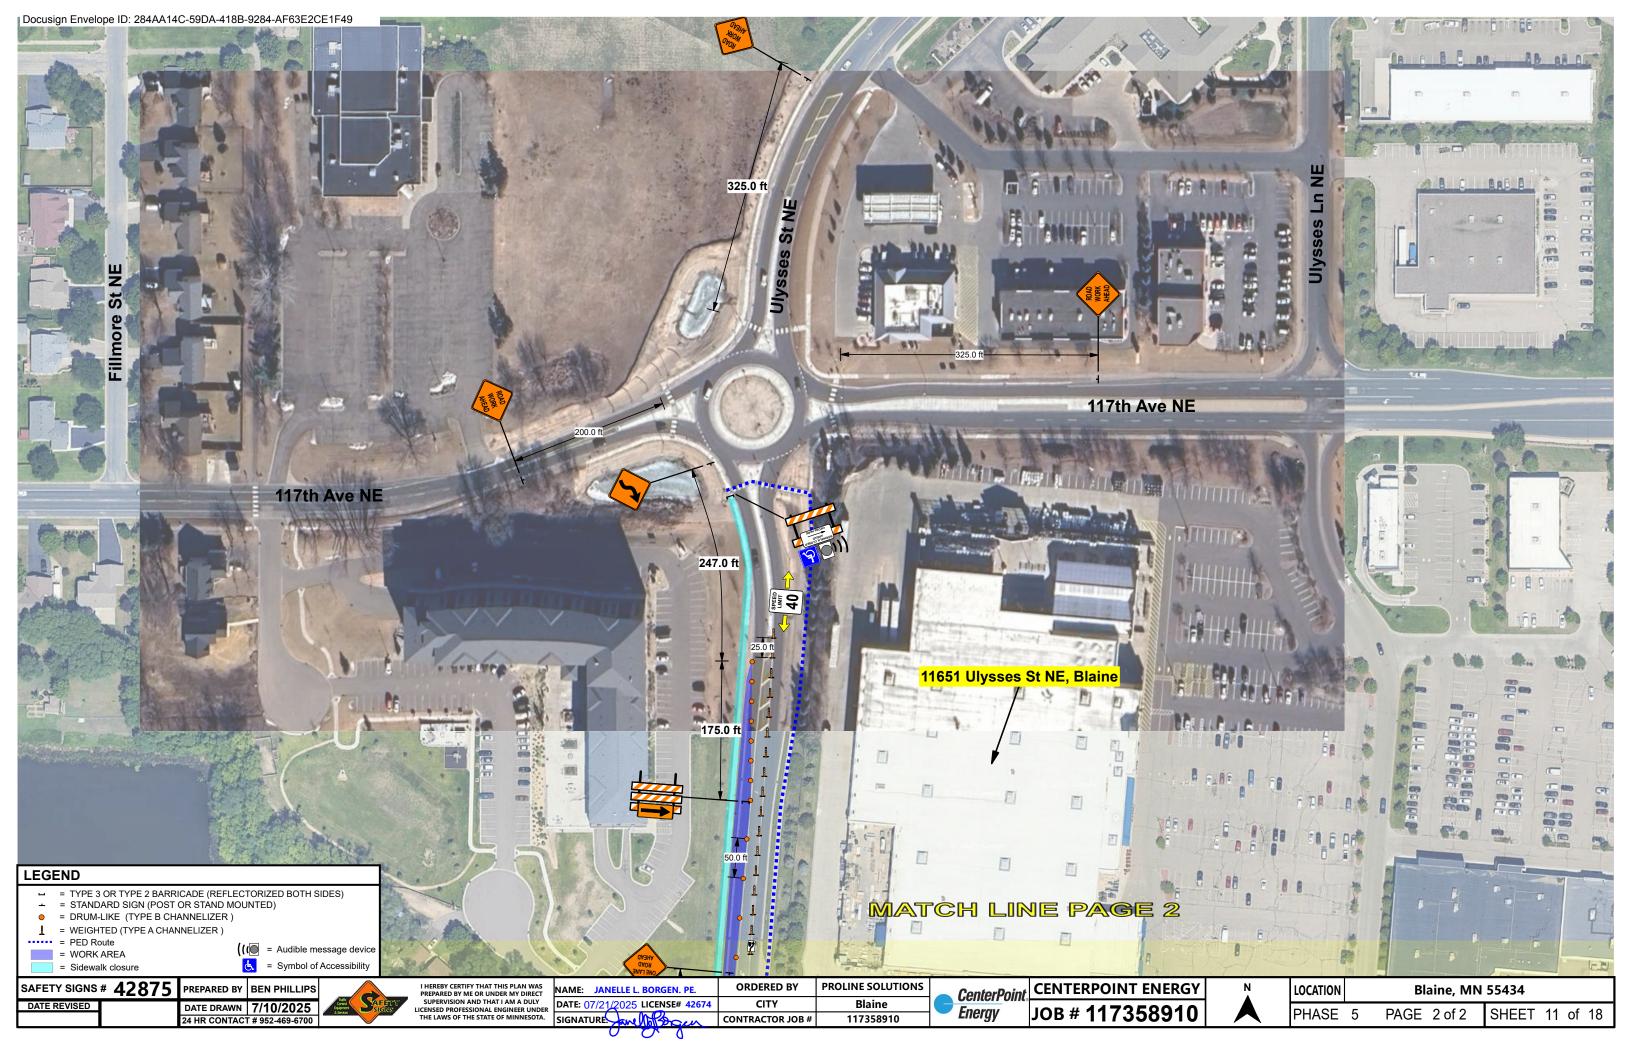


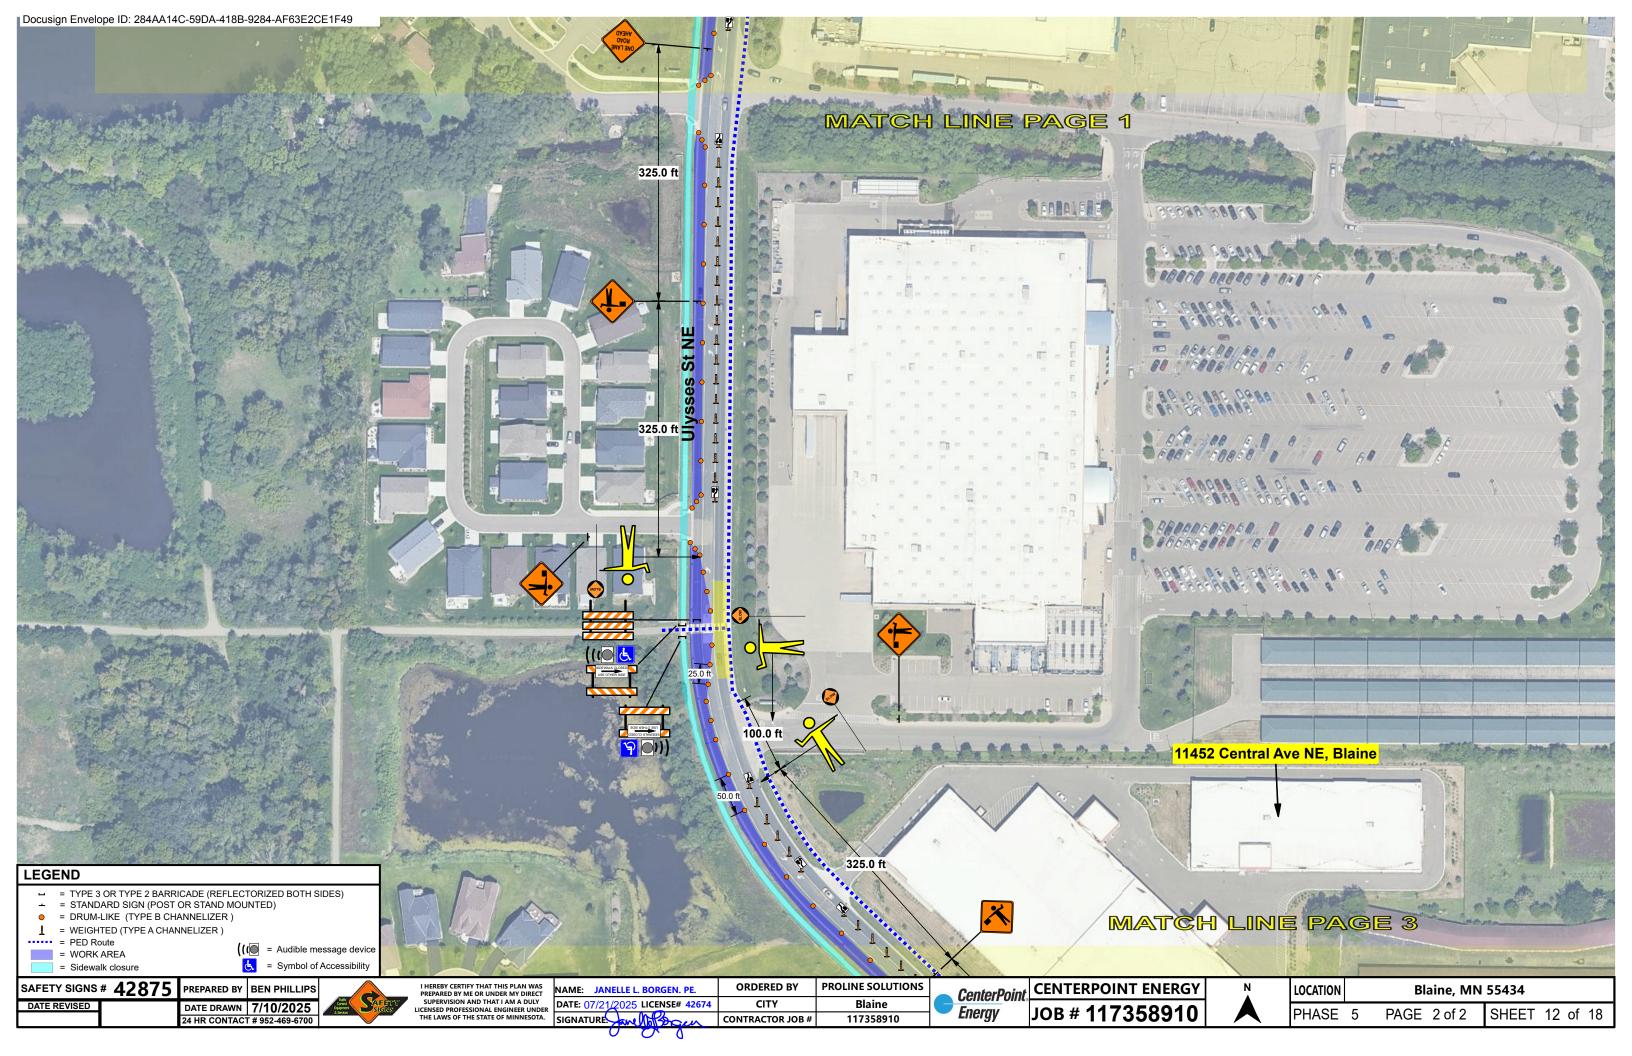


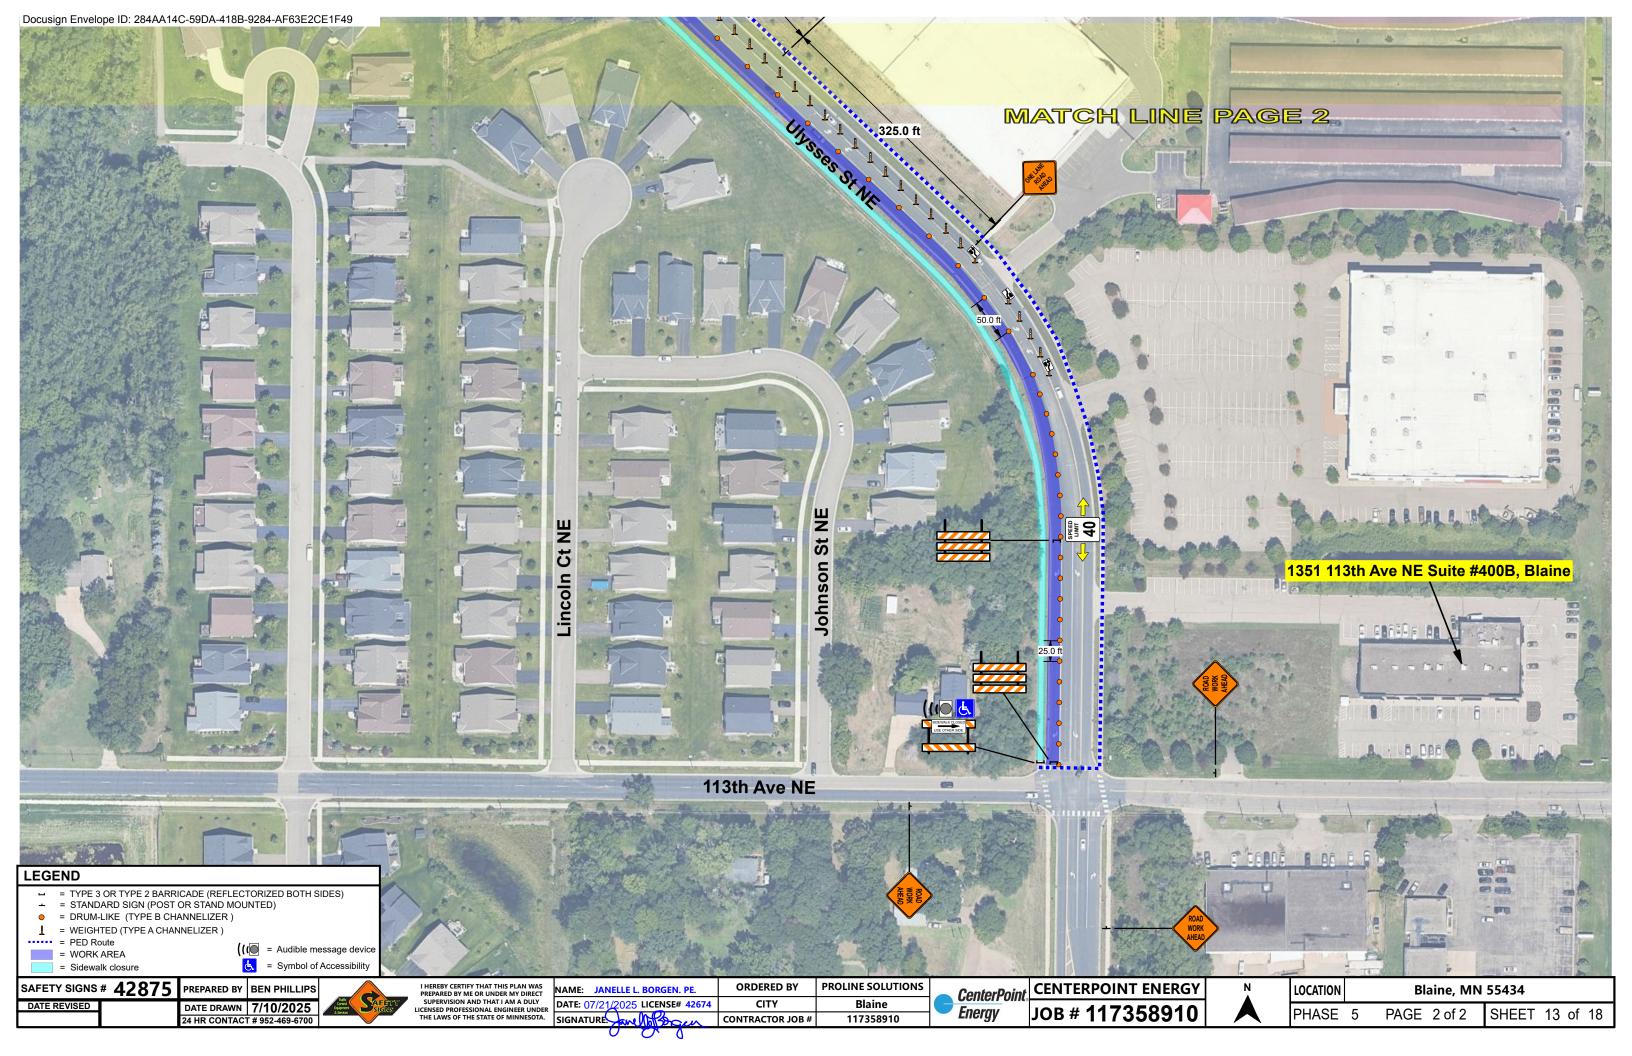


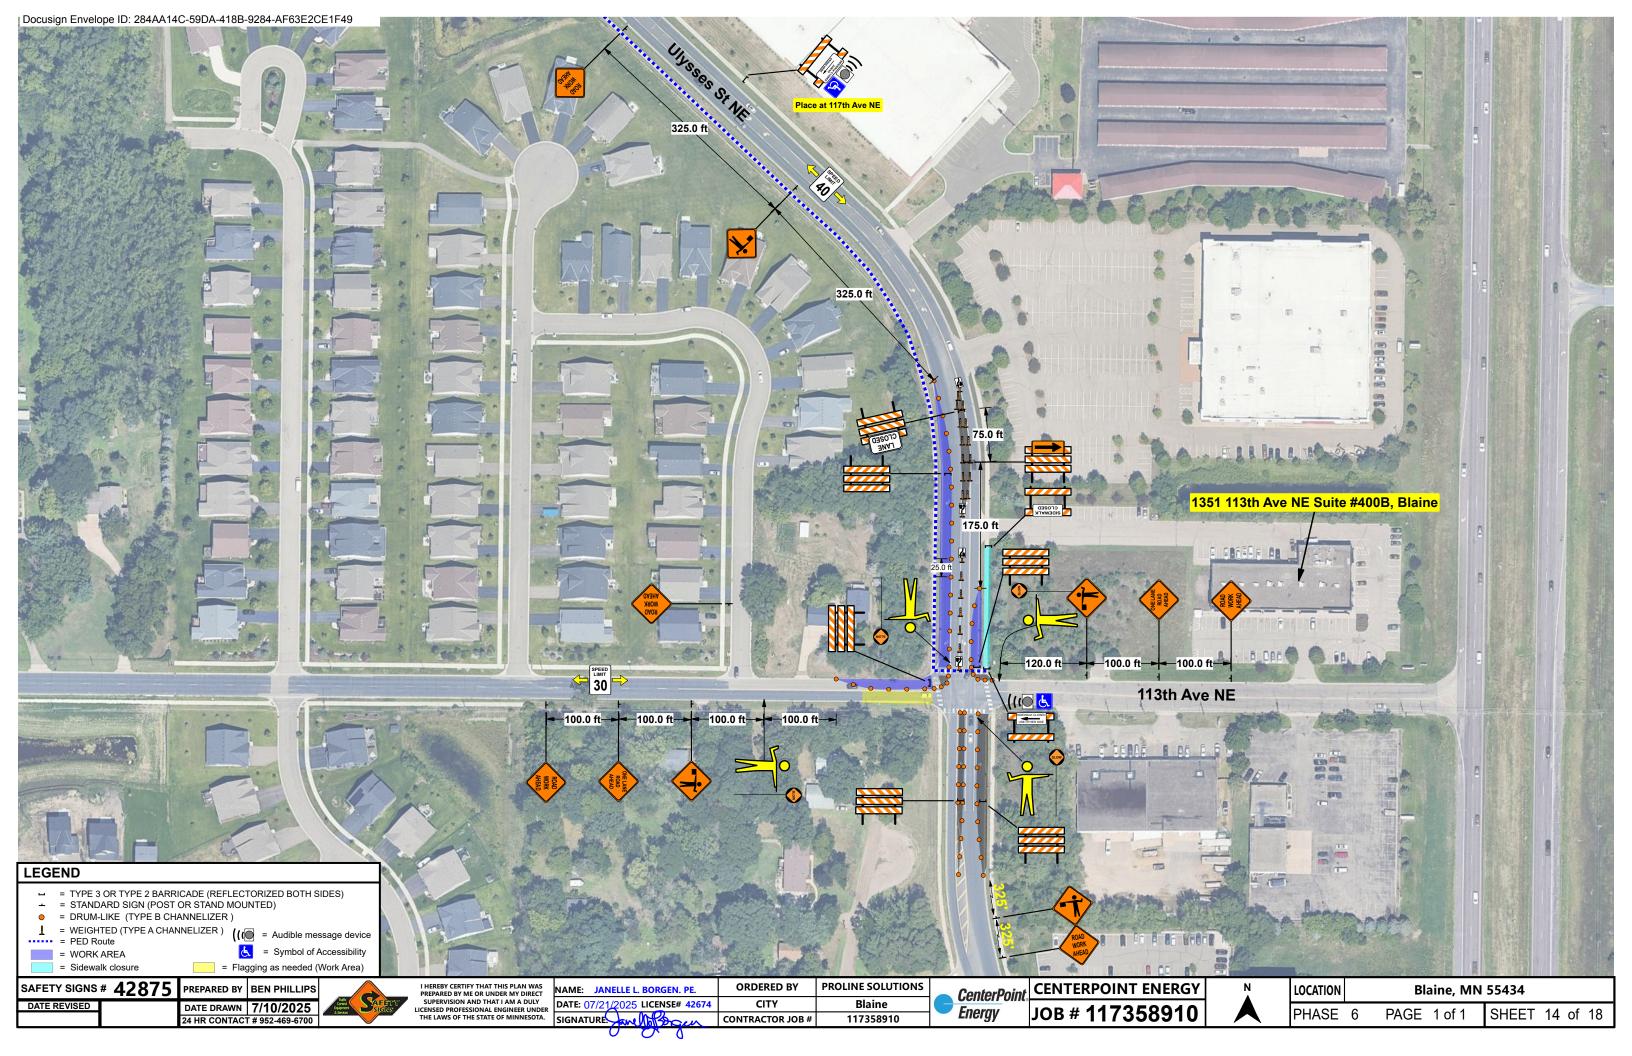


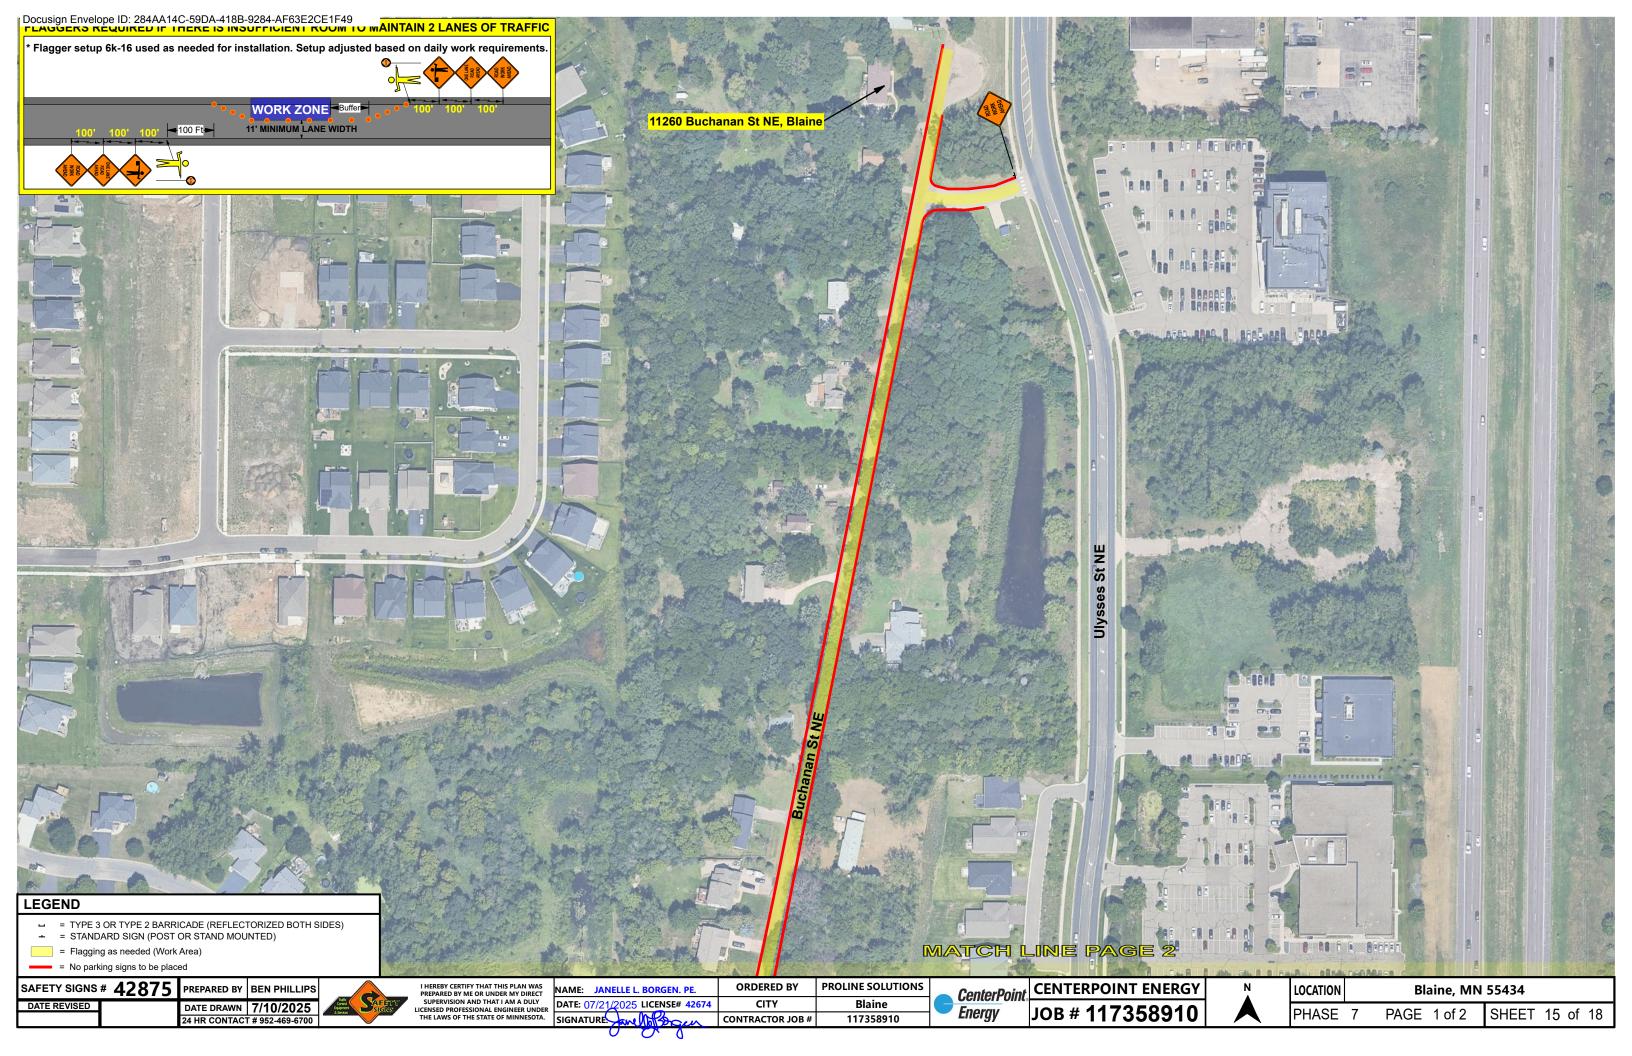


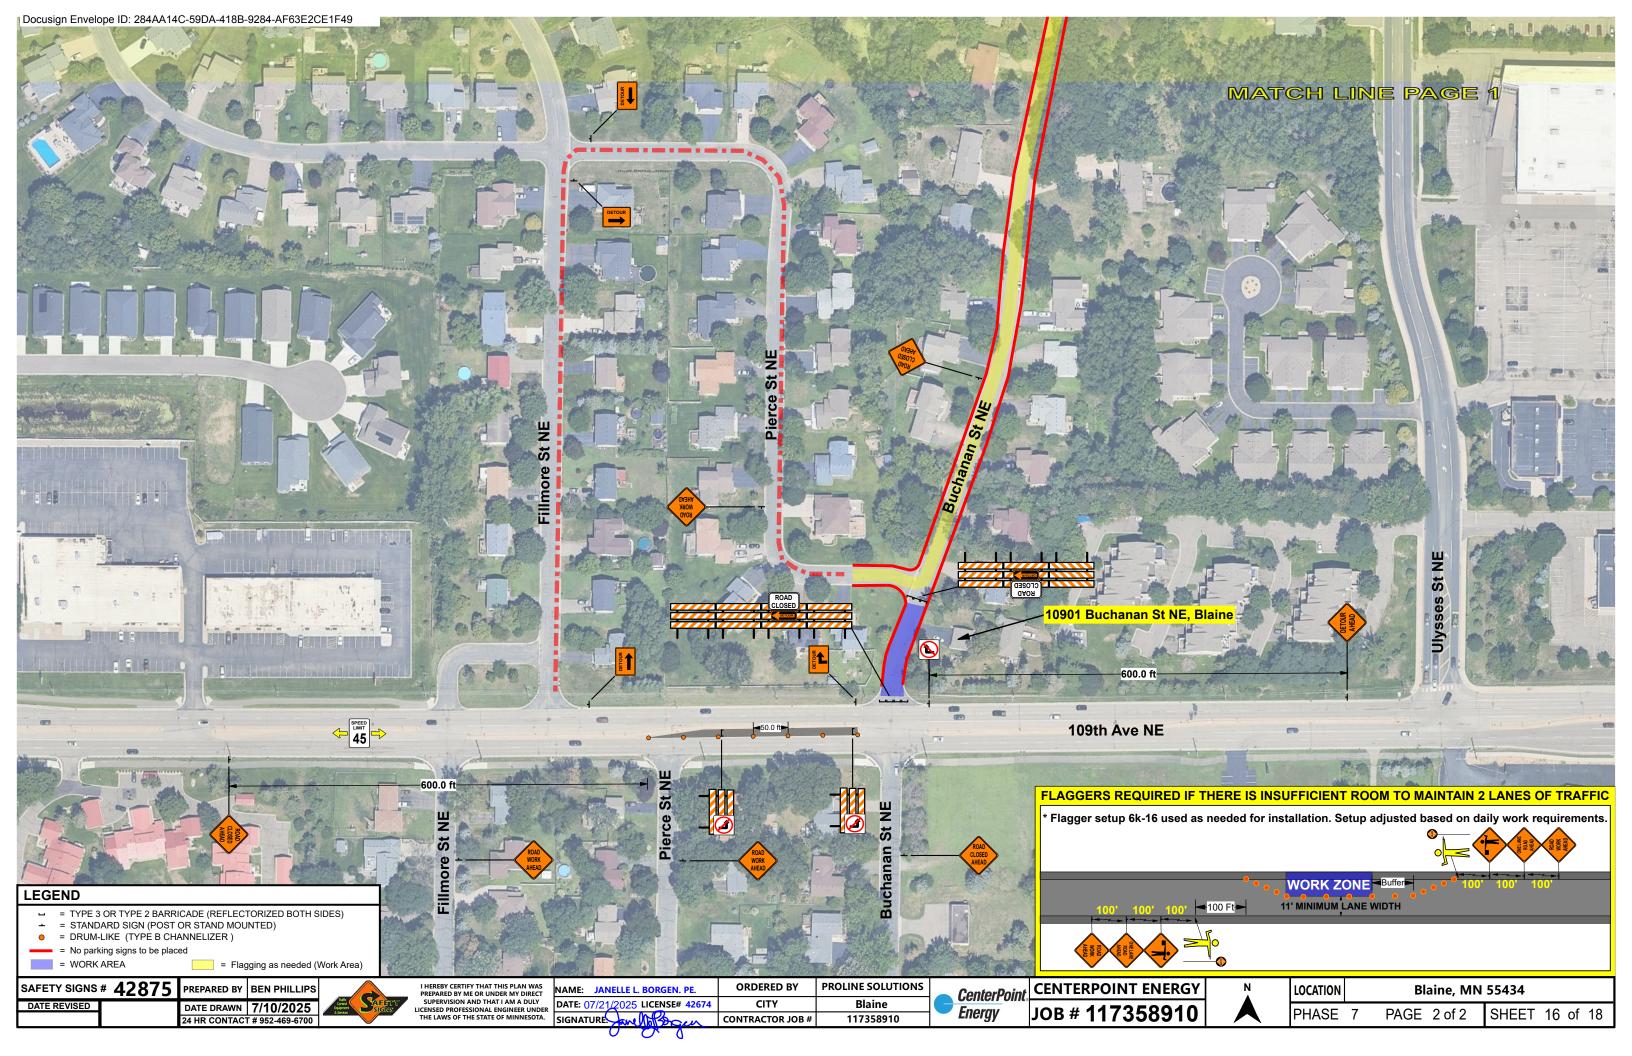


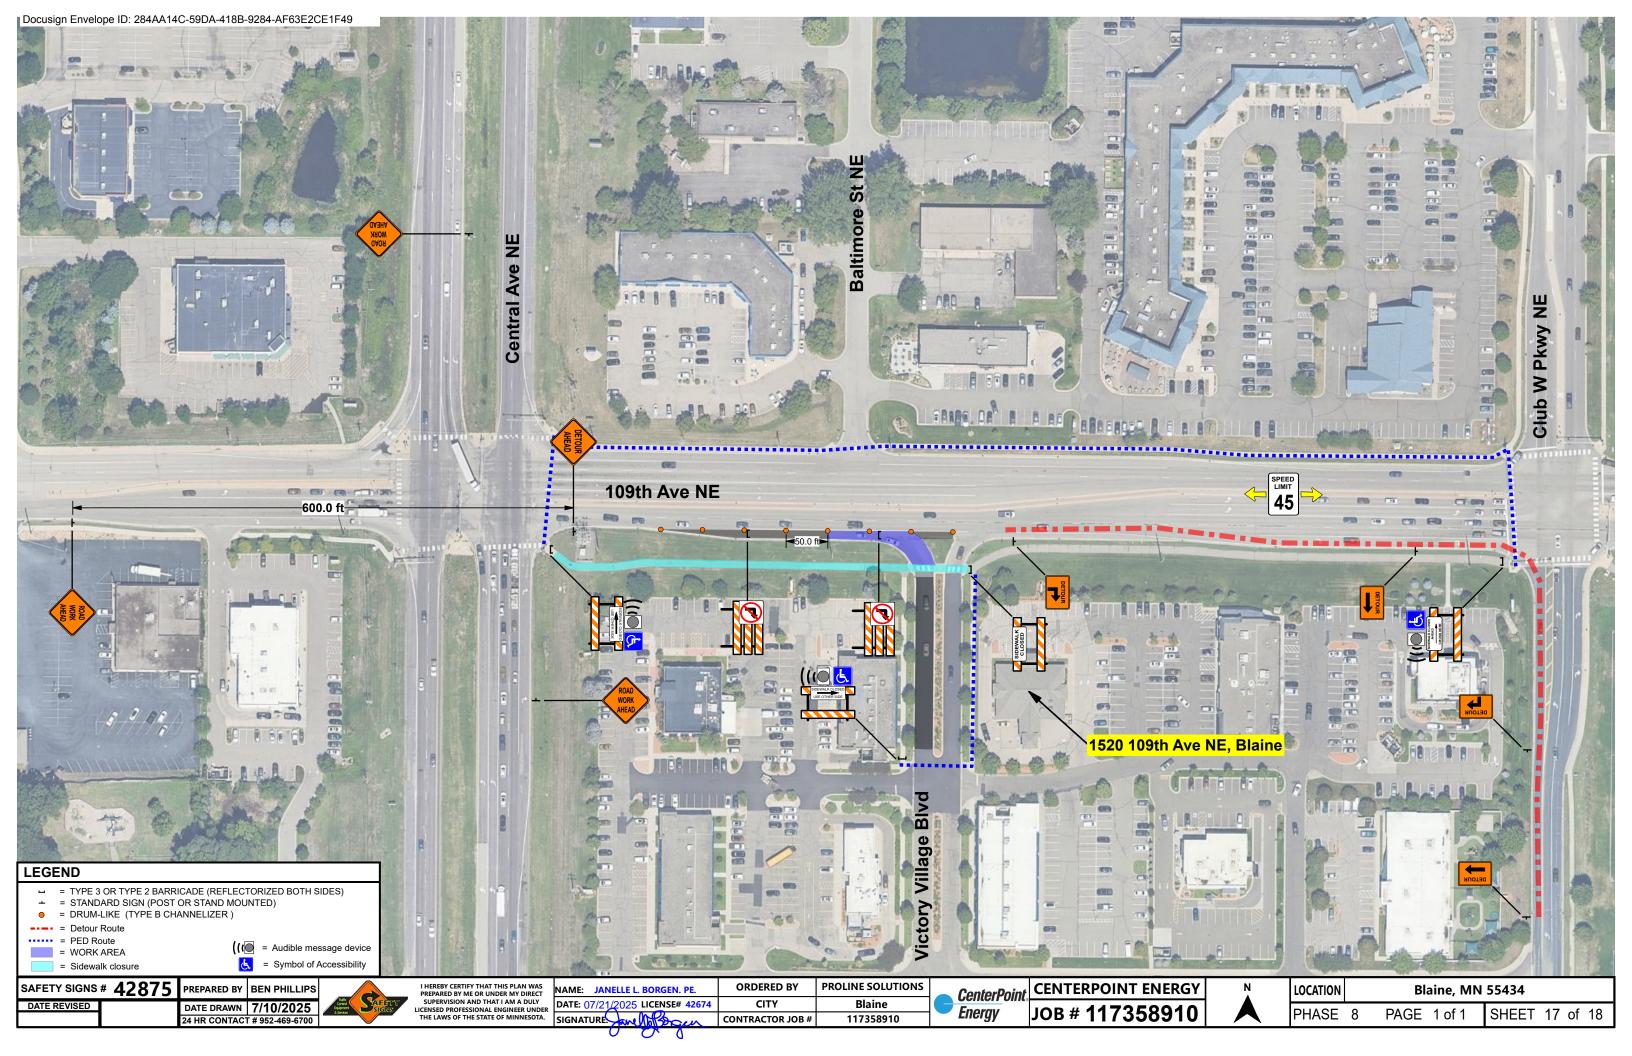

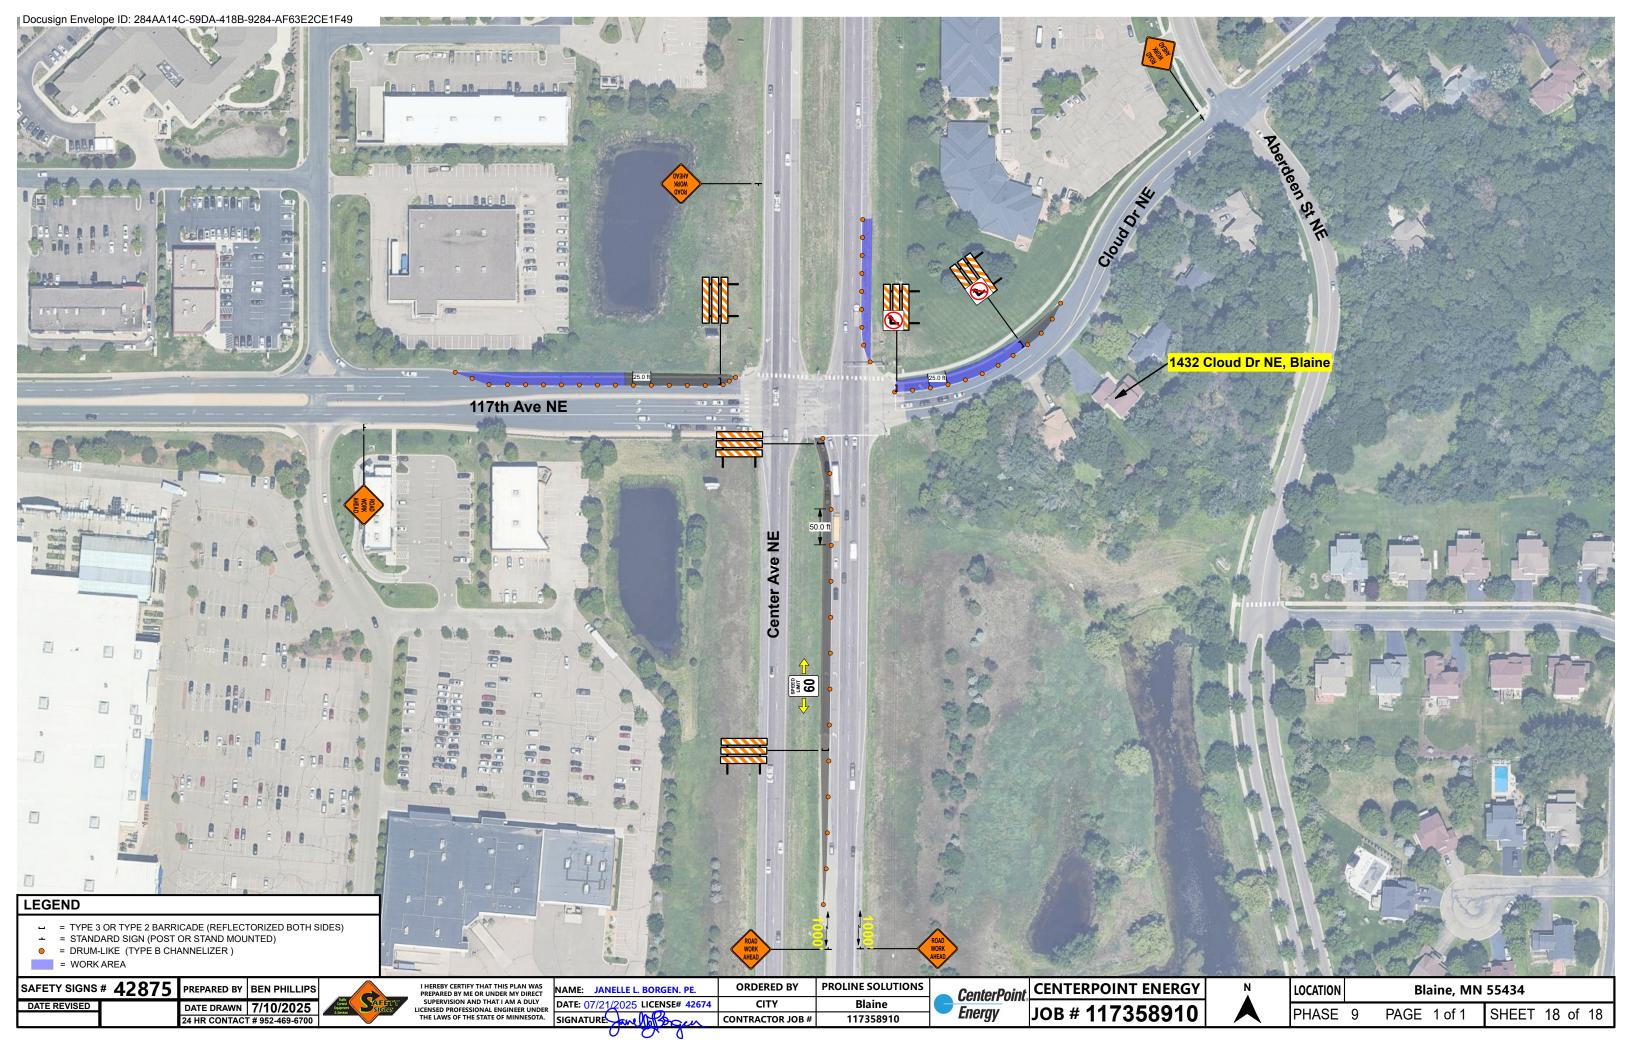

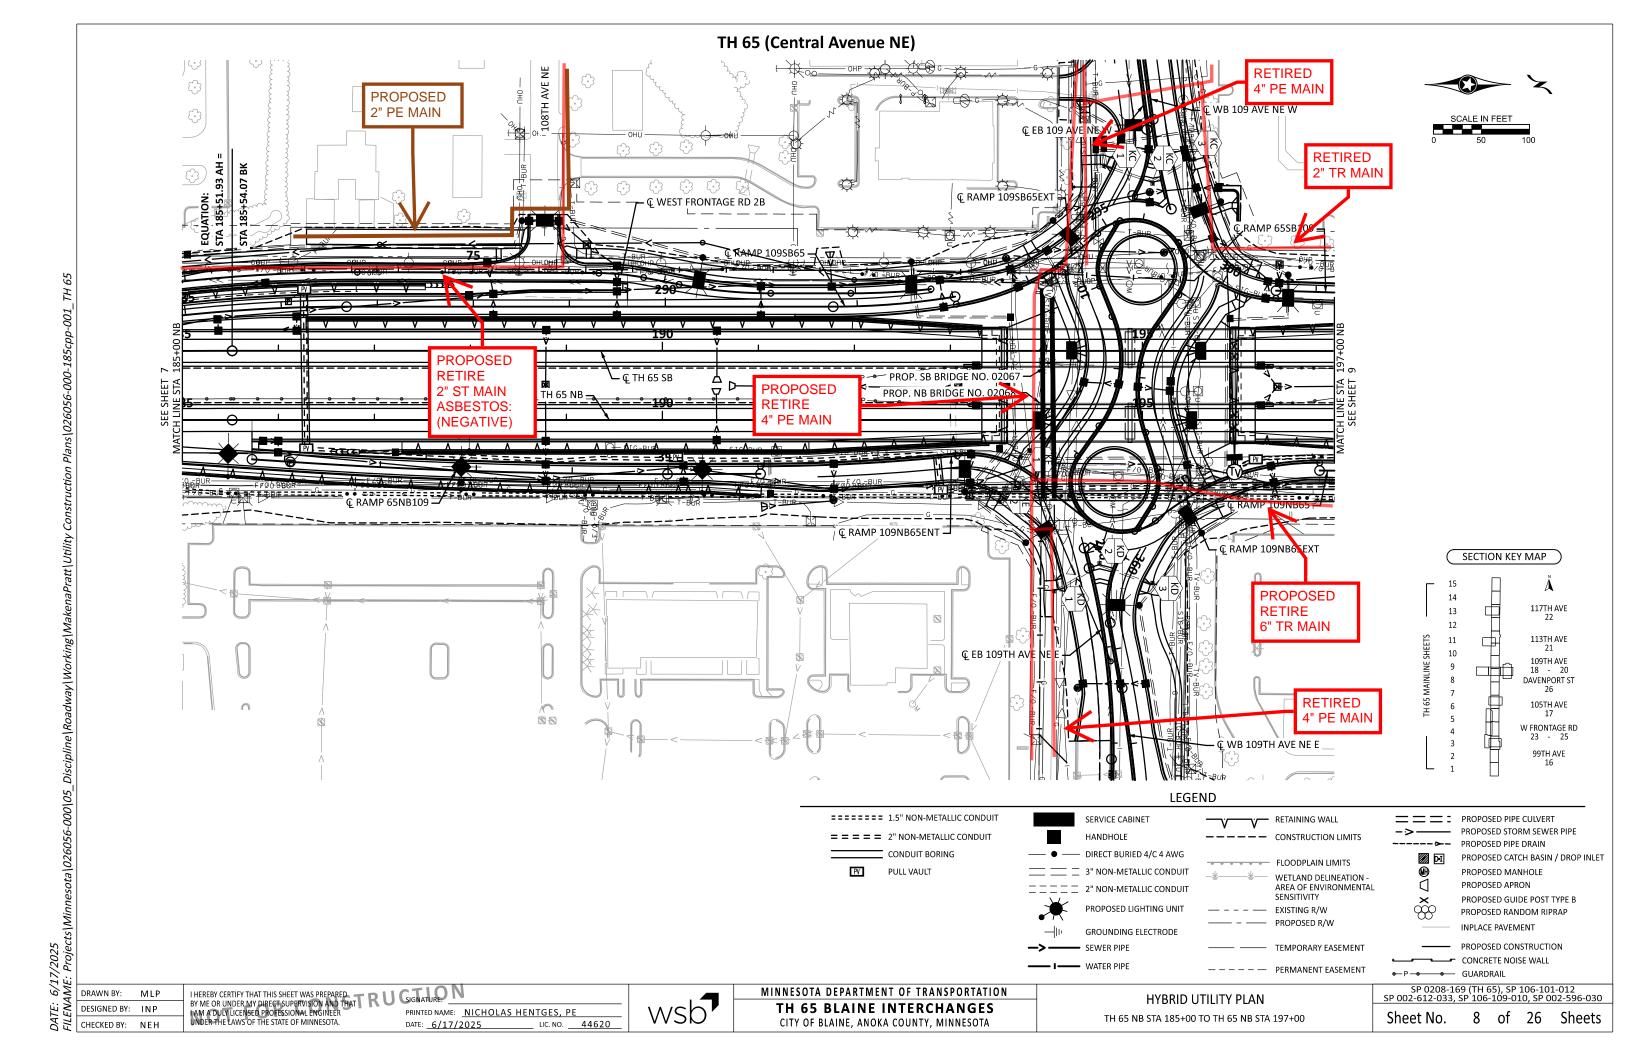

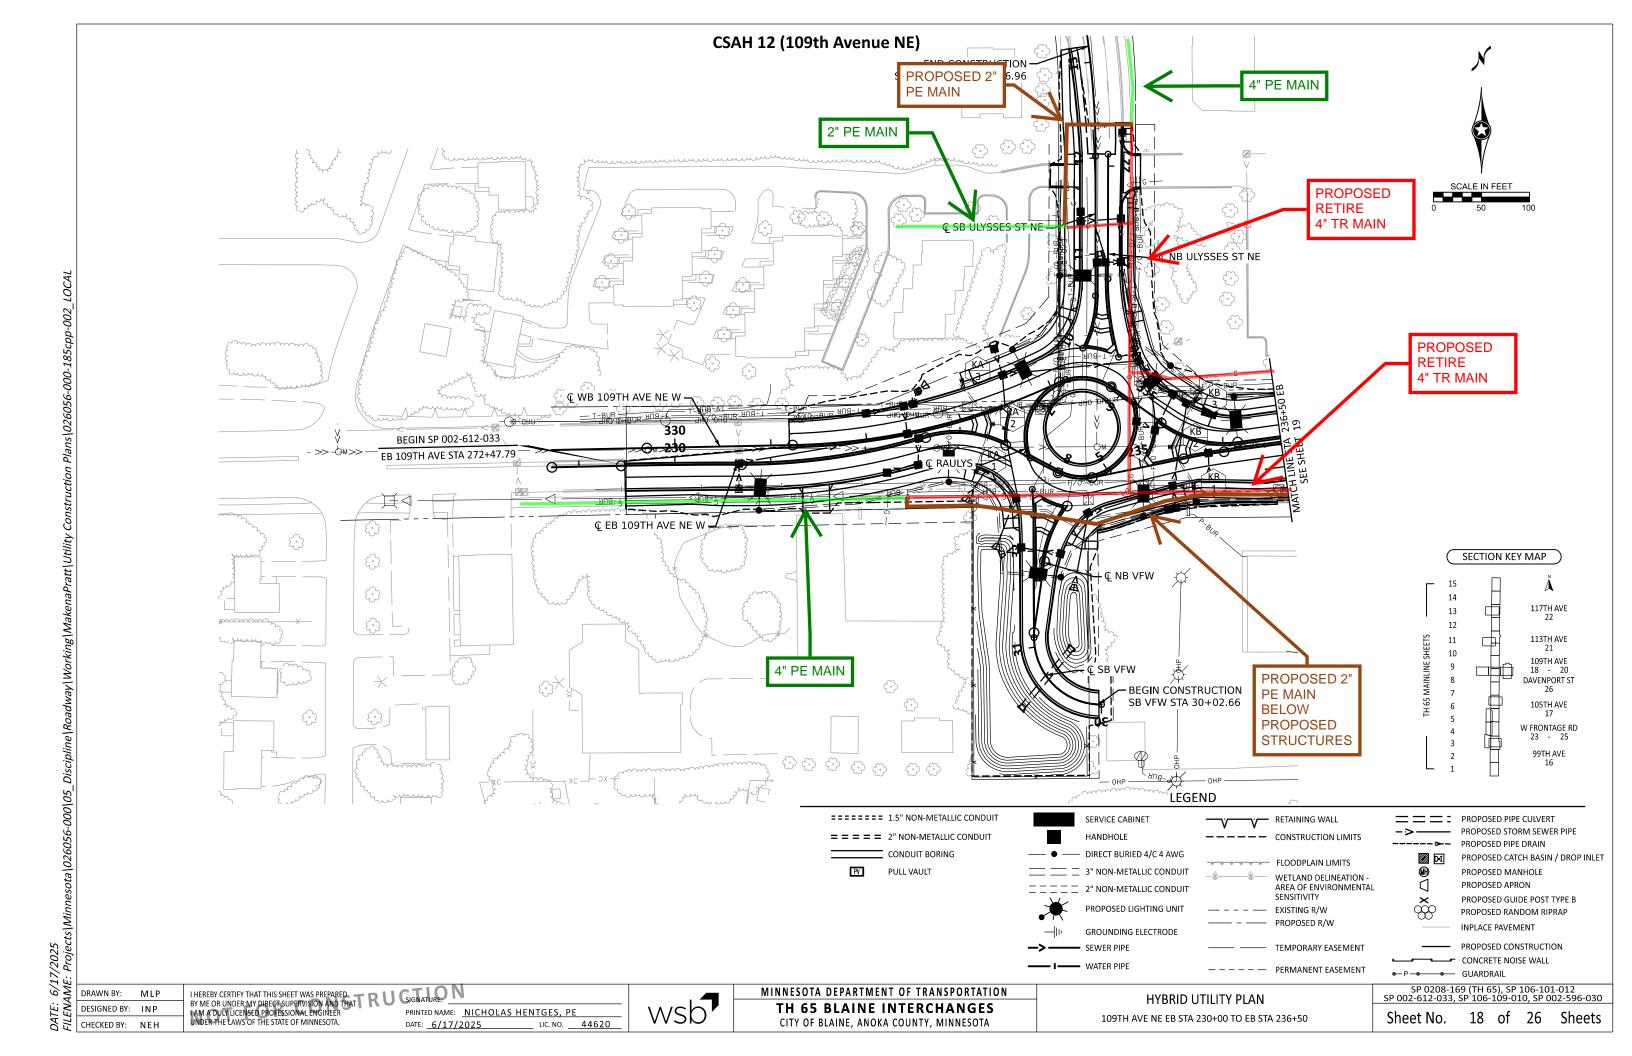

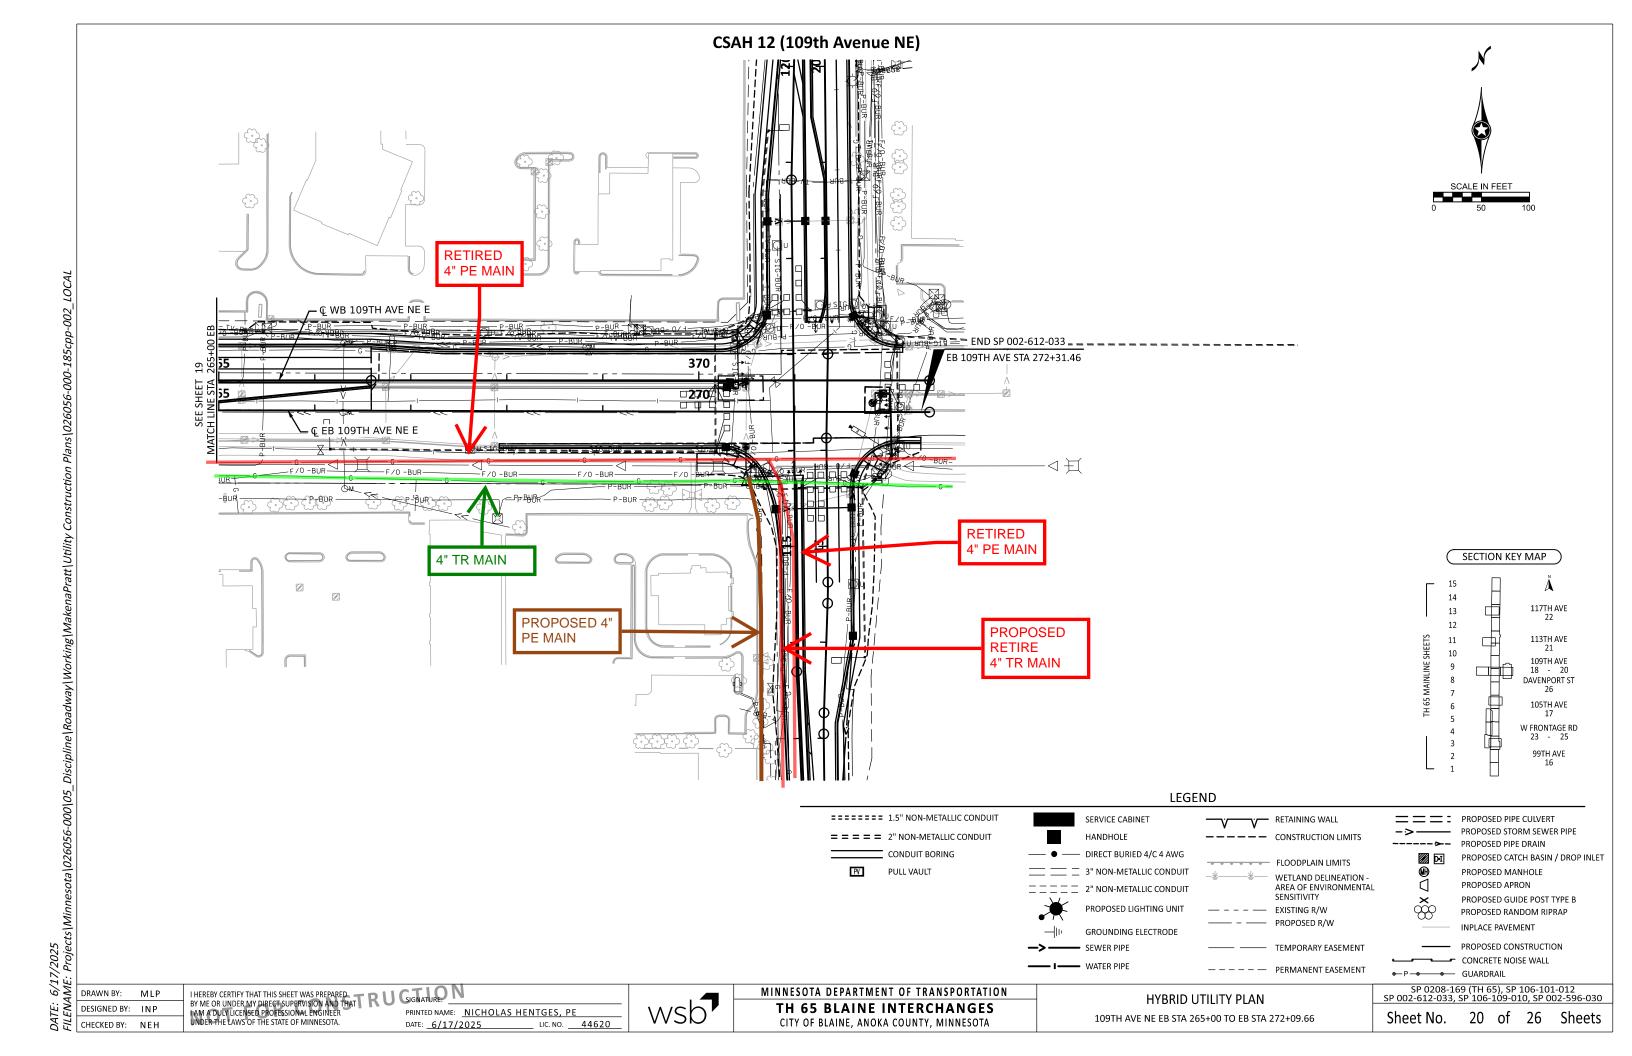



**Certificate Of Completion** 

Envelope Id: 284AA14C-59DA-418B-9284-AF63E2CE1F49

Subject: Desiree Tienter - ROW Permit Application

Source Envelope:

Document Pages: 32 Signatures: 1 **Envelope Originator:** Initials: 1 Certificate Pages: 4 **Highway Permits** 

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highwaypermits@anokacountymn.gov

IP Address: 158.81.13.145

**Record Tracking** 

Status: Original

8/11/2025 11:55:11 AM

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desiree.tienter@centerpointenergy.com

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Susan Burgmeier

Susan.Burgmeier@anokacountymn.gov

Associate Traffic Technician

**Anoka County** 

Signing Group: Highway Permits

Security Level: Email, Account Authentication

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**Electronic Record and Signature Disclosure:** 

Accepted: 7/28/2025 7:54:59 AM

ID: c16d1b4b-7911-43c9-9382-b38bc1578d7d

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desiree.tienter@centerpointenergy.com

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